



# DANE COUNTY CAPITOL SQUARE SOUTH PARKING RAMP

REQUEST FOR BID NO. 317022

# HEATING & VENTILATING EQUIPMENT REPLACEMENT

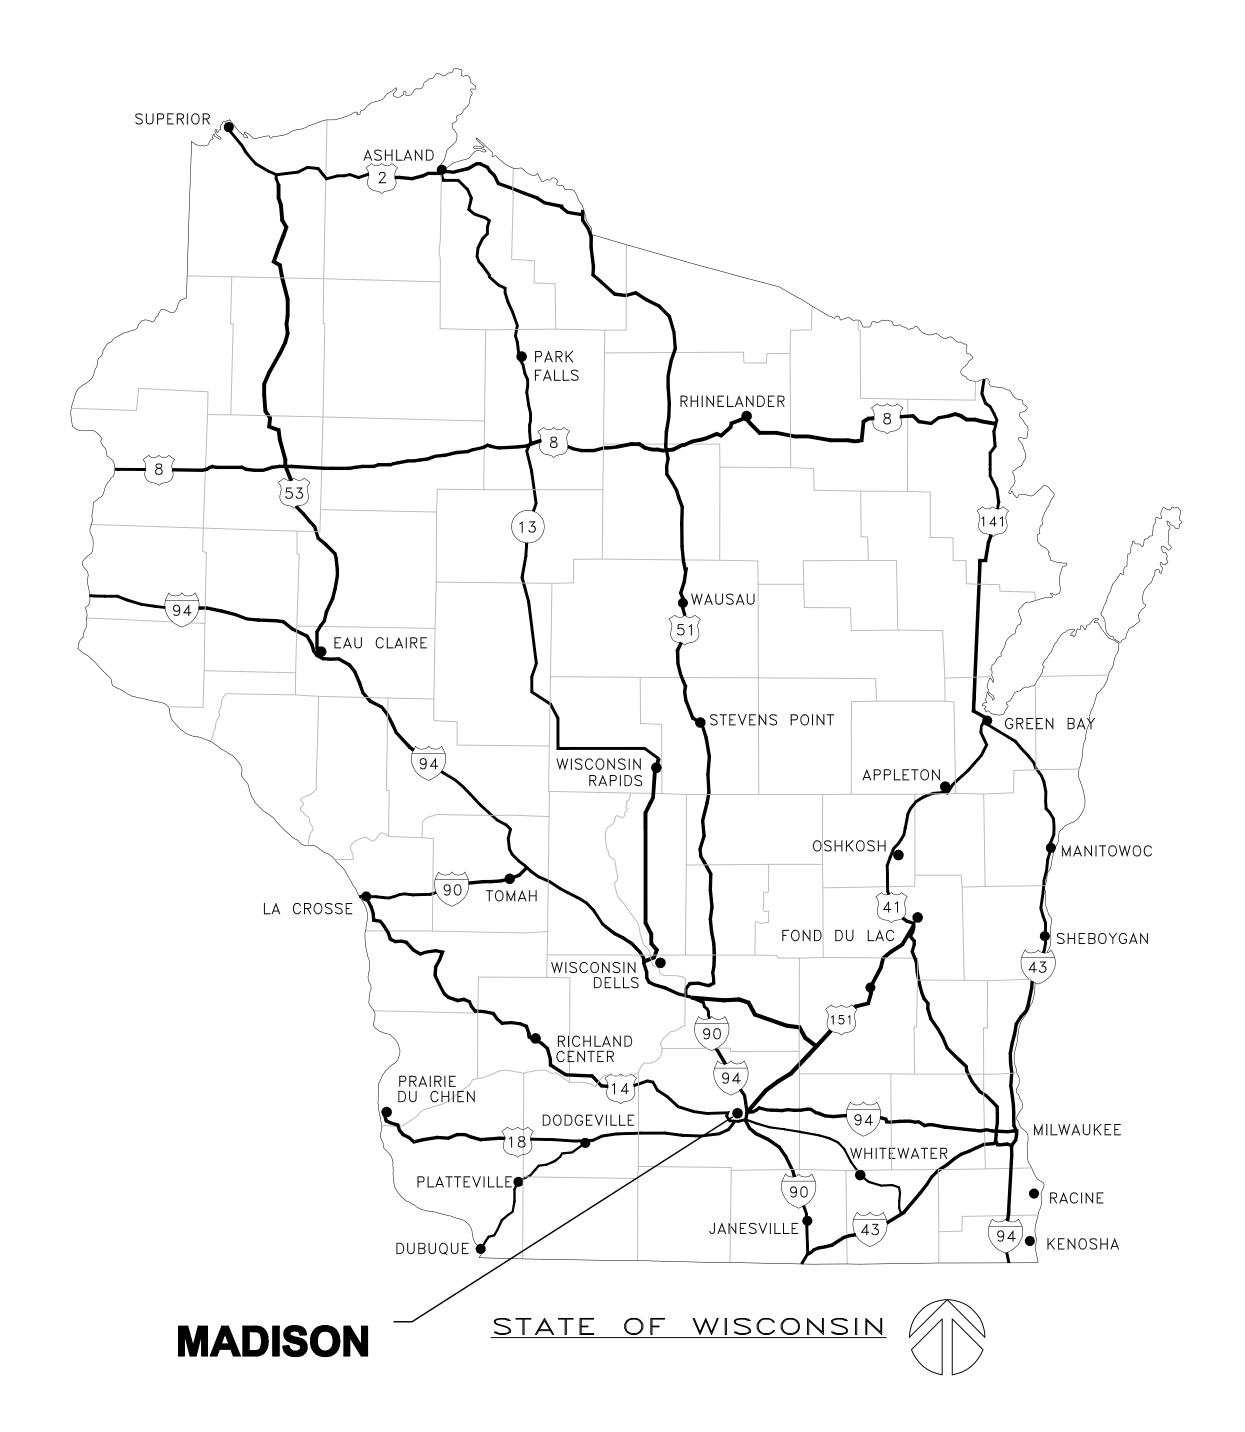

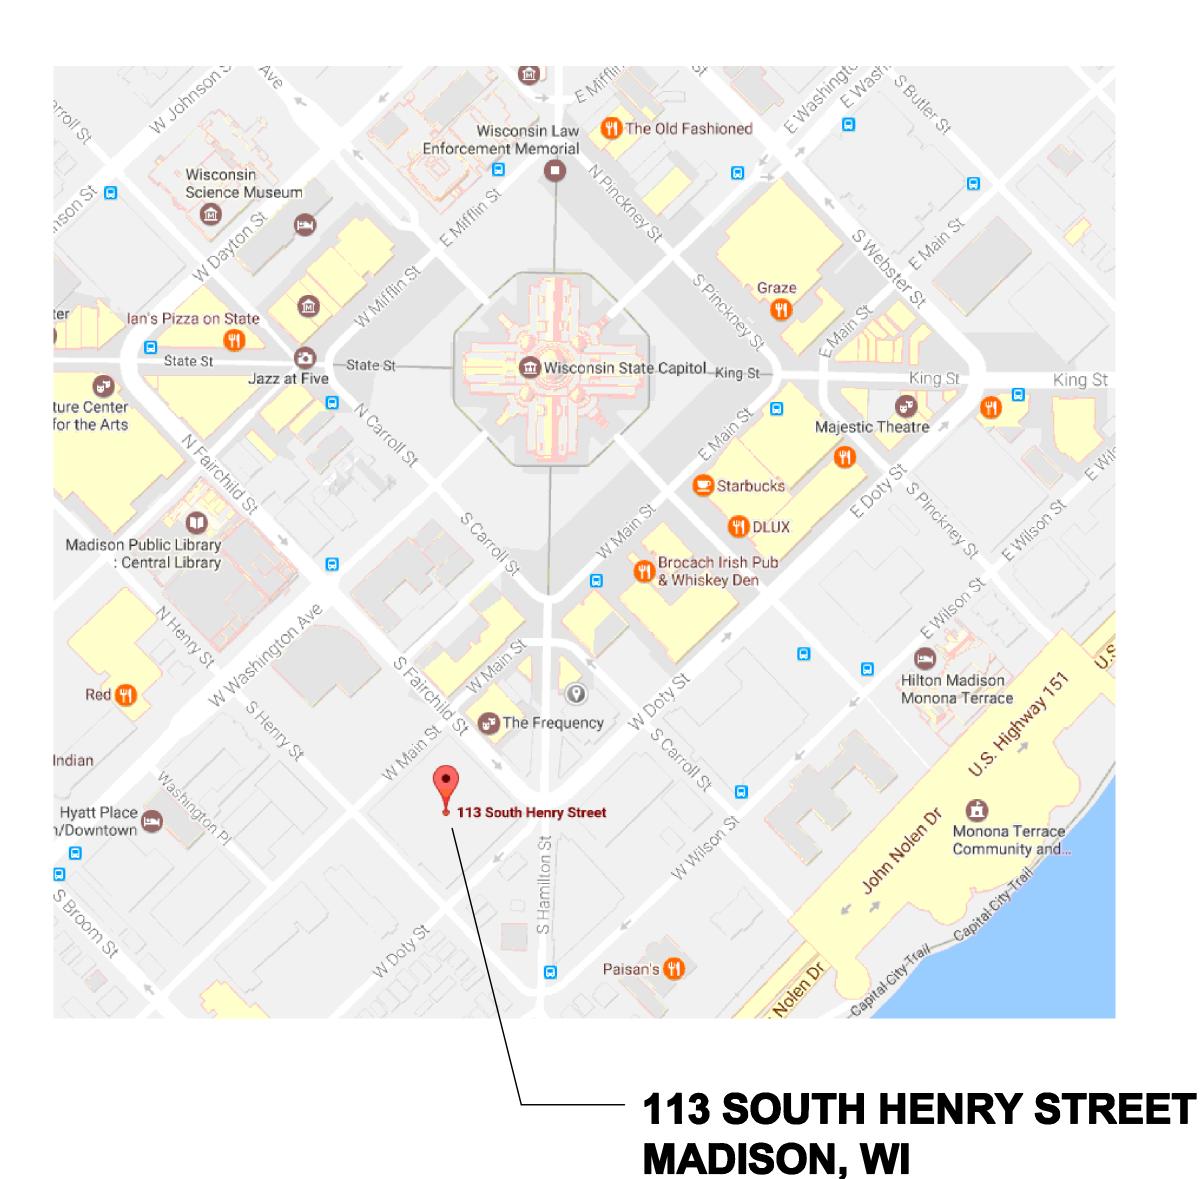

## **SHEET INDEX**

T100 TITLE SHEET

H100 BASEMENT FLOOR PLAN - DEMOLITION AND NEW WORK

H101 MECHANICAL ROOM FLOOR PLANS - DEMOLITION AND NEW WORK

H200 HVAC SCHEDULES AND DETAILS

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**Project No. 17-0505** 

Dane County Department of Public Works,
Highway and Tranportation
Public Works Engineering Division
1919 Alliant Energy Center Way

Notes:

7/25/17 ISSUED FOR CONSTRUCTION
Date Issuance/Revisions Sym

DANE COUNTY
CAPITOL SQUARE
SOUTH RAMP
REQUEST FOR BID NO. 317022

HEATING & VENTILATING EQUIPMENT REPLACEMENT


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TITLE SHEET

T100



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HEATING & VENTILATING **EQUIPMENT REPLACEMENT** 

113 SOUTH HENRY STREET MADISON, WI
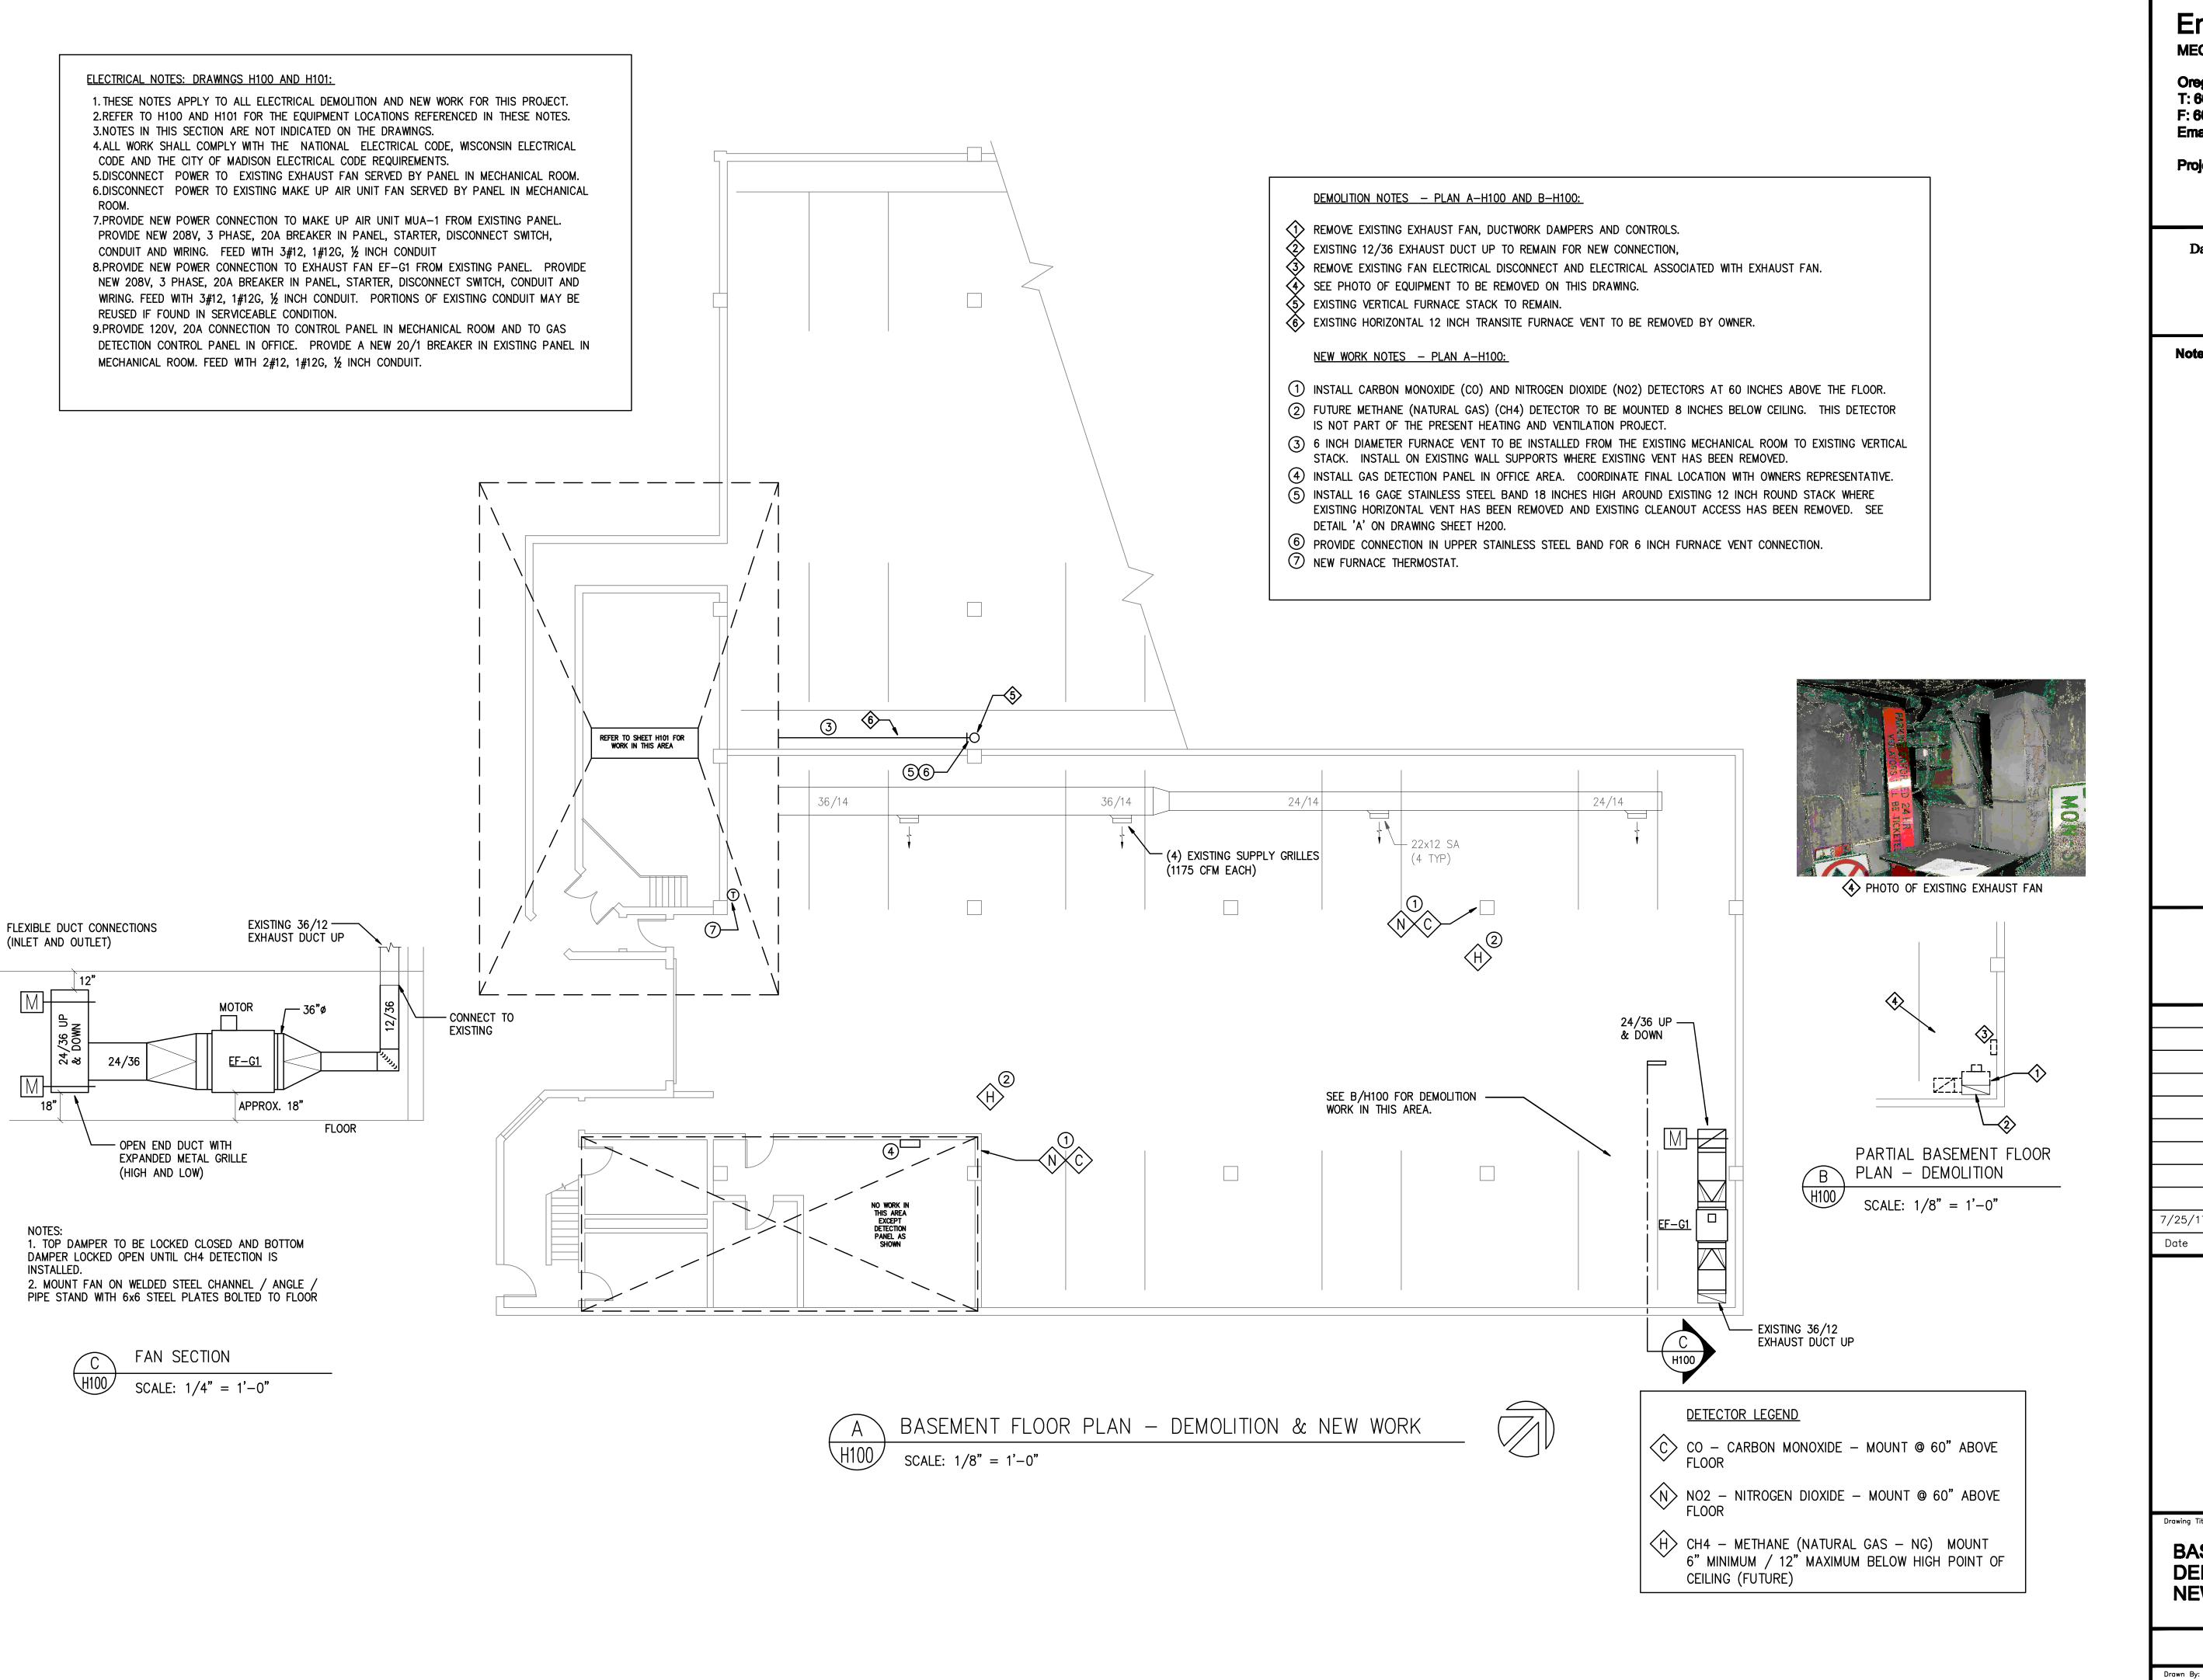
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**BASEMENT FLOOR PLAN -DEMOLITION AND NEW WORK** 

H100

<u>DEMOLITION WORK NOTES - PLAN B-H101:</u>

REMOVE EXISTING GAS FIRED HEATING UNIT.

2 REMOVE GAS PIPING FROM TEE IN DROP TO HEATING UNIT.

3 EXISTING GAS METER TO REMAIN

REMOVE DAMPER ACTUATOR. (DAMPER TO REMAIN, NEW ACTUATOR TO BE INSTALLED)

\$\sqrt{5}\ \text{REMOVE RETURN DUCT FROM FLEXIBLE CONNECTOR TO UNIT (SEE NEW UNIT ELEVATION)

6 OUTSIDE AIR DUCT TO REMAIN.

RETURN AIR DUCT AND RETURN GRILLE TO REMAIN.

® REMOVE UNIT BURNER VENT DUCT TO CONNECTION TO TRANSITE PIPE.

The string unit disconnect switch. Remove wiring and conduit from switch to unit.


SUPPLY AIR DUCT TO REMAIN.

ELECTRICAL PANELS TO REMAIN.

TRANSITE PIPE (HEATING UNIT VENT) TO BE REMOVED BY OWNER.

(3) EXHAUST FAN TO REMAIN UNALTERED.

REMOVE LOUVER.

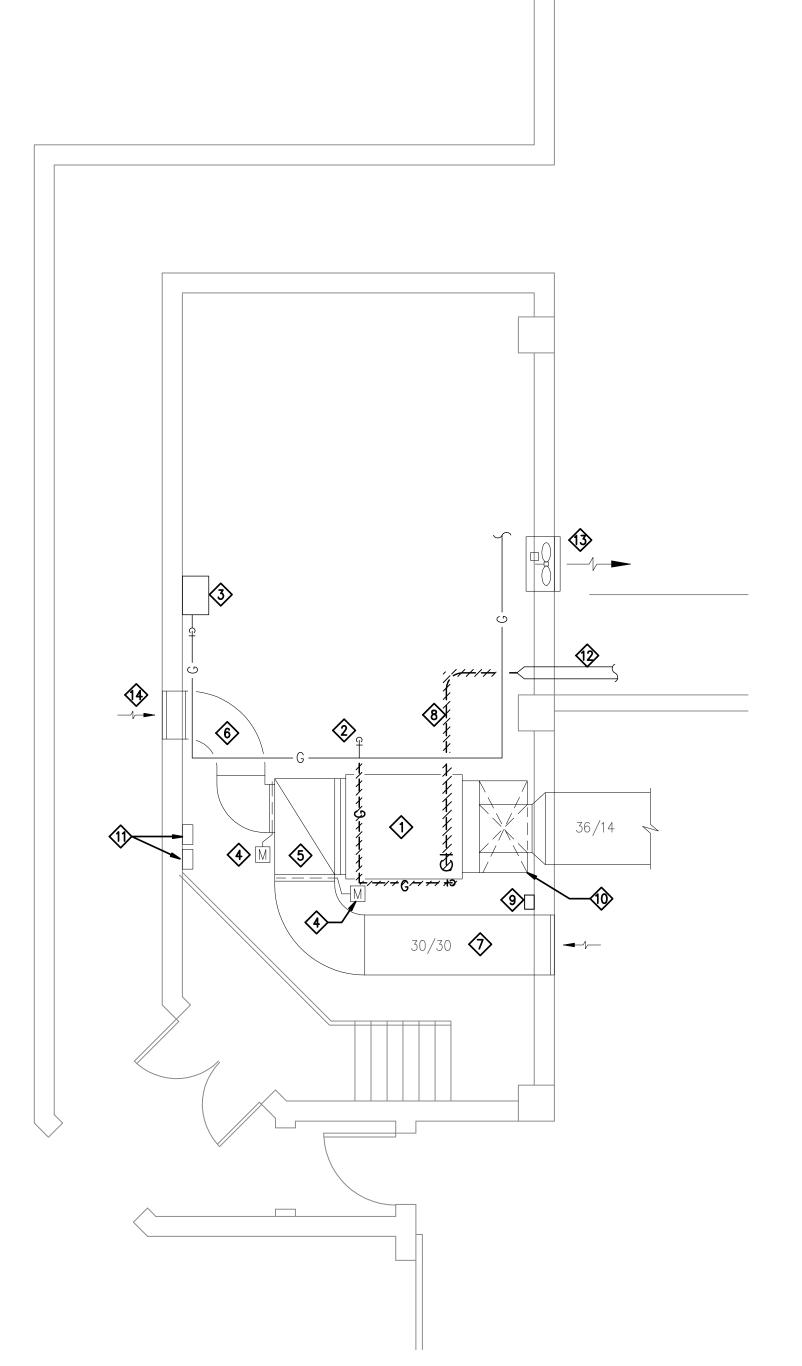



SCALE: 1/4" = 1'-0"

MECHANICAL ROOM FLOOR PLAN - DEMOLITION



#### ELECTRICAL NOTES: DRAWINGS H100 AND H101:

1. THESE NOTES APPLY TO ALL ELECTRICAL DEMOLITION AND NEW WORK FOR THIS PROJECT. 2. REFER TO H100 AND H101 FOR THE EQUIPMENT LOCATIONS REFERENCED IN THESE NOTES. 3. NOTES IN THIS SECTION ARE NOT INDICATED ON THE DRAWINGS.


4. ALL WORK SHALL COMPLY WITH THE NATIONAL ELECTRICAL CODE, WISCONSIN ELECTRICAL CODE AND THE CITY OF MADISON ELECTRICAL CODE REQUIREMENTS.

5. DISCONNECT POWER TO EXISTING EXHAUST FAN SERVED BY PANEL IN MECHANICAL ROOM. 6. DISCONNECT POWER TO EXISTING MAKE UP AIR UNIT FAN SERVED BY PANEL IN MECHANICAL ROOM.

7. PROVIDE NEW POWER CONNECTION TO MAKE UP AIR UNIT MUA-1 FROM EXISTING PANEL. PROVIDE NEW 208V, 3 PHASE, 20A BREAKER IN PANEL, STARTER, DISCONNECT SWITCH, CONDUIT AND WIRING. FEED WITH 3#12, 1#12G, 1/2 INCH CONDUIT


8. PROVIDE NEW POWER CONNECTION TO EXHAUST FAN EF-G1 FROM EXISTING PANEL. PROVIDE NEW 208V, 3 PHASE, 20A BREAKER IN PANEL, STARTER, DISCONNECT SWITCH, CONDUIT AND WIRING. FEED WITH 3#12, 1#12G, 1/2 INCH CONDUIT. PORTIONS OF EXISTING CONDUIT MAY BE REUSED IF FOUND IN SERVICEABLE CONDITION.

9. PROVIDE 120V, 20A CONNECTION TO CONTROL PANEL IN MECHANICAL ROOM AND TO GAS DETECTION CONTROL PANEL IN OFFICE. PROVIDE A NEW 20/1 BREAKER IN EXISTING PANEL IN MECHANICAL ROOM. FEED WITH 2#12, 1#12G, ½ INCH CONDUIT.

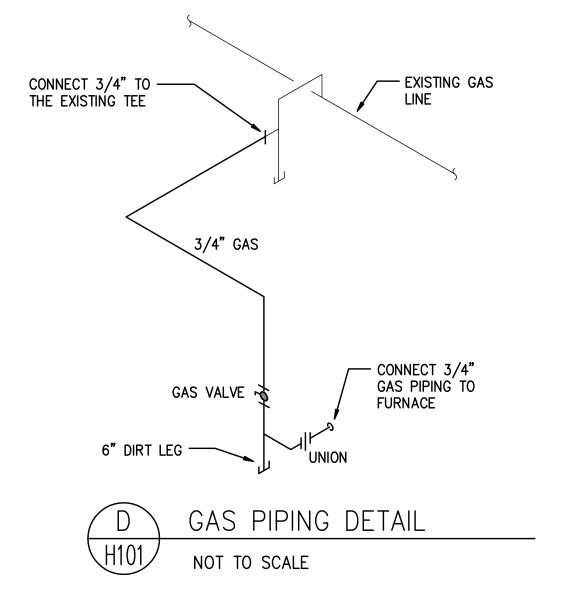

#### NEW WORK NOTES - SECTION C-H101:


- (12) EXISTING 18/46 SUPPLY DUCT
- (3) CONNECT UNIT 19/46 UNIT OUTLET TO EXISTING
- (4) SET UNIT HEIGHT TO MATCH UNIT OUTLET TO THE EXISTING SUPPLY DUCT.
- (5) CONNECT 19/51.5 TO UNIT INTAKE.
- (16) BLANK OFF PORTION OF THE MIXED AIR DUCT.
- 17 6"ø VENT CONNECTION TO VENT FAN.
- (18) SUSPEND UNIT FROM STRUCTURE.

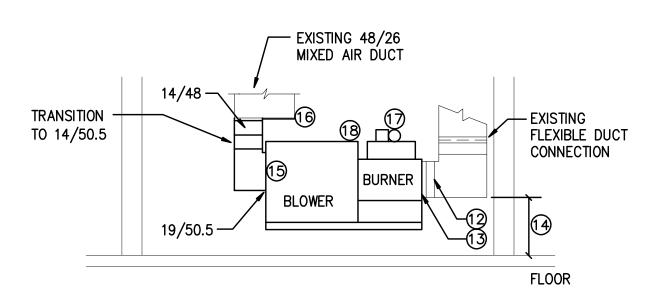

SECTION OF BLOWER UNIT SCALE: 1/4" = 1'-0"

#### NEW WORK NOTES - PLAN A-H101:

- ① CONNECT 6 INCH TO UNIT BURNER POWER VENT FAN WITH 6" DOUBLE WALL PRESSURE VENT.
- 2 RUN VENT THROUGH WALL AT REMOVED VENT. PROVIDE SHEET METAL TO ENCLOSE OPENING BETWEEN NEW VENT AND CONCRETE WALL, EACH SIDE OF WALL.
- 3 CONNECT 3/4" INCH GAS PIPING TO EXISTING TEE AT REMOVED GAS LINE, RUN AND CONNECT TO FURNACE. REFER TO GAS PIPING DETAIL.
- 4 NEW BLOWER UNIT AND GAS FIRED FURNACE UNIT. INSTALL IN LOCATION OF REMOVED UNIT. REFER TO UNIT ELEVATION DETAIL.
- 5 INSTALL NEW DAMPER ACTUATOR ON EXISTING DAMPER.
- (6) NEW UNIT ELECTRICAL DISCONNECT.
- 7 NEW UNIT TIME CLOCK AND VENTILATION CONTROL PANEL.
- (8) NEW LOUVER L-1 INSTALLED IN EXISTING OPENING. PROVIDE TAMPER PROOF SCREWS.
- 9 EXISTING NATURAL GAS METER.
- (1) EXISTING EXHAUST FAN.
- 1 EXISTING ELECTRICAL PANELS.
  - a. LEFT PANEL SERVES EXISTING FURNACE INDICATED ON PLAN B-H101 AND EXHAUST FAN INDICATED ON PLAN B-H100.
  - b. EXISTING EXHAUST FAN IS SERVED BY A 208V, 3 PHASE, 20A BREAKER c. EXISTING MAKEUP AIR UNIT IS SERVED BY A 208V, 3 PHASE, 20A BREAKER.

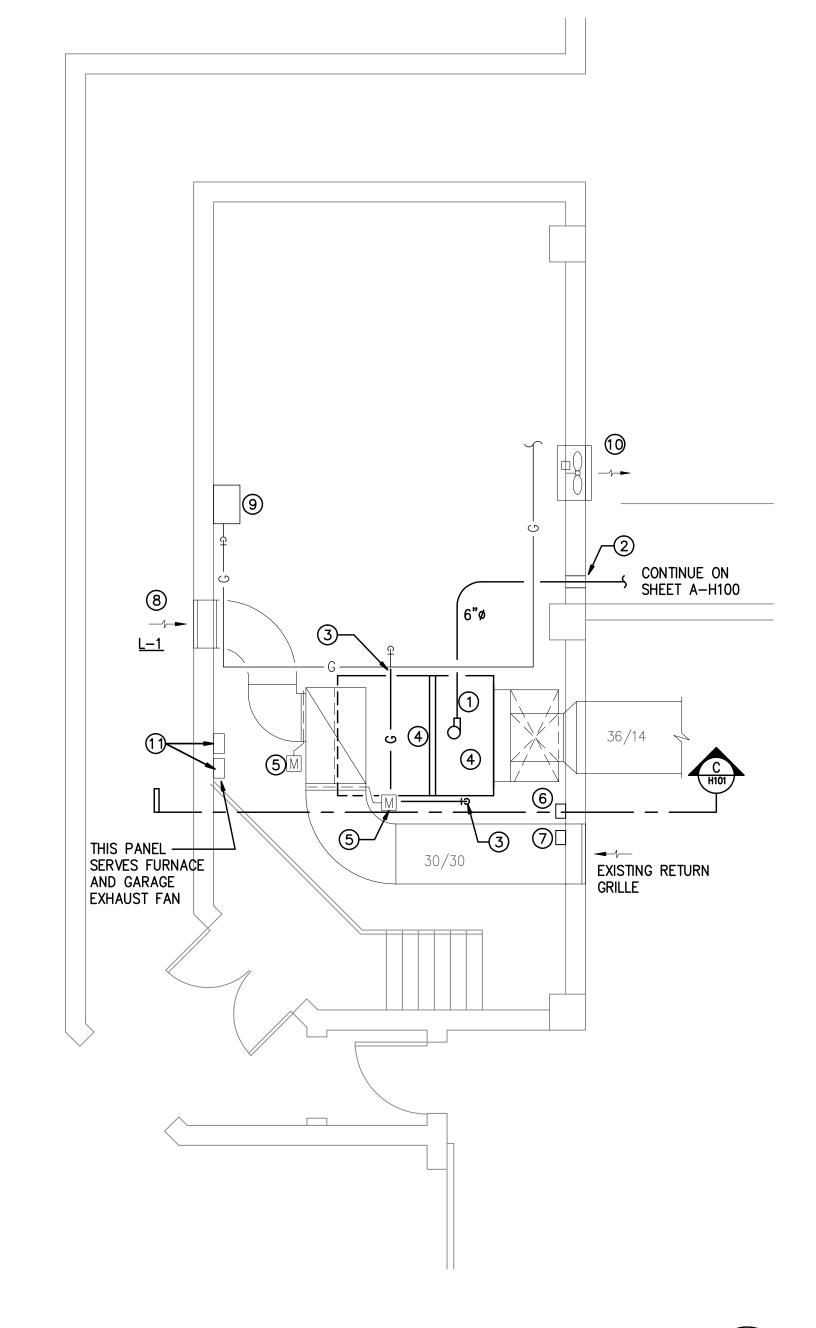






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DANE COUNTY **CAPITOL SQUARE SOUTH RAMP REQUEST FOR BID NO. 317022** 

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Drawing Title:

MECHANICAL ROOM FLOOR **PLANS - DEMOLITION AND NEW WORK** 


H101

FBN

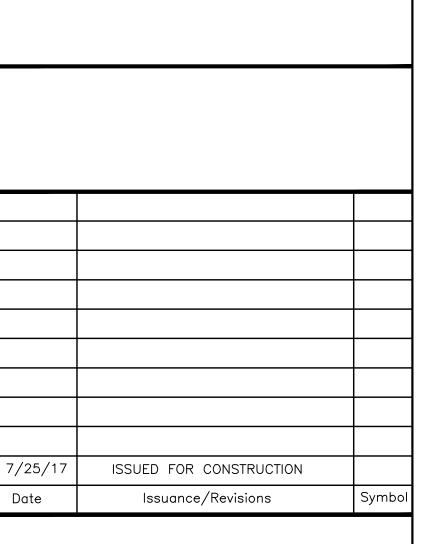	MANUFACTURER				FAN DATA					MO	UNTING						
		MODEL NO.	AIR FLOW EXT. STATIC		FAN WHE	WHEEL	HEEL DRIVE		PM	ΠP	POSITION	MOUNTING	ENCL	BHP	HP	VOLTS /	REMARKS
EE 04			(CFM)	PRESS	TYPE	TYPE	TYPE	MOTOR	FAN	SPEED						PHASE	
EF-G1	GREENHECK	TCB-1-22-15	4700	0.5	INLINE	BI	BELT	1725	993	5559	HORIZONTAL	FLOOR STAND	TEFC	1.1	1 1/2	208/60/3	1 THRU 8
١	Notes																
1	ALUMINUM WHEE	L, HOUSING AND	D RUB RING														
2	AMCA TYPE B SP.	ARK RESISTANC	CE														
3	INLET AND OUTLE	T COMPANION F	FLANGES														
4	ONE SET SPARE	BELTS															
5	ISOLATOR SPRIN	GS, 1 INCH															
6	NEMA-1 TOGGLE	SWITCH															
7	MOTOR STARTER	- MODEL MSAC-	-1-9/J-G8-40,	1.5 HP, 280/60	/3												
8	INSPECTION SECTION	TON ON INLET E	ND OF FAN														

							CAPAC	CITY			FAN						ELEC	CTRICAL	DATA	
MARK	MANUFACTURER	MODEL NO.	UNIT	DISCH.	HEATING	GAS PRESS.		Н	EATING MBH		CFM	EXT SP	TOTAL	MOTOR	FAN	BHP	HP		VOLTS/	REMARKS
			ARRANG	POSITION	TYPE	IN. w.c.	EAT °F	LAT °F	INPUT MBH	OUTPUT MBH		IN. WC	SP	RPM	RPM				PHASE	
MUA-1	STERLING	ME-40A	HORIZ	HORIZ	NAT GAS	14	-15	55	400	1049.8	4,700	0.7		1725			2.00		208/3	1 THROUGH 18
	REMARKS																			
1	RETURN FIRES	TAT							11	LOW GAS P	RESSU	RE SWIT	CH							
2	409 STAINLESS	STEEL FURNA	ACES		12 GAS PRESSU						SURE RE	URE REGULATOR - IF REQUIREED FOR BURNER GAS PRESSURE								
3	SINGLE STAGE	BURNER CON	ITROL						13	DIRTY FILTE	RSWIT	CH								
4	STANDARD BLO	WER							14	NOTE THAT	UNIT W	ILL OPER	ATE W	TH 1009	% OUTS	IDE AII	R OR 1	00% RE	TURN AIR	
5	MAXITROL ELEC	CTRONIC MOD	ULATION E	SURNER CO	NTROL					SEE CONTR	OL SPE	CIFICATION	ON.							
6	PREMIUM EFFI	CIENCY MOTO	R																	
7	MOTOR START	ER .																		
	REAR BLOWER																			
	1 INCH 30% FIL		ER CABIN	IET																
		HIGH GAS PRESSURE SWITCH																		

LOUV	LOUVER SCHEDULE														
					SIZE		AIR PRESSURE	CONSTRU	CTION						
MARK	MFGR	MODEL NO.	INTAKE OR	AIR FLOW	WXHXD	FREE AREA	DROP	BLADE	MATERIAL	THICKN	ESS (IN)	FRAME	BLADE	BLADE	REMARKS
			RELIEF	CFM	INCHES	MIN SF	MAX. " W.C.	STYLE		BLADE	FRAME	TYPE	ANGLE	ALIGNMENT	
L-1	GREENHECK	ESU-153	INTAKE	1,425	36 x 24	3.9	0.14	THINLINE	ALUM	0.05	0.063	FLANGE	30	HORIZ	1, 2, 3
	NOTES														
1	FREE AREA IS	FOR SCHEDL	JLED SIZE												
2	BIRDSCREEN														
3	MILL FINISH														

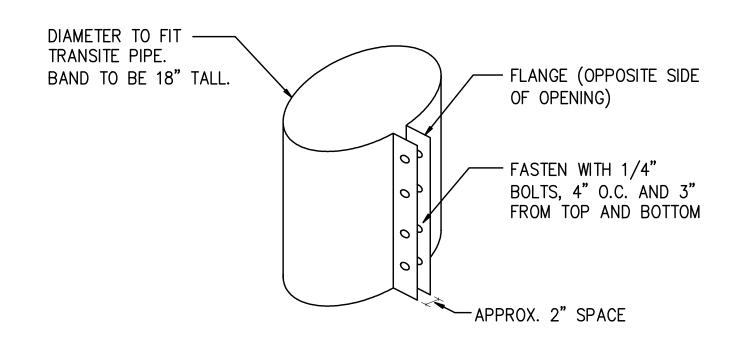



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