



# DANE COUNTY CONSOLIDATED FOOD SERVICE REQUEST FOR BID NO. 317020

## HVAC EQUIPMENT REPLACEMENT 1000 EAST VERONA AVE, VERONA WI

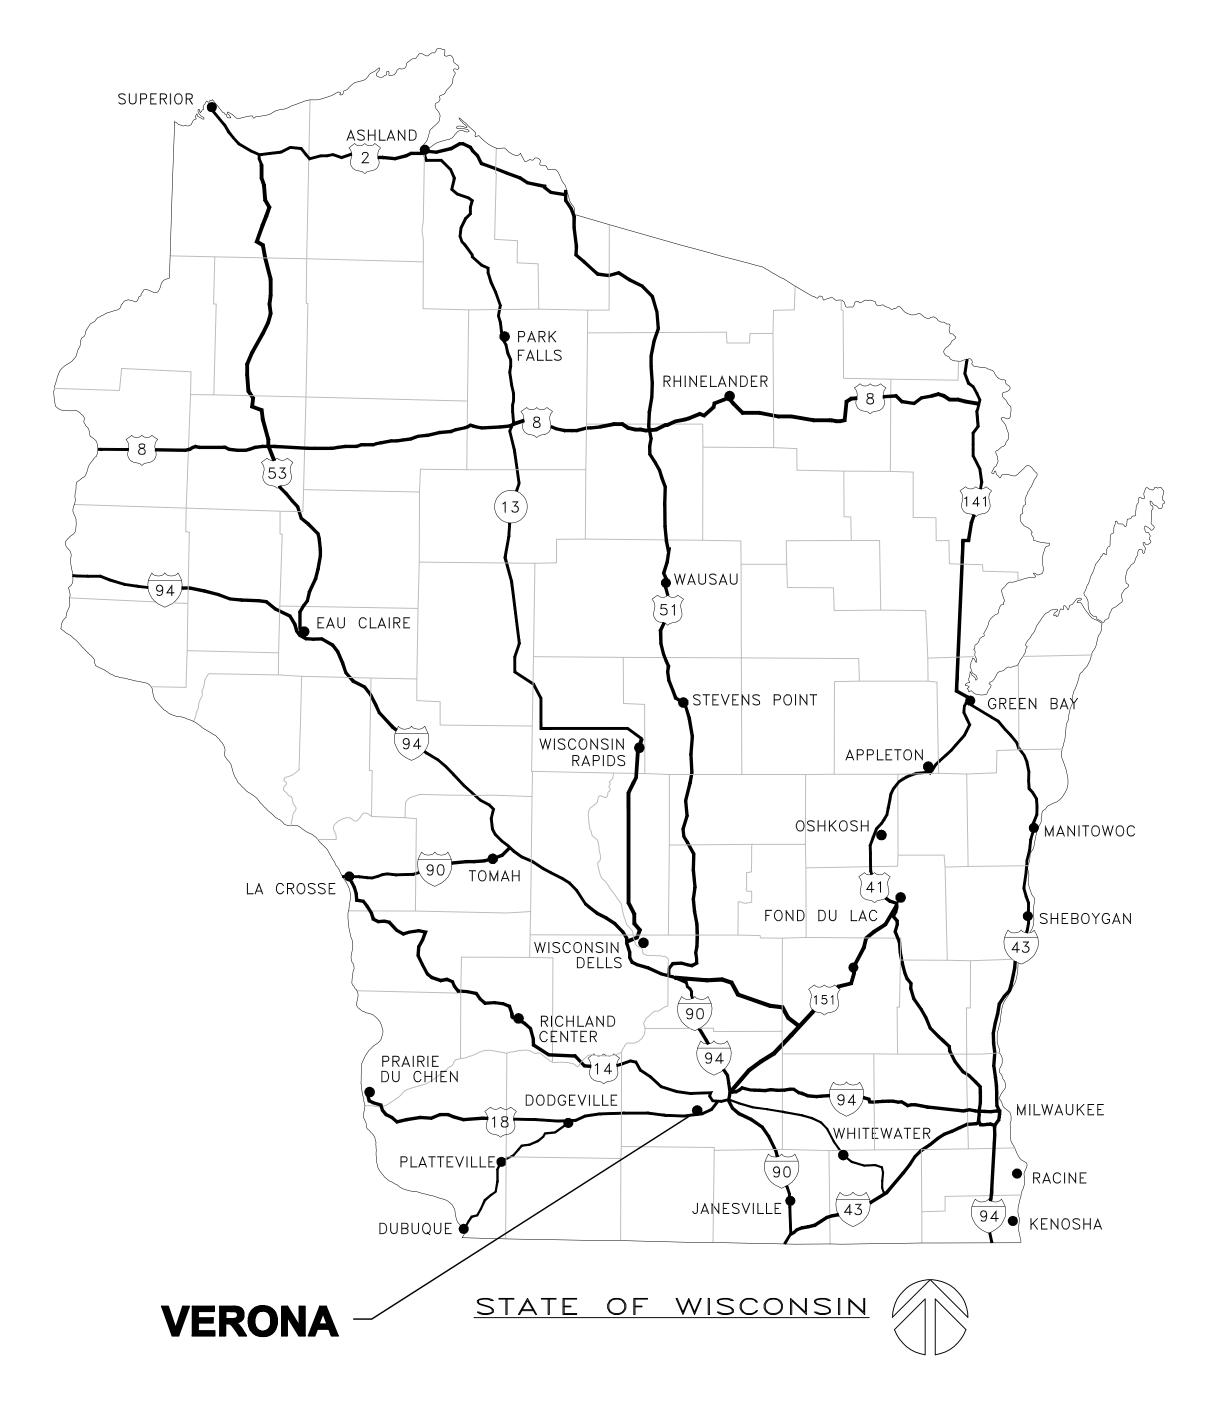

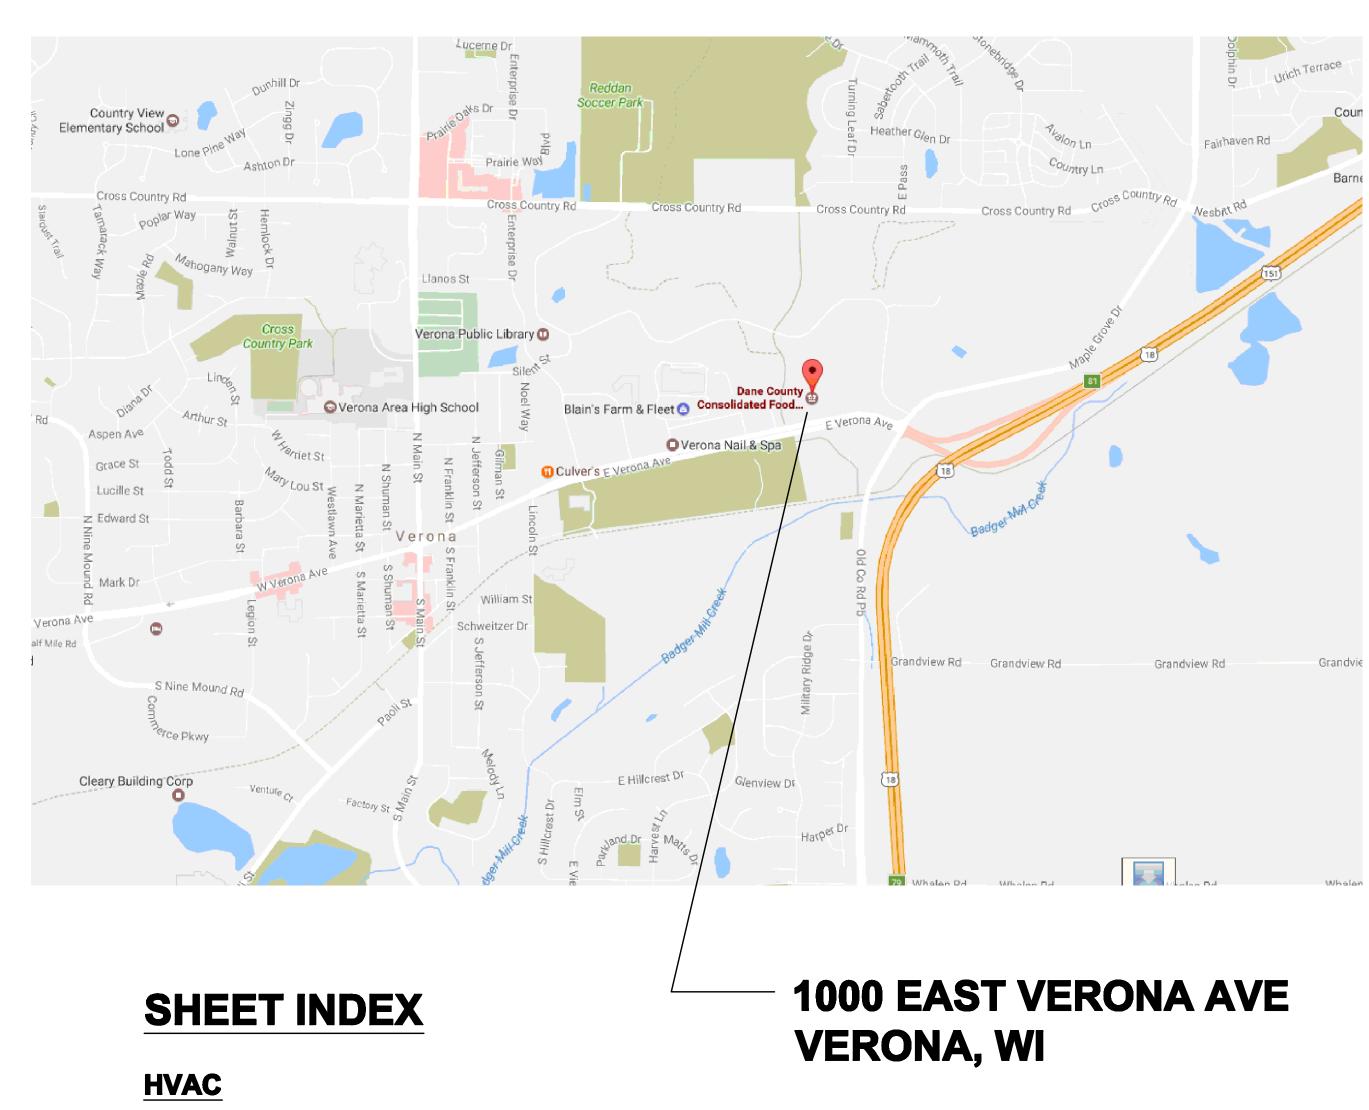

T100 TITLE SHEET

H100 PARTIAL LOWER LEVEL AND FIRST FLOOR DEMOLITION PLANS H101 PARTIAL LOWER LEVEL AND FIRST FLOOR NEW WORK PLANS

**H200 HVAC SCHEDULES, DETAILS AND PICTURES**  Engineering 370, LLC

MECHANICAL CONSULTING

Oregon, WI 53575 T: 608-225-9273 F: 608-835-2077 Email: info@eng370.com

**Project No. 17-0506** 

Notes:

ISSUED FOR CONSTRUCTION Issuance/Revisions

DANE COUNTY CONSOLIDATED FOOD SERVICE (CFS) **REQUEST FOR BID NO. 317020** 

**HVAC EQUIPMENT REPLACEMENT** 


1000 EAST VERONA AVE VERONA, WI

Drawing Title:

TITLE SHEET

FBN

T100

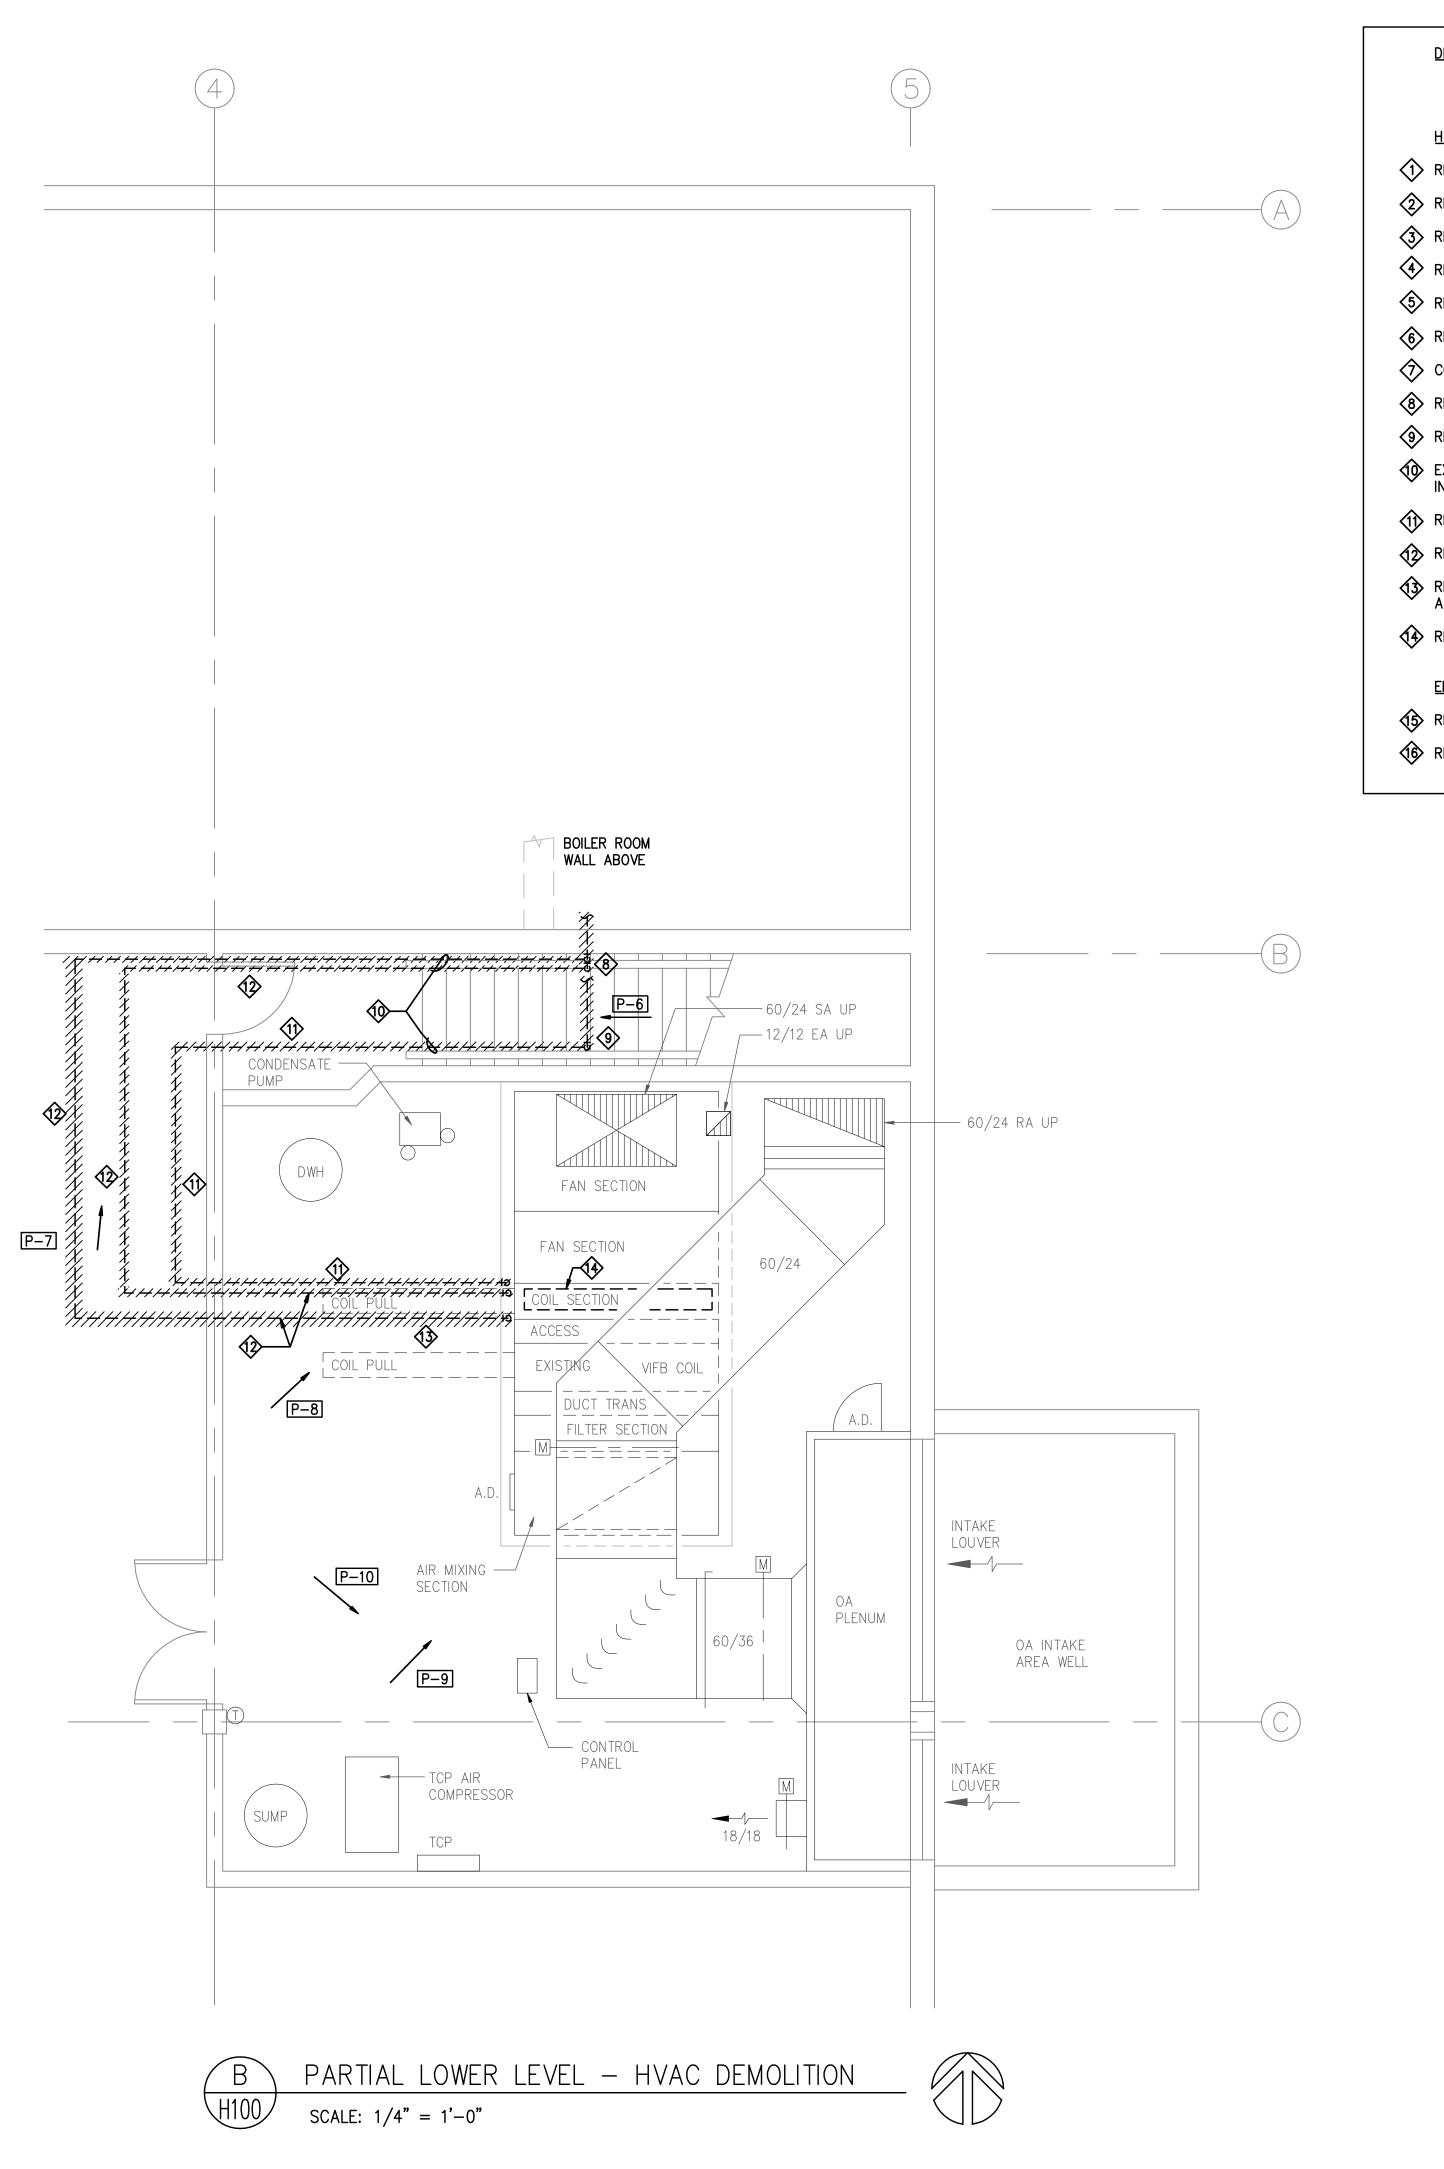

#### DEMOLITION WORK BY OWNER


- 1. DANE COUNTY WILL EVACUATE AND RECLAIM THE EXISTING REFRIGERANT.


  2 DANE COUNTY WILL REPLACE THE EXISTING AIR FILTERS WITH MERV 1.3 FILTERS REFORE THE TEST
- 2. DANE COUNTY WILL REPLACE THE EXISTING AIR FILTERS WITH MERV 13 FILTERS BEFORE THE TESTING AND BALANCING OF THE AIR HANDLING UNIT AIR FLOW.

  HVAC DEMOLITION KEY NOTES A AND B—H100
- $\uparrow$  REFER TO REFERENCED PHOTOS (P-#) ON SHEET H200 FOR EXISTING CONDITION AT SELECTED LOCATIONS.
- (2) REMOVE 1' LIQUID, 1" HOT GAS BYPASS AND 2" SUCTION REFRIGERANT LINES TO ACCU-1.
- 3 REMOVE 1' LIQUID AND 2" SUCTION REFRIGERANT LINES TO ACCU-2.
- REMOVE TWO 1" LIQUID, ONE 1" HOT GAS BYPASS AND TWO 2" SUCTION REFRIGERANT LINES INTO AND RUNNING THROUGH THE BOILER ROOM.
- \$\sqrt{5}\ REMOVE TWO 2"SUCTION LINES THROUGH BOILER ROOM WALL AND DROPPING TO LOWER LEVEL.
- REMOVE TWO 1" LIQUID LINES AND ONE 1" HOT GAS BYPASS LINE THROUGH BOILER ROOM WALL AND DROPPING TO LOWER LEVEL.
- CONTROL WIRING CONNECTIONS TO CONDENSING UNITS TO BE REMOVED.
- (8) REMOVE TWO 2" SUCTION LINES FROM ABOVE.
- PREMOVE TWO 1" LIQUID AND ONE 1" HOT GAS BYPASS LINES FROM ABOVE
- EXISTING DRYWALL SOFFIT ENCLOSING REFRIGERANT PIPING LINES TO BE REMOVED AS NECESSARY TO REMOVE PIPING. SOFFITS TO BE REPLACED AFTER INSTALLATION OF NEW REFRIGERANT LINES. REFER TO DRAWING H101.
- REMOVE TWO 1" LIQUID AND ONE 1" HOT GAS BYPASS LINES.
- REMOVE TWO 2" SUCTION LINES.
- REMOVE REFRIGERANT PIPING CONNECTIONS AND REFRIGERANT ACCESSORIES AT TWO COOLING COILS. REFER TO PHOTOS P-8 AND P-9 FOR PIPING AT THE AHU COILS.
- REMOVE TWO DX COOLING COILS FROM AIR HANDLING UNIT.

#### ELECTRICAL DEMOLITION KEY NOTES - A-H100

- REMOVE POWER CONNECTION TO ACCU-1 FROM DISCONNECT TO UNIT. DISCONNECT TO REMAIN TO SERVE NEW ACCU-1.
- REMOVE POWER CONNECTION TO ACCU-2 FROM DISCONNECT TO UNIT. DISCONNECT TO REMAIN TO SERVE NEW ACCU-2.

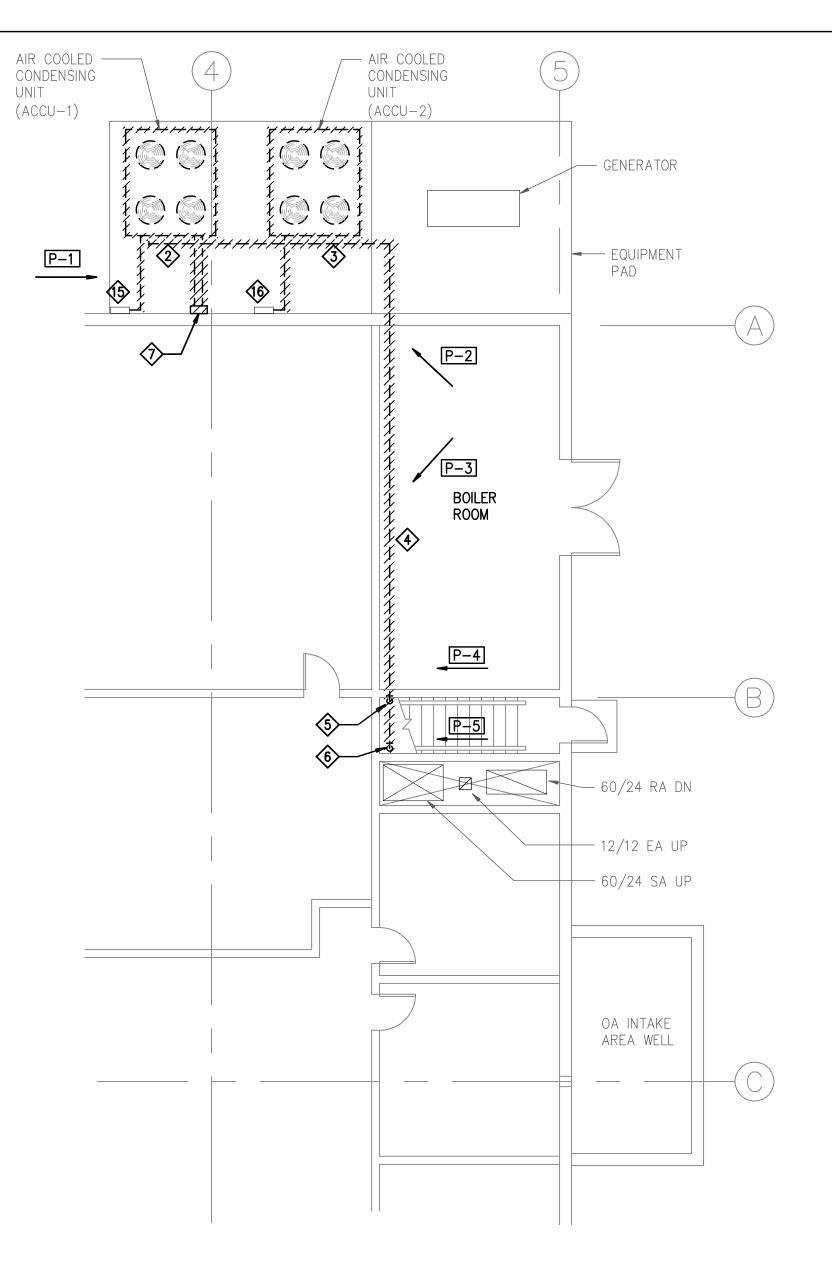

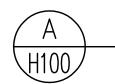

PARTIAL FIRST FLOOR - HVAC DEMOLITION

SCALE: 1/8" = 1'-0"




### Engineering 370, LLC

MECHANICAL CONSULTING

Oregon, WI 53575 T: 608-225-9273 F: 608-835-2077 Email: info@eng370.com

**Project No. 17-0506** 

Dane County Department of Public Works,
Highway and Tranportation
Public Works Engineering Division
1919 Alliant Energy Center Way
Madison, WI 53713

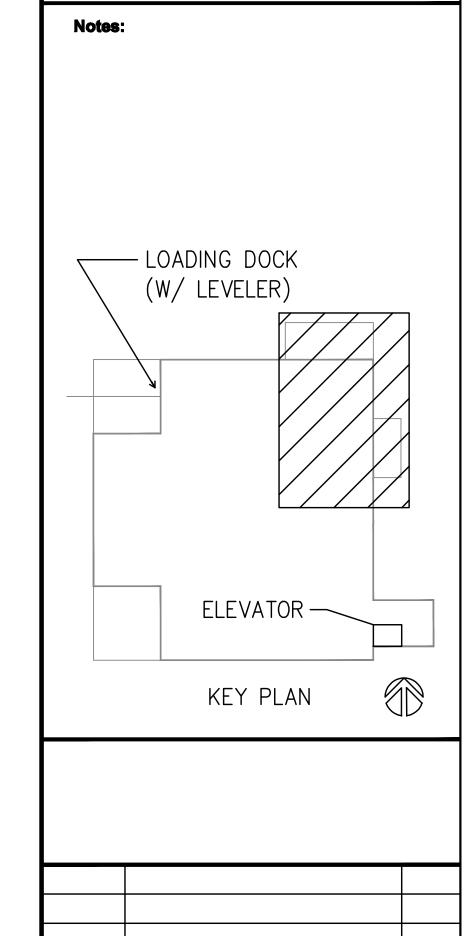

DANE COUNTY
CONSOLIDATED FOOD
SERVICE (CFS)
REQUEST FOR BID NO. 317020

ISSUED FOR CONSTRUCTION

Issuance/Revisions

HVAC EQUIPMENT REPLACEMENT

1000 EAST VERONA AVE VERONA, WI

Drawing 1

PARTIAL LOWER LEVEL AND FIRST FLOOR DEMOLITION PLANS

Drawing No. H100

Drawn By: FBN GENERAL HVAC NOTES - A AND B-H101

1. ACCU-1 AND 2 SHALL BE LOCATED ON THE EXISTING CONCRETE PADS WHICH EXTENDS 16'-1" FROM THE BUILDING AND IS 21'-10" WIDE.
2. THE LOCATIONS OF ACCU-1 AND 2 ARE BASED ON THE BASE SCHEDULED UNITS. UNITS OF OTHER MANUFACTURERS SHALL FIT ON THE EXISTING CONCRETE PAD WHILE MAINTAINING THE REQUIRED CODE AND SERVICE CLEARANCES.


- HVAC NEW WORK KEY NOTES A AND B—H101

  THE CONNECTIONS OF LOCATIONS FOR ACCU—1 AND 2 ARE FOR THE BASE SPECIFIED MANUFACTURERS MODEL.
- (2) ACCU-1 AND 2 FIELD CONTROL WIRING ENTRY.
- 3 REFRIGERANT CONNECTIONS. VERIFY UNIT CONNECTION SIZE. UNIT FIELD PIPING FOR THIS UNIT IS TWO LIQUID LINES 7/8 INCH EACH AND TWO SUCTION LINES 1-5/8 INCH EACH. REFER TO ACCU PIPING DETAIL.
- 4 UNIT FIELD PIPING FOUR 7/8 INCH LIQUID LINES AND FOUR 1-5/8 INCH SUCTION LINES.
- 5 ENTER BUILDING AT SAME LOCATIONS WHERE EXISTING PIPING WAS REMOVED. CORE DRILL NEW OPENING AS REQUIRED TO RUN THE 8 NEW REFRIGERANT LINES. PROVIDE SLEEVES AT WALL OPENINGS AND SEAL SLEEVE TO WALL CONSTRUCTION AND PIPING TO SLEEVE. REFER TO SPECIFICATION.
- 6 PROVIDE PIPE SUPPORT WITH GALVANIZED STRUT CHANNEL FASTENED TO EXISTING CONCRETE PAD (SIMILAR TO EXISTING). EXISTING MAY BE REUSED IF LOCATIONS FIT THE NEW PIPING ARRANGEMENT WITH NEW STRUT ADDED AS REQUIRED BY NEW PIPING ARRANGEMENT.
- (7) PITCH PIPING TOWARD THE COMPRESSOR.
- 8 FOUR 7/8 INCH LIQUID LINES AND FOUR 1-5/8 INCH SUCTION LINES. MOUNT ON EXISTING STRUT CHANNELS MOUNTED ON BOILER ROOM WALL. PROVIDE ADDITIONAL LENGTH OF STRUT AT SAME LOCATION AS REQUIRED TO SUPPORT THE 8 NEW LINES.
- 9 RUN NEW PIPING THROUGH AT SAME LOCATIONS WHERE EXISTING PIPING WAS REMOVED. CORE DRILL NEW OPENING AS REQUIRED TO RUN THE 8 NEW REFRIGERANT LINES. PIPE PENETRATIONS TO BE FIRESTOPPED.
- 10 FOUR SUCTION LINES DOWN TO LOWER LEVEL.
- 1) FOUR LIQUID LINES DOWN TO LOWER LEVEL.
- (12) EXISTING CONTROL JUNCTION BOXES.

- 13 FOUR SUCTION LINES UP TO FIRST FLOOR.
- (4) FOUR LIQUID LINES UP TO FIRST FLOOR.
- (5) FOUR NEW SUCTION LINES. KEEP AS CLOSE TOGETHER AND AS HIGH AS POSSIBLE. PIPING TO BE ENCLOSED IN REPAIRED/NEW DRYWALL ENCLOSURE.
- 16 FOUR NEW LIQUID LINES. KEEP AS CLOSE TOGETHER AND AS HIGH AS POSSIBLE. PIPING TO BE ENCLOSED IN REPAIRED/NEW DRYWALL ENCLOSURE.
- (7) RUN FOUR SUCTION AND FOUR LIQUID LINES AT APPROXIMATE LOCATION OF EXISTING LINES. COORDINATE WITH OTHER PIPING WHICH IS TO REMAIN.
- (18) RUN PIPING THROUGH EXISTING OPENINGS AND CORE DRILL ADDITIONAL WALL OPENINGS REQUIRED.
- (19) DROP PIPING AND CONNECT TO NEW COILS.
- REFER TO NEW COIL PIPING DETAIL FOR PIPING ARRANGEMENT AND REQUIRED REFRIGERANT ACCESSORIES.
- 2) INSTALL NEW COILS IN PLACE OF THE EXISTING. REFER TO THE ORIGINAL AIR HANDLING UNIT SUBMITTAL FOR COIL ARRANGEMENT AND DIMENSIONS FOR REFERENCE, (INCLUDED IN THESE DRAWINGS).
- PROVIDE REQUIRED BLANK-OFF SHEET METAL TO PREVENT AIR BYPASS OF COILS. FIELD VERIFY THE LOCATIONS.
- PROVIDE A CONDENSATE DRAIN PAN BELOW THE UPPER COIL. PIPE DRAIN FROM UPPER PAN TO LOWER PAN. ENSURE NEW DRAIN PAN PITCHES TO DRAIN LOCATION AND PREVENTS PONDING OF CONDENSATE.
- AFTER PIPING IS COMPLETE, TESTED AND INSULATED, ENCLOSE WITH REPAIRED/NEW DRYWALL ENCLOSURE. SIMILAR TO EXISTING CONSTRUCTION INCLUDING DRYWALL FINISHING AND PAINTING TO MATCH THE EXISTING CONSTRUCTION.

ELECTRICAL DEMOLITION KEY NOTES - A-H101

- 25) ACCU-1 AND 2 FIELD ELECTRICAL POWER ENTRY.
- EXISTING ELECTRICAL DISCONNECT. MAKE NEW CONNECTION TO DISCONNECT AND EXTEND POWER WIRING TO NEW UNIT, PROVIDE NEW CONDUIT AND WIRE AS REQUIRED AND SIZED PER MANUFACTURER AND CODE.

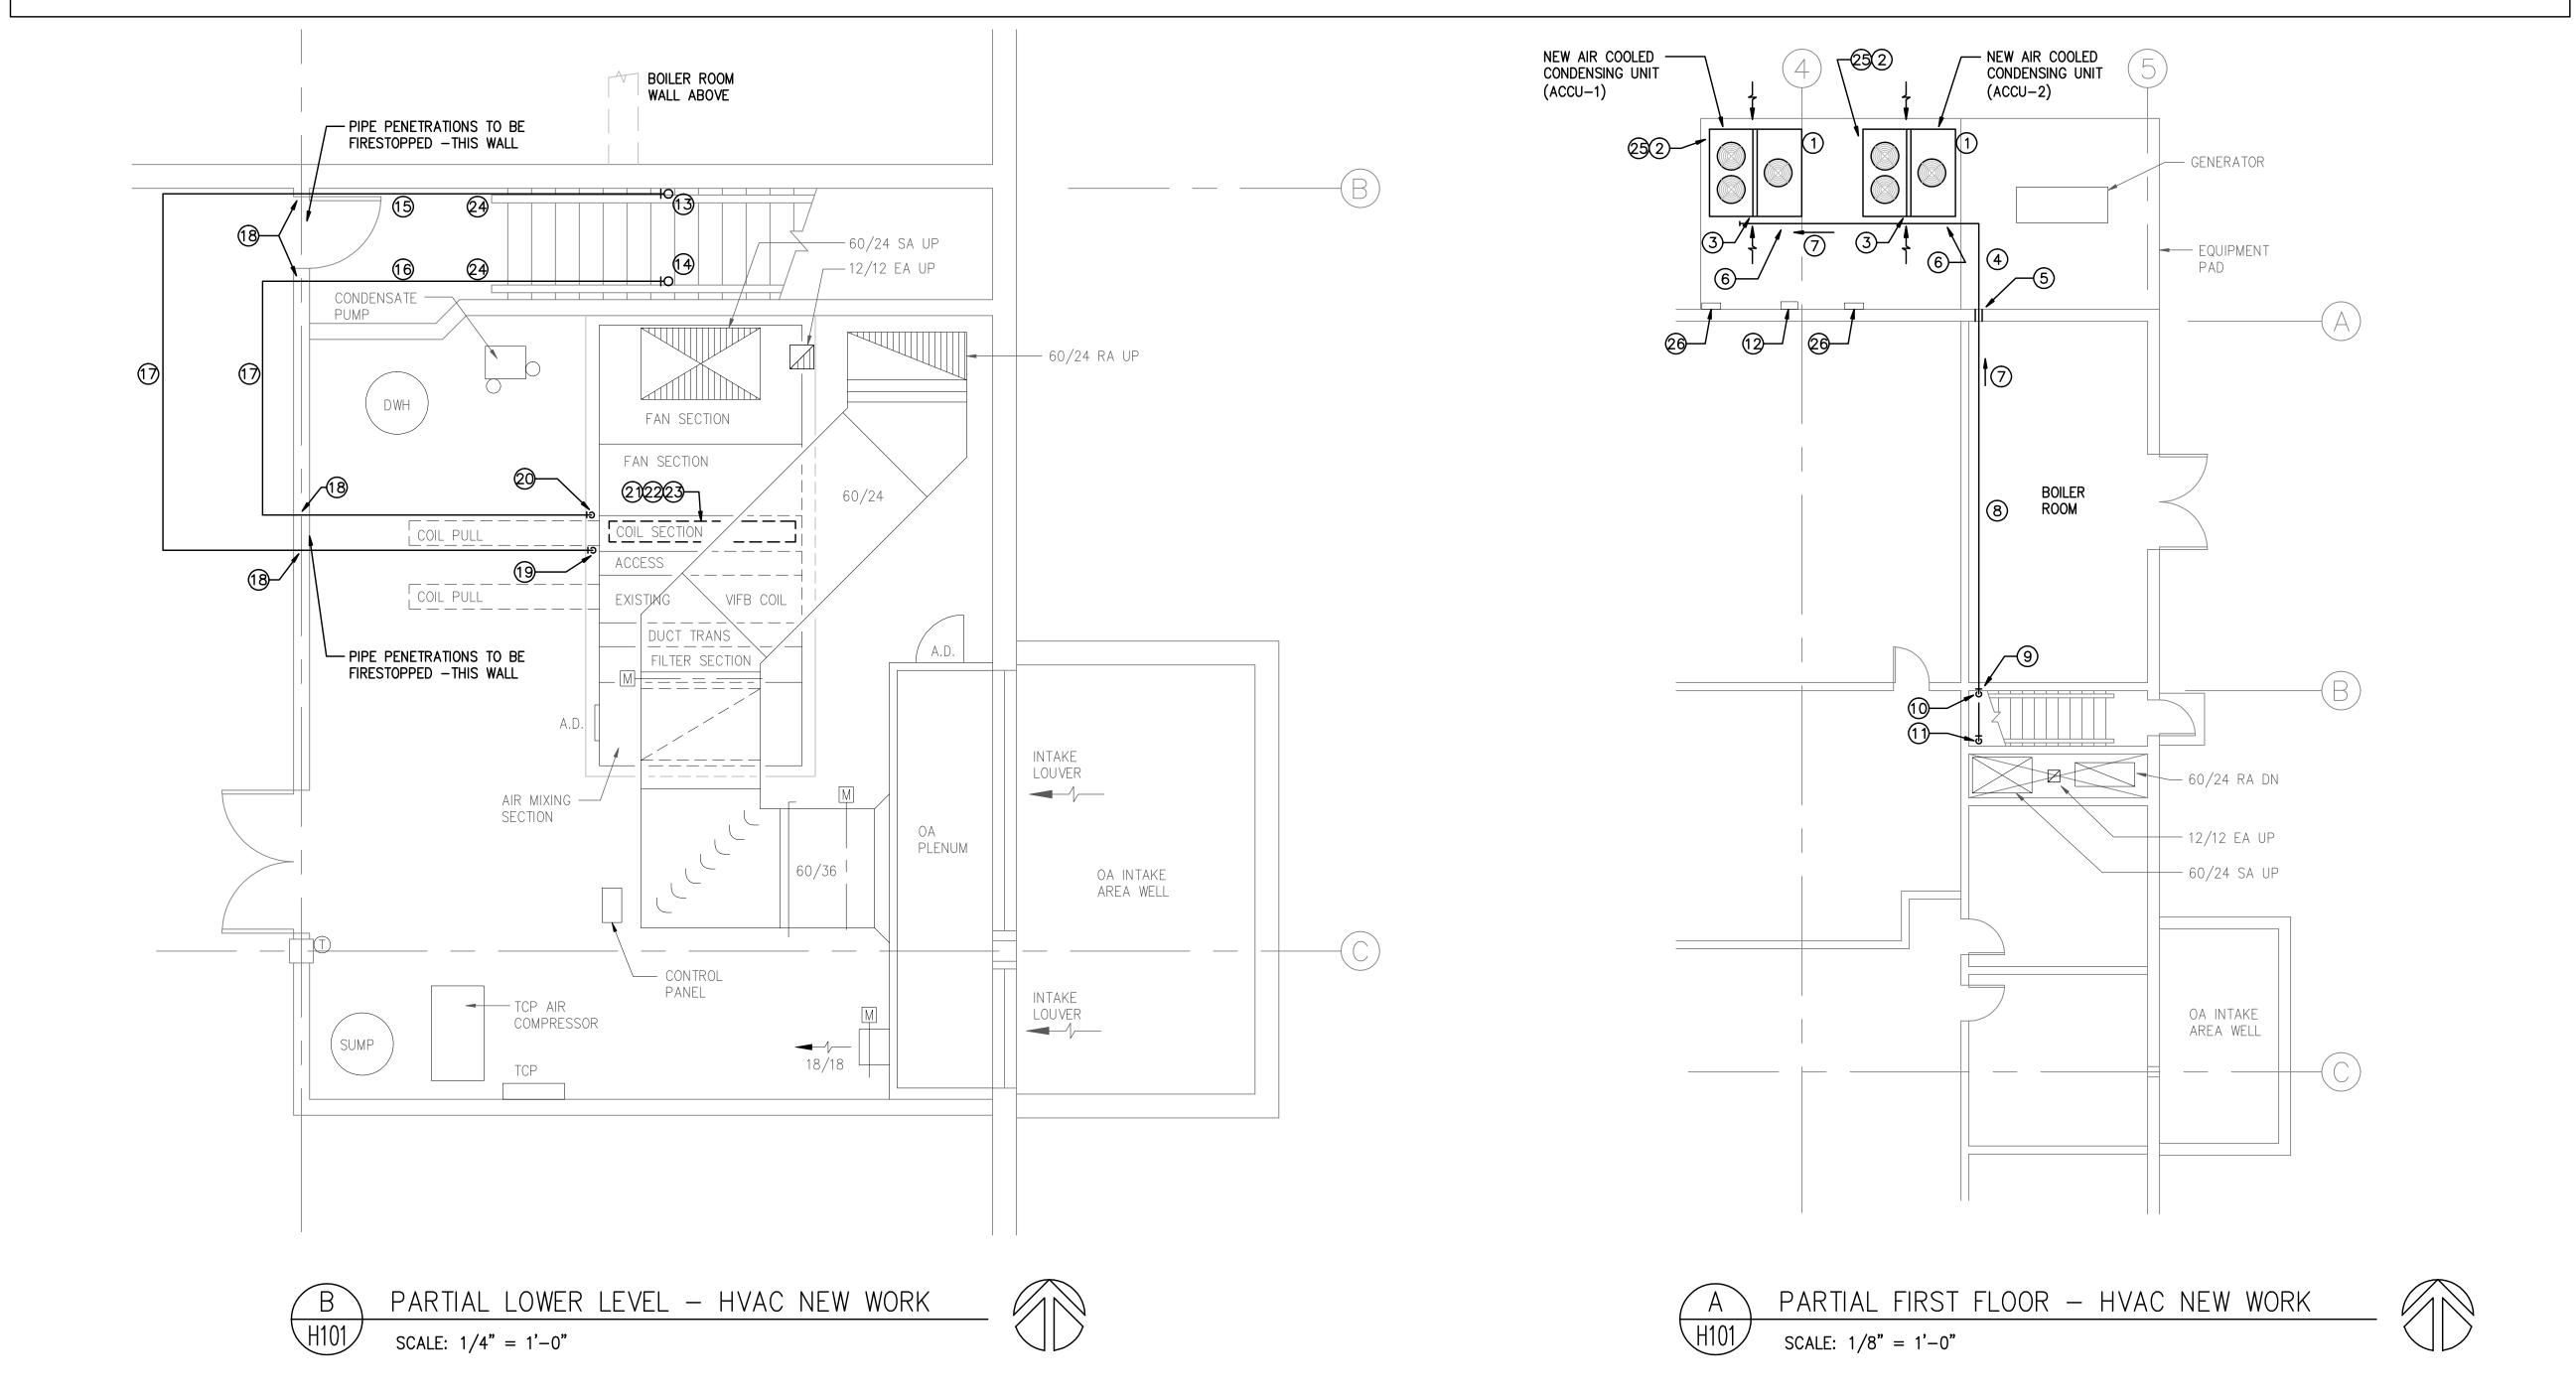


Engineering 370, LLC MECHANICAL CONSULTING

Oregon, WI 53575 T: 608-225-9273 F: 608-835-2077 Email: info@eng370.com

**Project No. 17-0506** 

Dane County Department of Public Works,
Highway and Tranportation
Public Works Engineering Division
1919 Alliant Energy Center Way
Madison, WI 53713

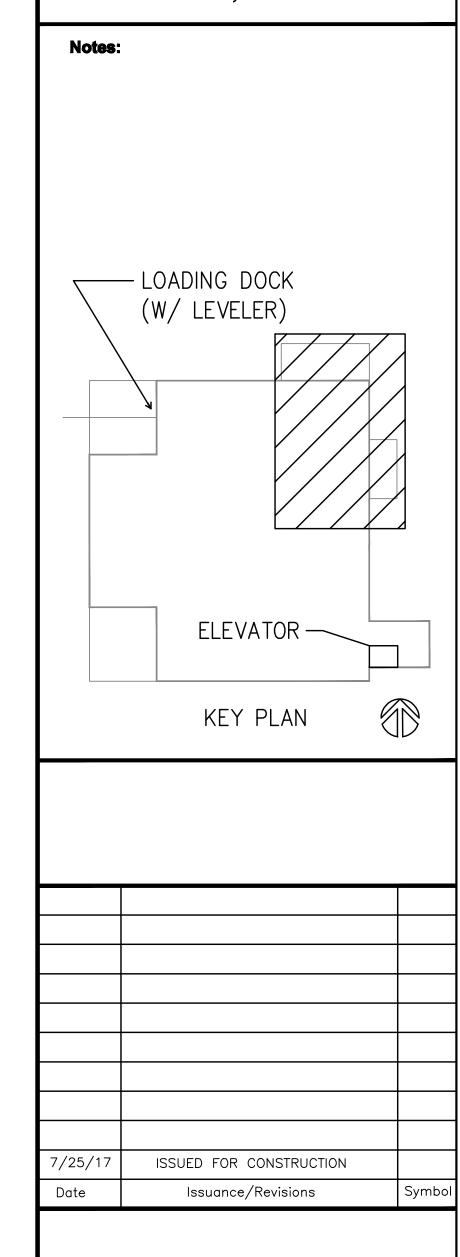

DANE COUNTY
CONSOLIDATED FOOD
SERVICE (CFS)
REQUEST FOR BID NO. 317020

HVAC EQUIPMENT REPLACEMENT


1000 EAST VERONA AVE VERONA, WI

Drawing Title:

FBN

PARTIAL LOWER LEVEL AND FIRST FLOOR NEW WORK PLANS

Drawing No. H101

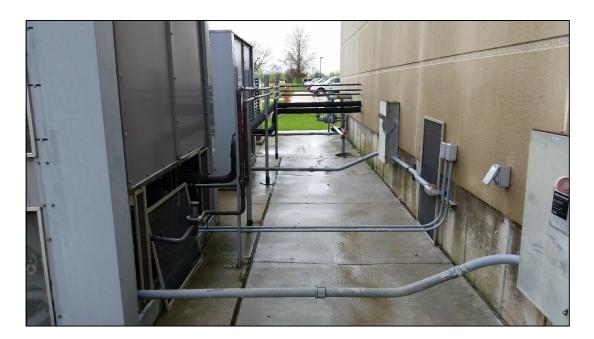


A PICTURE 'P-1'
H200 NOT TO SCALE



PICTURE 'P-5'
H200 NOT TO SCALE




PICTURE 'P-9'
H200 NOT TO SCALE

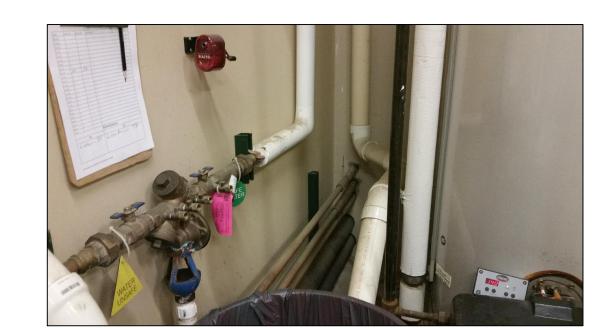


B PICTURE 'P-2'
H200 NOT TO SCALE



F PICTURE 'P-6'
H200 NOT TO SCALE

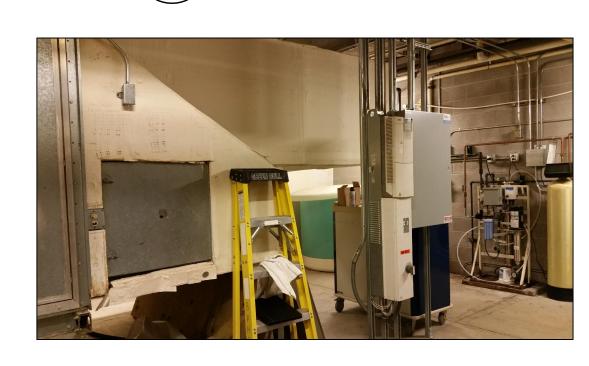


J PICTURE 'P-10'
H200 NOT TO SCALE

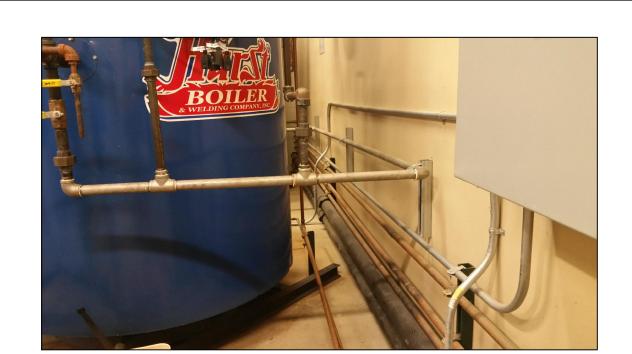

C PICTURE 'P-3'
H200 NOT TO SCALE




G PICTURE 'P-7'
H200 NOT TO SCALE

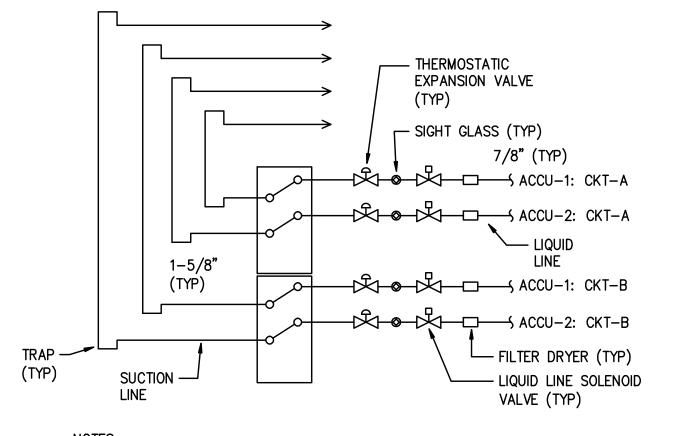

NOTES; 1. SEE NEW COIL SUBMITTALS FOR COIL CONNECTION LOCATIONS. 2. SEE ORIGINAL COIL ARRANGEMENT FOR NEW COIL LOCATIONS.




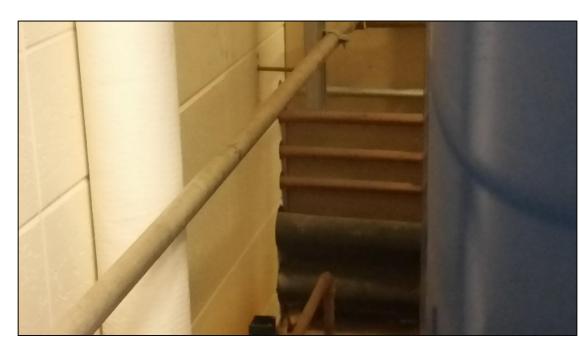

D PICTURE 'P-4'
H200 NOT TO SCALE



H PICTURE 'P-8'
H200 NOT TO SCALE

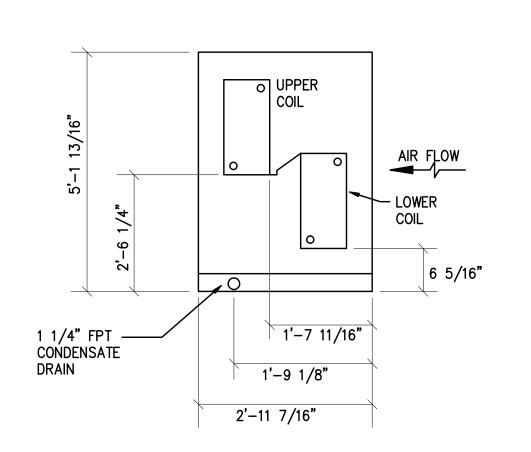



ORIGINAL COIL ARRANGEMENT DETAIL

NOT TO SCALE (FROM ORIGINAL PROJECT SUBMITTAL)

	7/8" LIQUID  REFRIGERANT PIPING
	PITCH TO SUCTION INTO BUILDING
ACCU ———————————————————————————————————	
SUCTION •	LONG LINE KIT: WITH LIQUID LINE CHECK VALVE AND BYPASS CHECK VALVE. INSTALL IN ACCORDANCE WITH UNIT MANUFACTURERS REQUIREMENTS.

M	ACCU PIPING	BETAIL	
H200	NOT TO SCALE	(TYPICAL OF FOUR SETS OF LINES (2 PER ACCU))	

AIIK I	HANDLI	NG UN	ע פווו	X CO	OLING	COI	LO											
TAG	LOCATION	AIR FLOW	COOLING (	COIL													REMARK	KS S
			EAT (°F)		LAT (°F)				ROWS	MAX	MAX	MAX	DISTRIBUTORS	SUCTION	LIQUID	REFRIGERANT		
			DB	WB	DB	WB	TOTAL	SENSIBLE		FINS/INCH	FACE	AIR	PER	TEMP	TEMP			
							HEAT	HEAT			VEL.	PD	COIL	(°F)	(°F)			
							MBH	MBH			(FPM)	("WG)						
CC-1	EXIST AHU-1	10198	91	74	56.2	56	613.9	385.79	8	11	525.8	1.35	2	48.2	110	410A		1, 2, 3, 4
CC-2	EXIST AHU-1	10198	91	74	56.3	56	613.9	385.79	8	11	525.8	1.35	2	48.2	110	410A		1, 2, 3, 4
	1 EXISTING AIR	HANDUN	CLIMITISA	CADDIED	MODEL 20N	און טכחא	UT CENA – 2	0.400										
				CARRIER	VIODEL 35IV	יוט - ככחא	III CFIVI – Z	0,400.										
	DUAL CIRCUIT  TOTAL CAPA																	

		AIR CO	OLED	CONDE	NSING	UNIT	SCH	EDUL	E											
	ASSOCIATED				CAPACITY	(		AMBIENT	MIN COOL	NO. OF				NO. OF		EER	ELEC	TRICAL DA	ГА	
MARK	INDOOR	LOCATION	MFGR	MODEL NO.	NOMINAL	TOTAL	REFRIG	TEMP	OAITEMP	REFRIG	NO. OF	CAPACITY STEPS	COMPRESS	COND	IPLV	AMBIENT	MCA	MOCP	VOLTS/	REMARKS
ACCU	UNIT				TONS	MBH	TYPE	°F	°F	CIRCUITS	COMPRESS		TYPE	FANS		CONDITIONS	AMPS	AMPS	PHASE	
ACCU-1	AHU-1	SEE PLAN	CARRIER	38APD	50	628	R410A	95	25	2	4	23-50-73-100	SCROLL	3	14.9	11.2	99.1	110	480/3/60	1, 2, 3, 4
ACCU-2	AHU-1	SEE PLAN	CARRIER	38APD	50	628	R410A	95	25	2	4	23-50-73-100	SCROLL	3	14.9	11.2	99.1	110	480/3/60	1, 2, 3, 4
REMARKS																				
1	SINGLE POIN	T POWER, N	ON FUSED [	SCONNECT																
2	VIBRATION IS	OLATION FO	R OUTDOOF	R INSTALLATIO	N															
3	SECURITY GRI	LLES-HAIL G	SUARDS																	
4	LONG LINE CH	IECK VALVES	5.																	

### Engineering 370, LLC MECHANICAL CONSULTING

Oregon, WI 53575 T: 608-225-9273 F: 608-835-2077 Email: info@eng370.com

**Project No. 17-0506** 

Dane County Department of Public Works,
Highway and Tranportation
Public Works Engineering Division
1919 Alliant Energy Center Way
Madison, WI 53713

	1717	Madison, WI 53713	
Notes:			
/25 /17	ıc	SSLIED FOR CONSTRUCTION	

CONSOLIDATED FOOD SERVICE (CFS) REQUEST FOR BID NO. 317020

DANE COUNTY

Issuance/Revisions

HVAC EQUIPMENT REPLACEMENT

1000 EAST VERONA AVE VERONA, WI

HVAC SCHEDULES, DETAILS AND PICTURES

Drawing No.

H200
FBN