


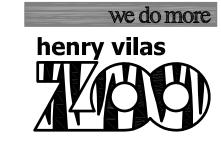

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36

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Henry Vilas Zoo 702 S Randall Ave

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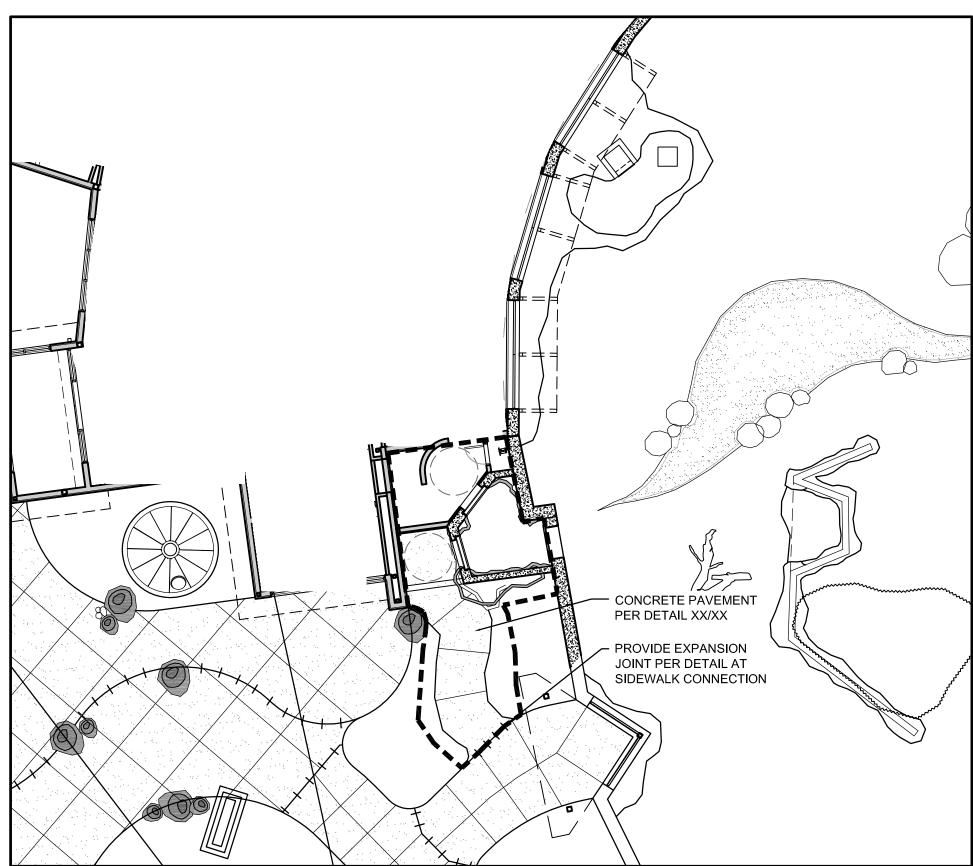
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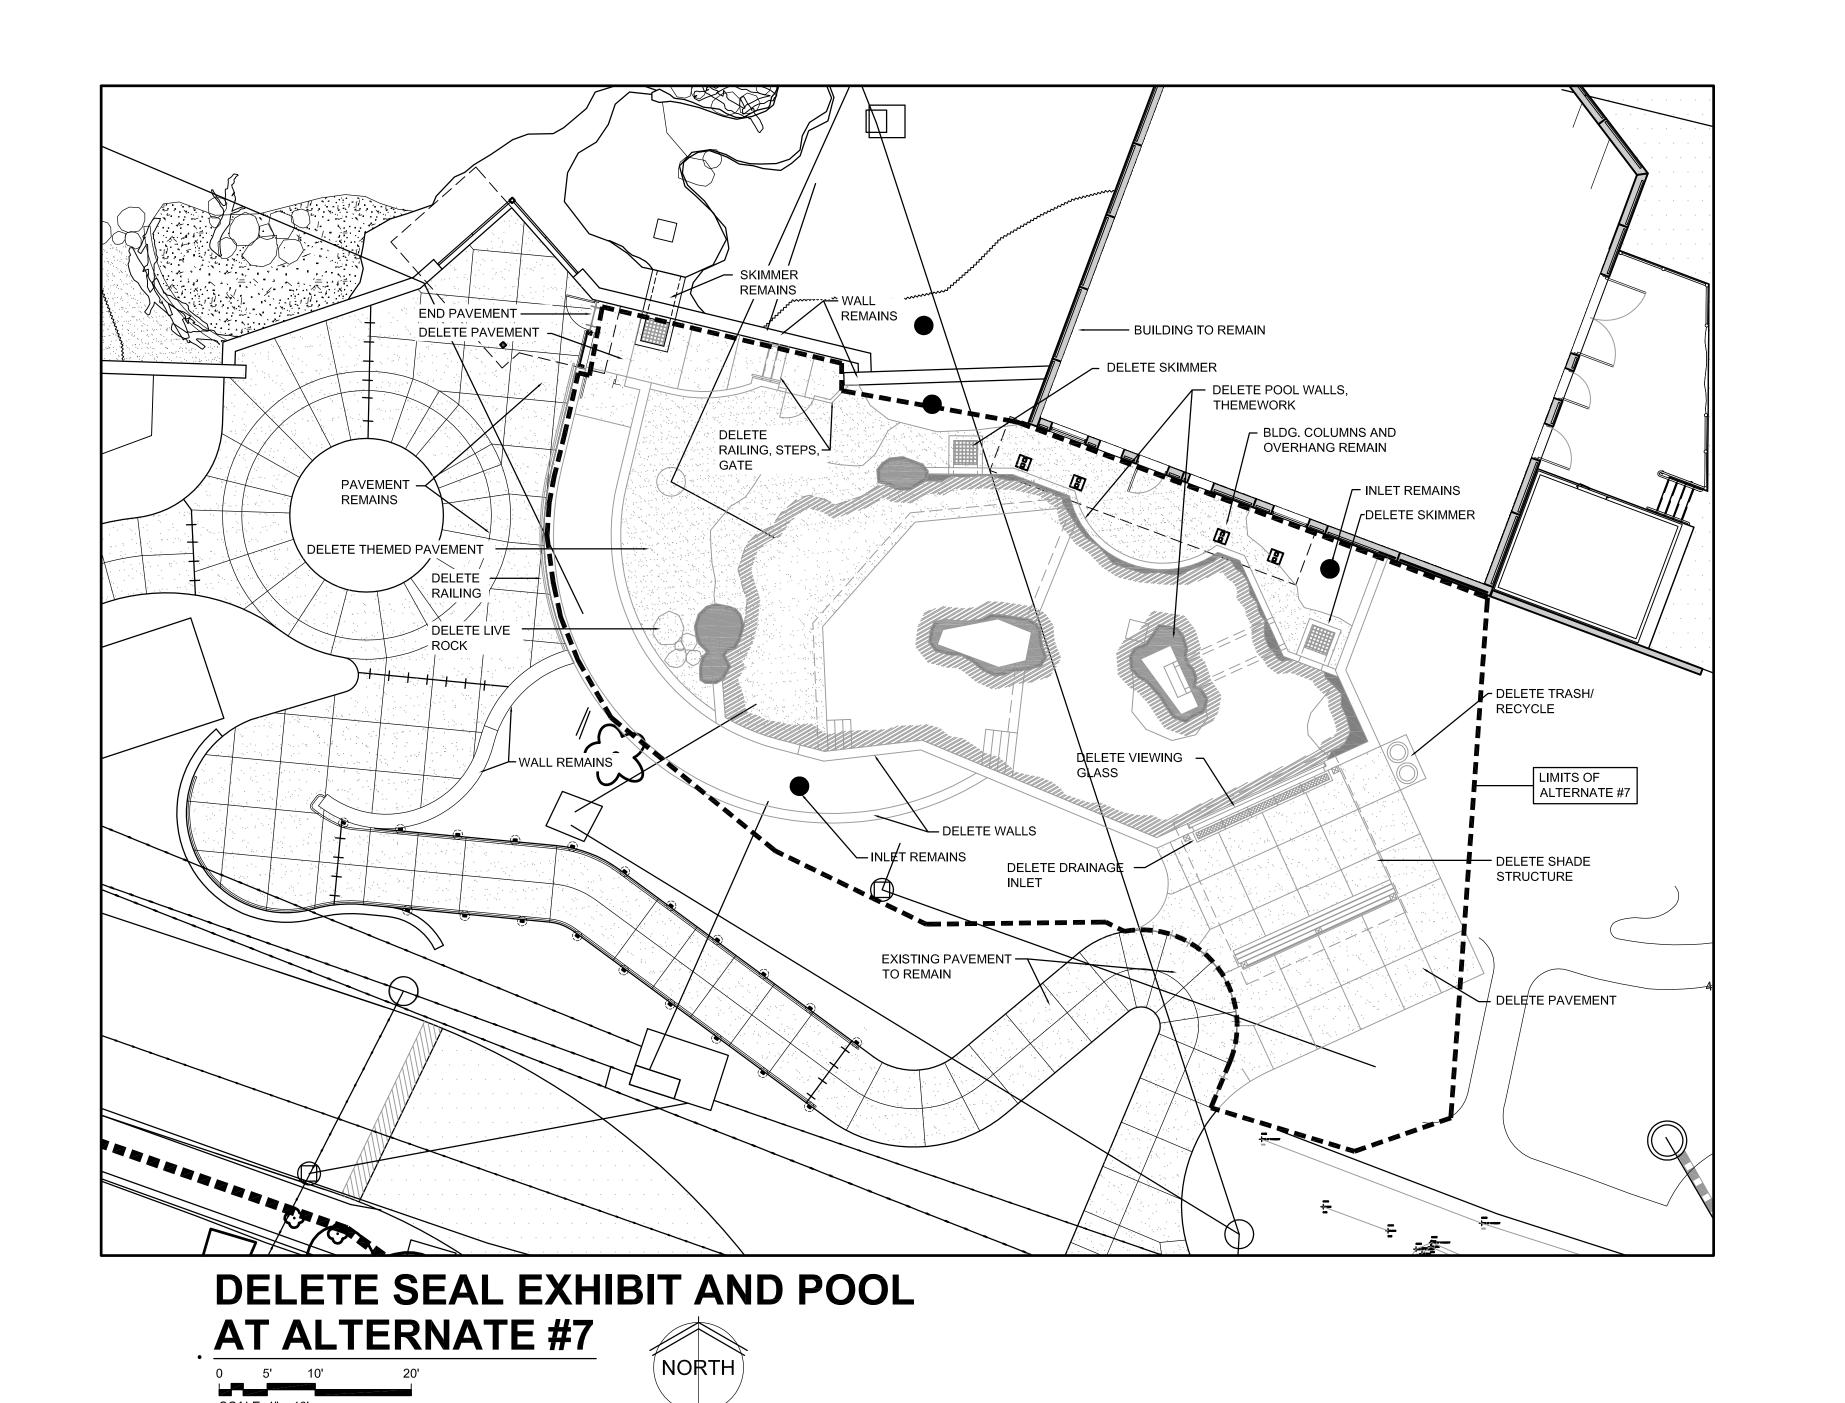
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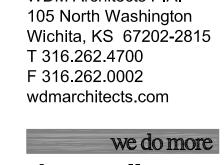
OVERALL SITE ALTERNATES

SA2.0 gray










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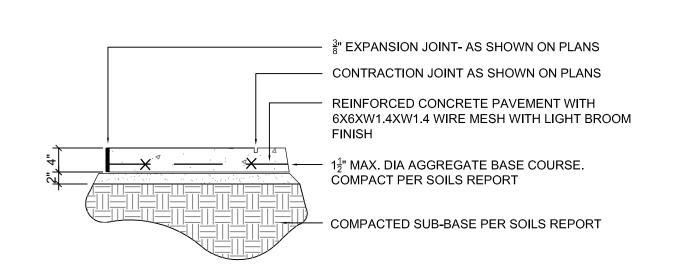
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WDM No. drawn: NS

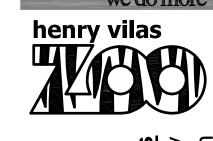SITE ALTERNATES PLAN

SA21

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2-#4 REBAR CONT.

CONTRACTION JOINT

4" THICK CONCRETE -

COMPACTED SUB-BASE PER SOILS REPORT


MODIFIED SUB-GRADE. ——— COMPACTED TO 95% STANDARD PROCTOR DENSITY. REF SOILS

PAVEMENT

AND #4 REBAR @ 2' O.C.

THICKENED EDGE WALK

3/4" = 1' - 0"

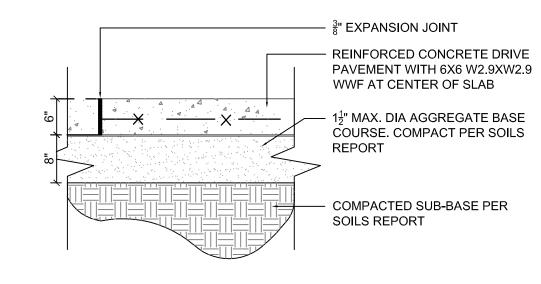

- 3" DIA SS. EYE BOLT WITH

HOOK EMBEDDED IN


CONCRETE BLOCK

' THICK CONCRETE PAVEMENT


DEADFALL MOUNTING BLOCK

3/4" = 1' - 0"


0 8" 16"

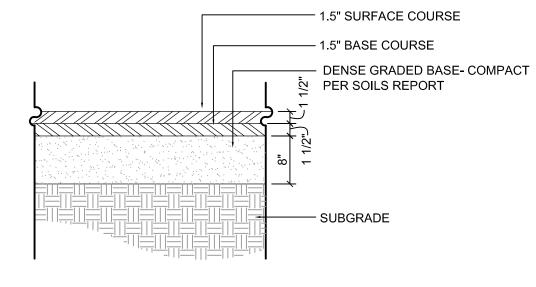




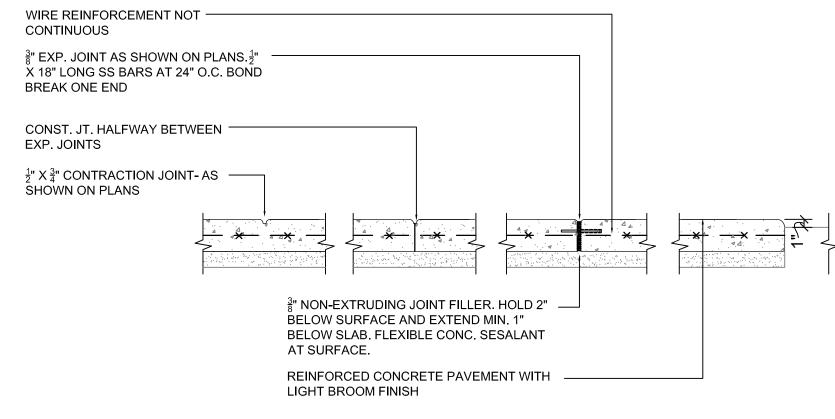


PAVEMENT JOINT DETAILS

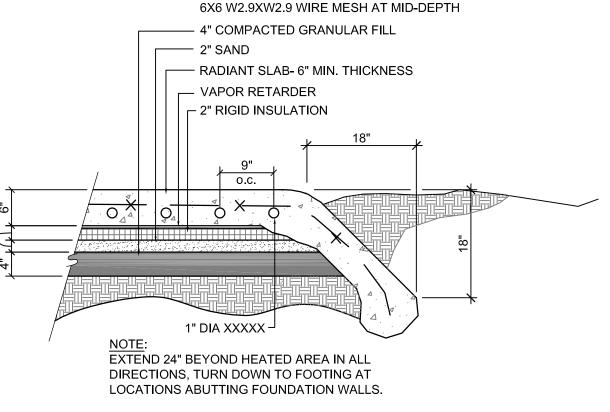

HOT ROCK DETAIL

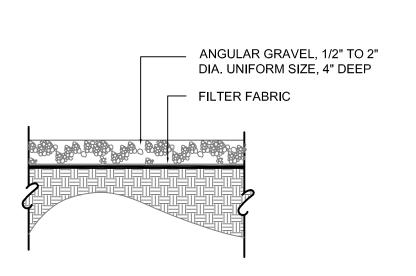


ANGULAR GRAVEL

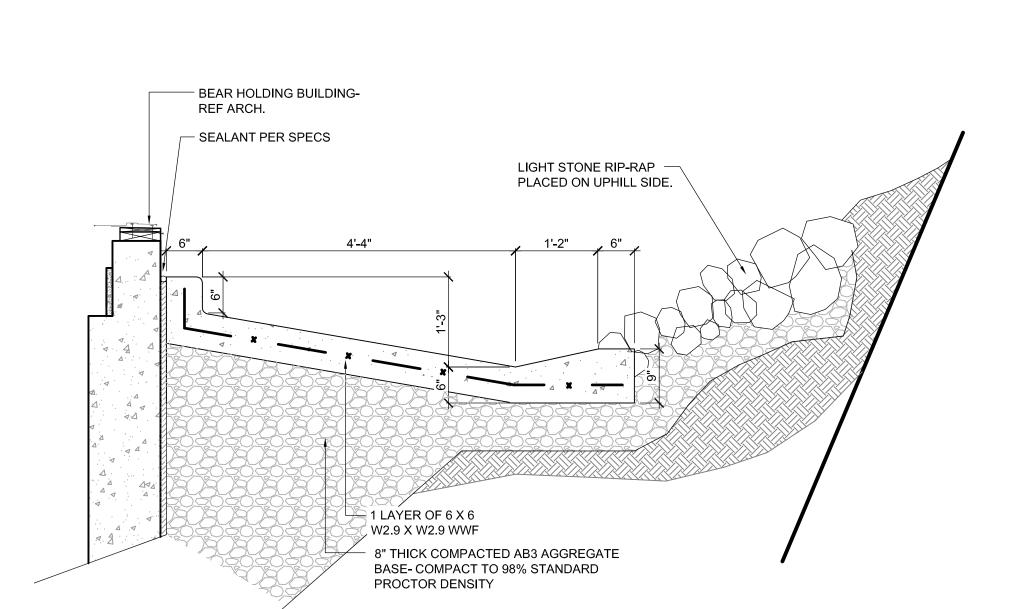


- 4" THICK CONCRETE

PAVEMENT




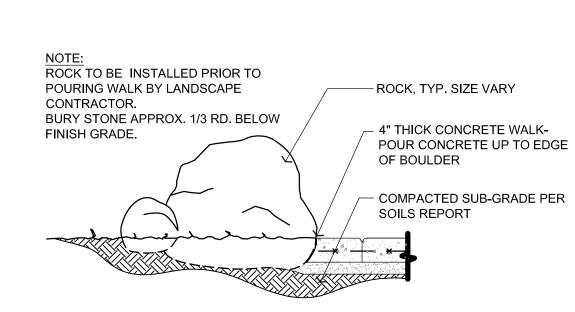




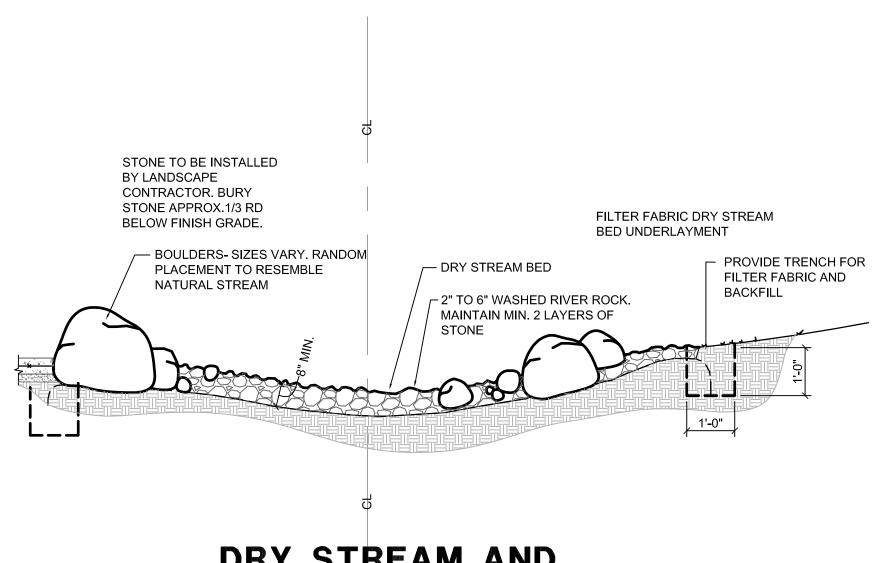



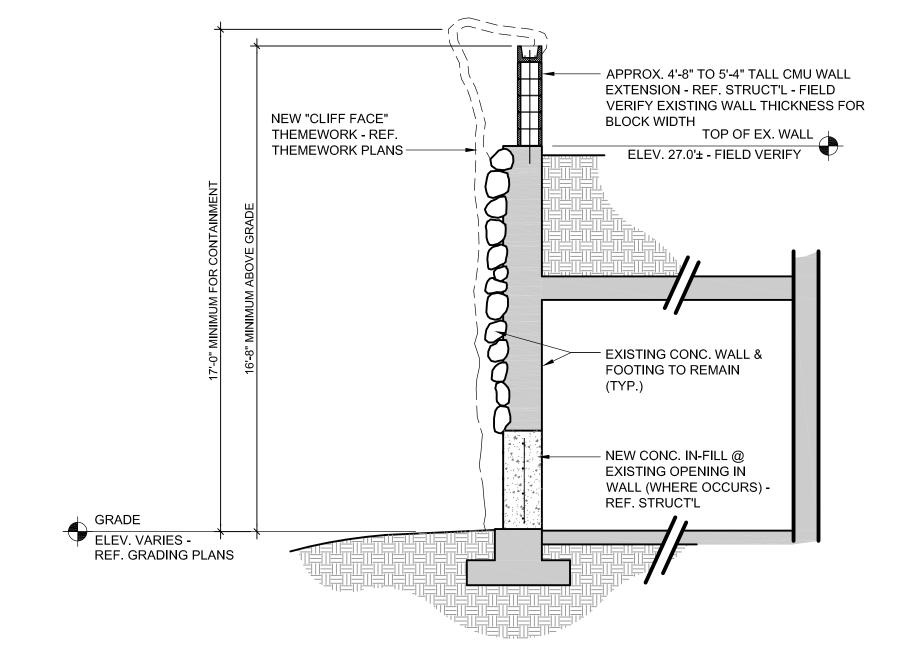



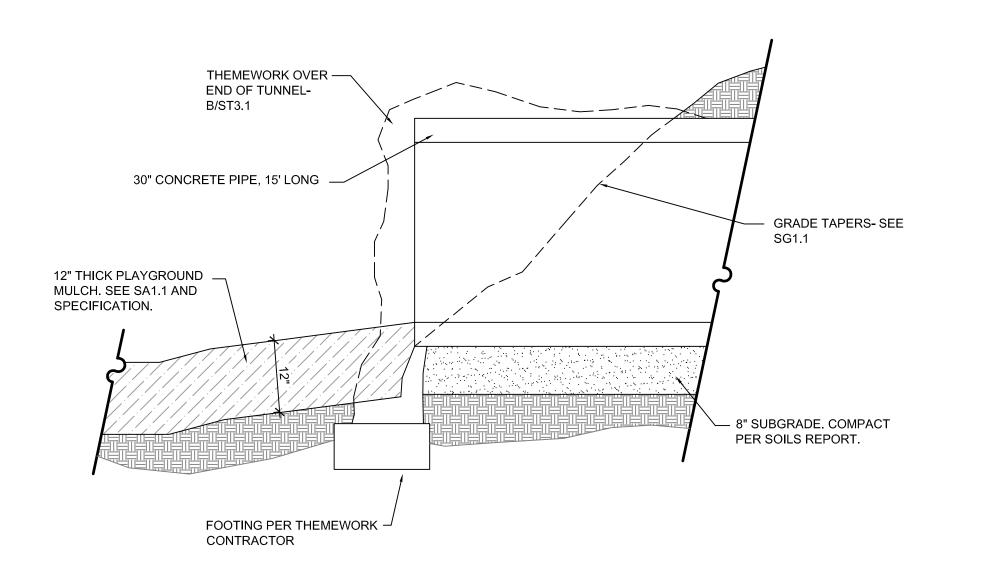



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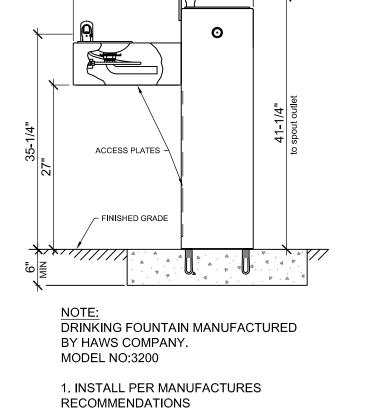
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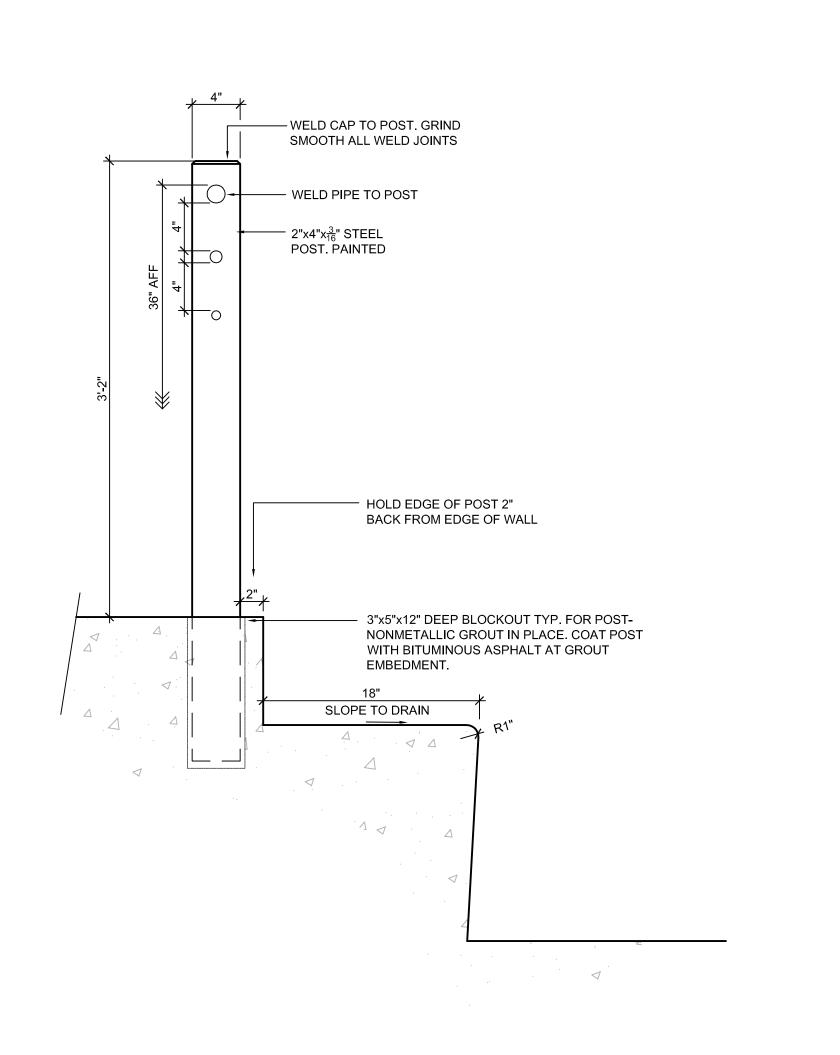
SA3.0





2. SEE PLUMBING PLANS FOR CONNECTIONS.


3. MOUNT ON CONCRETE PAD.







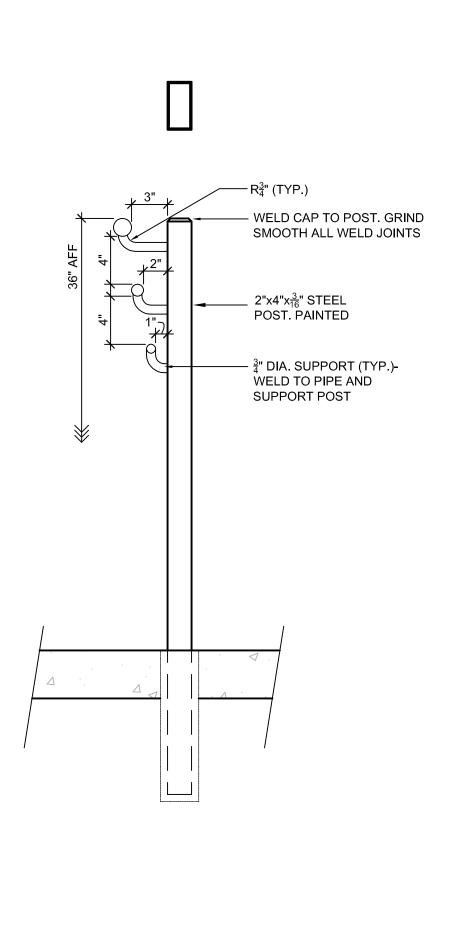

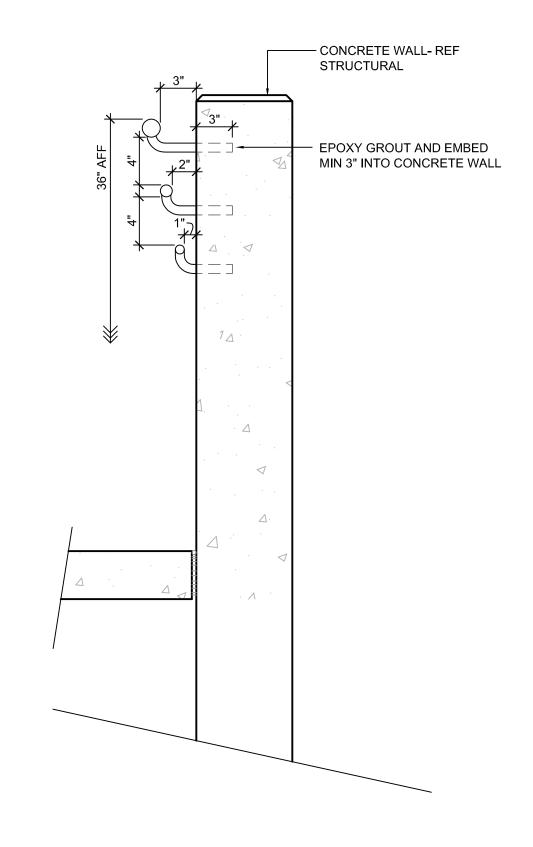

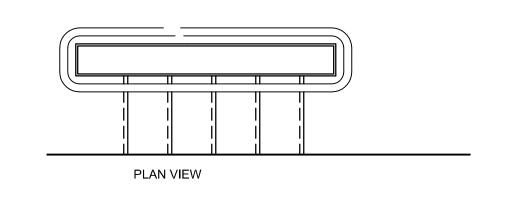

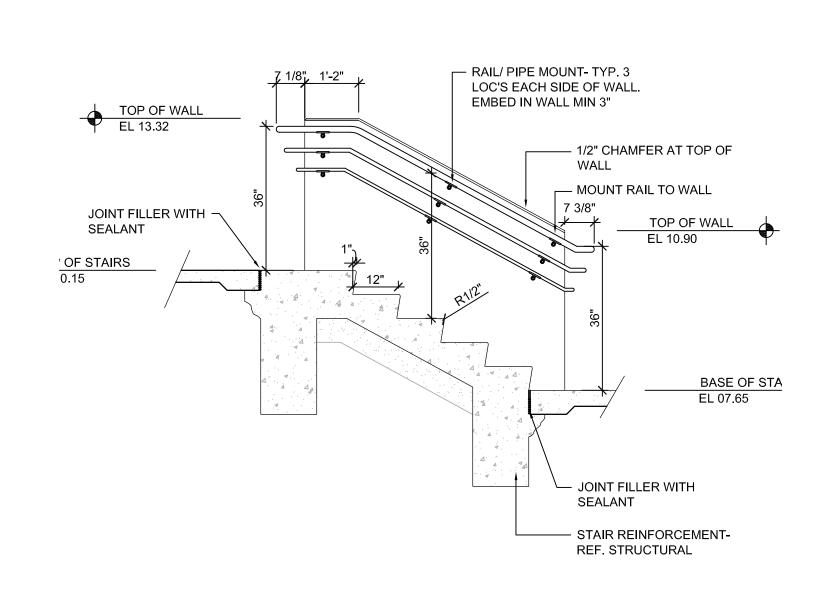

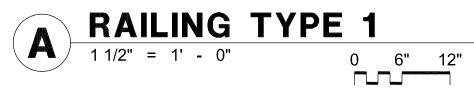




NOTES:
1) COORDINATE COLOR WITH ARCHITECT
2) SUBMIT SHOP DRAWINGS FOR REVIEW AND APPROVAL.





0 1' 2'

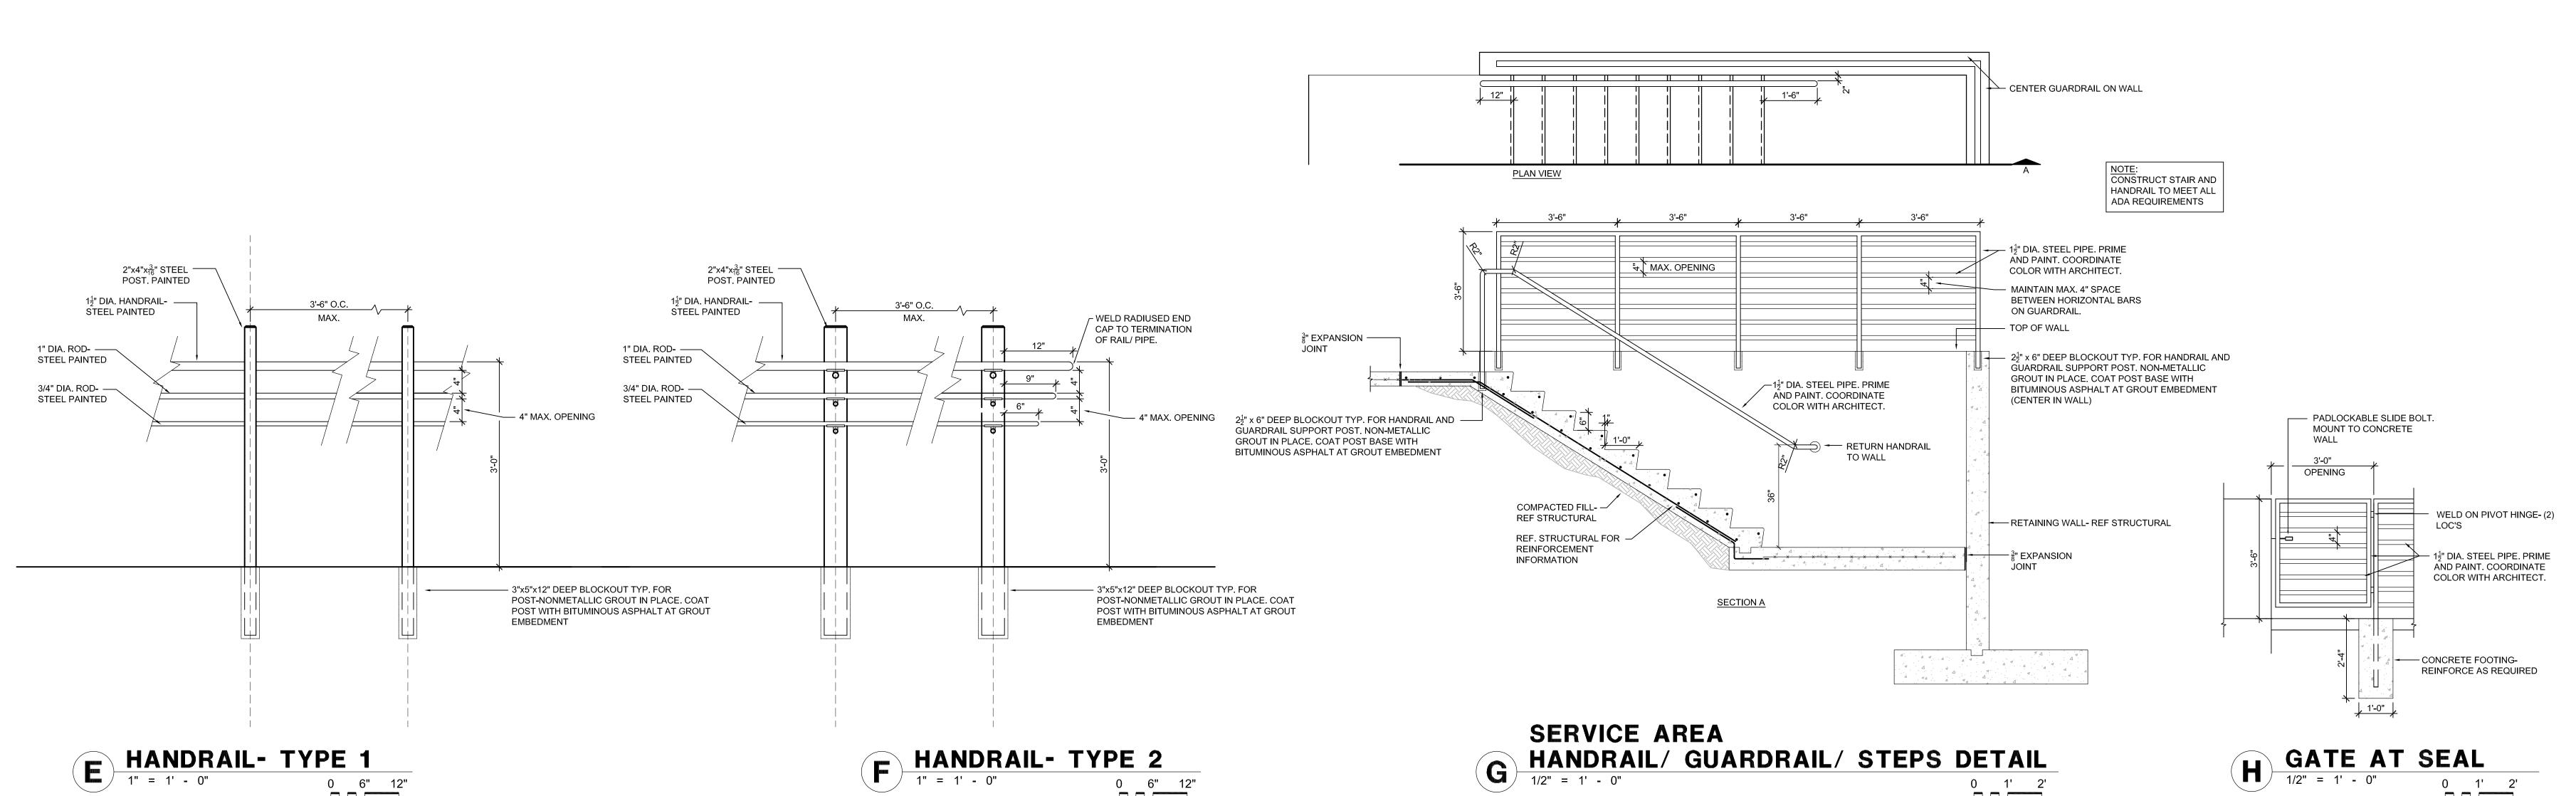



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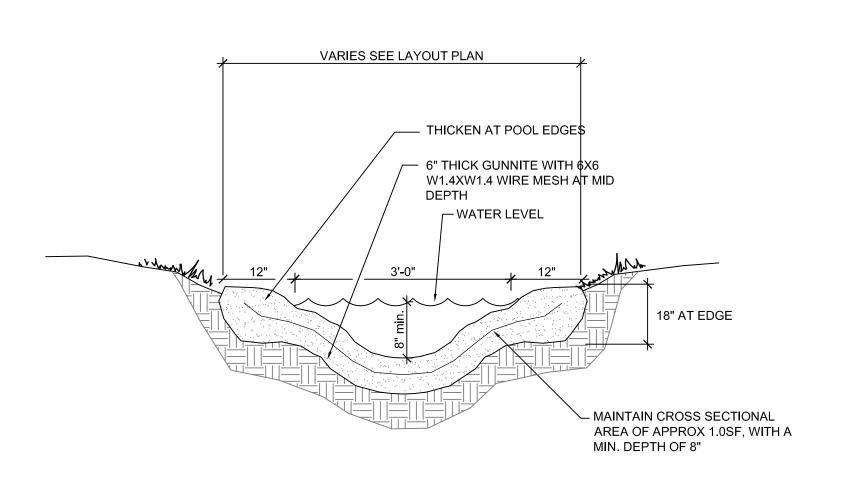
ARCTIC

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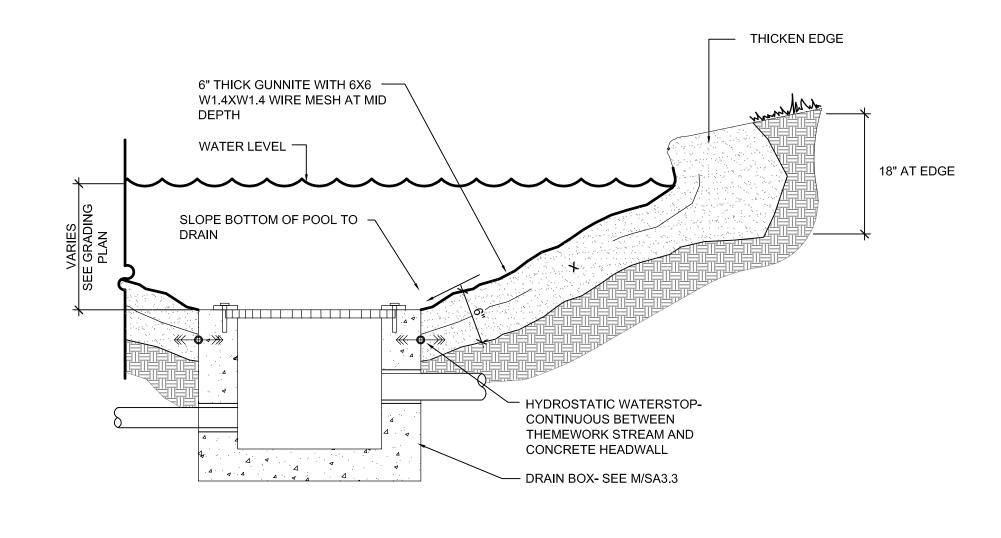
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WDM No. drawn: NS checked: SR HANDRAIL/ GUARDRAIL DETAILS

SA3.1




SECTION THRU GRIZZLY STREAM 3/4" = 1' - 0" 0 8" 1'-4"




THEME EXPOSED PORTION OF CONCRETE HEADWALL POOL EDGE BEYOND ---_12" CONCRETE PIPE /- SLOPE PER ┌ COLD JOINT **GRADING PLAN** SEAL JOINT WITH CONCRETE SEALANT - INTEGRAL WATERPROOFING IN SHOTCRETE HYDROSTATIC -- WATERPROOFING WATERSTOP-REF SYSTEM 2 ENLARGED STREAM PLAN


SECTION THRU GRIZZLY STREAM 0 8" 1'-4"

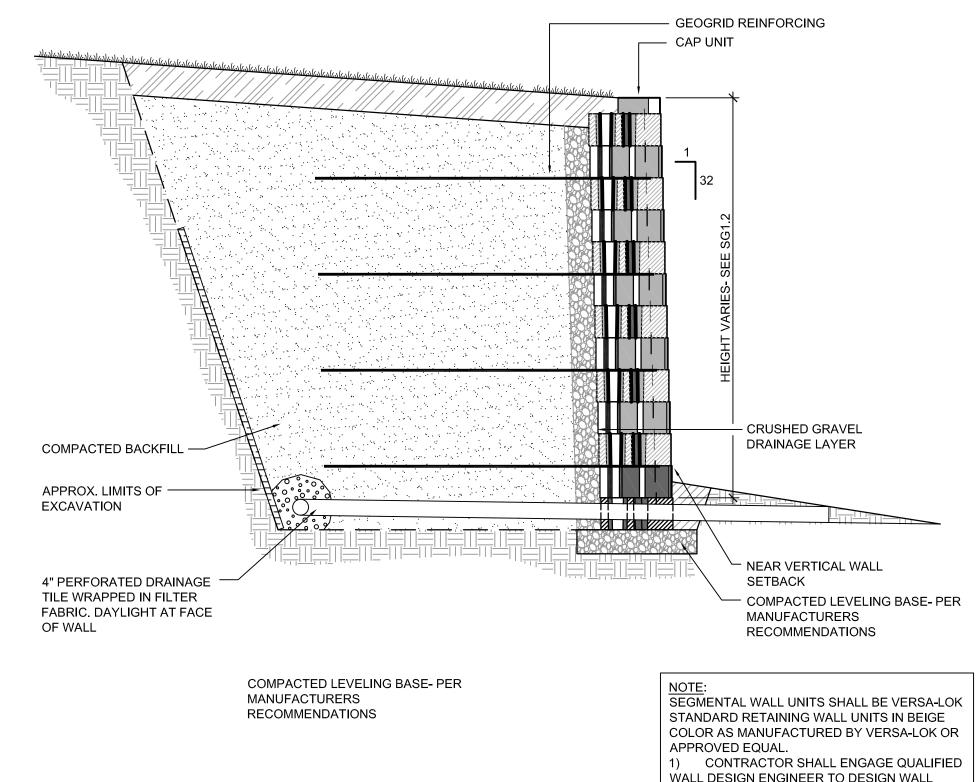

SEGMENTAL BLOCK RETAINING WALL 1/2" = 1' - 0"

SECTION THRU GRIZZLY STREAM 3/4" = 1' - 0"

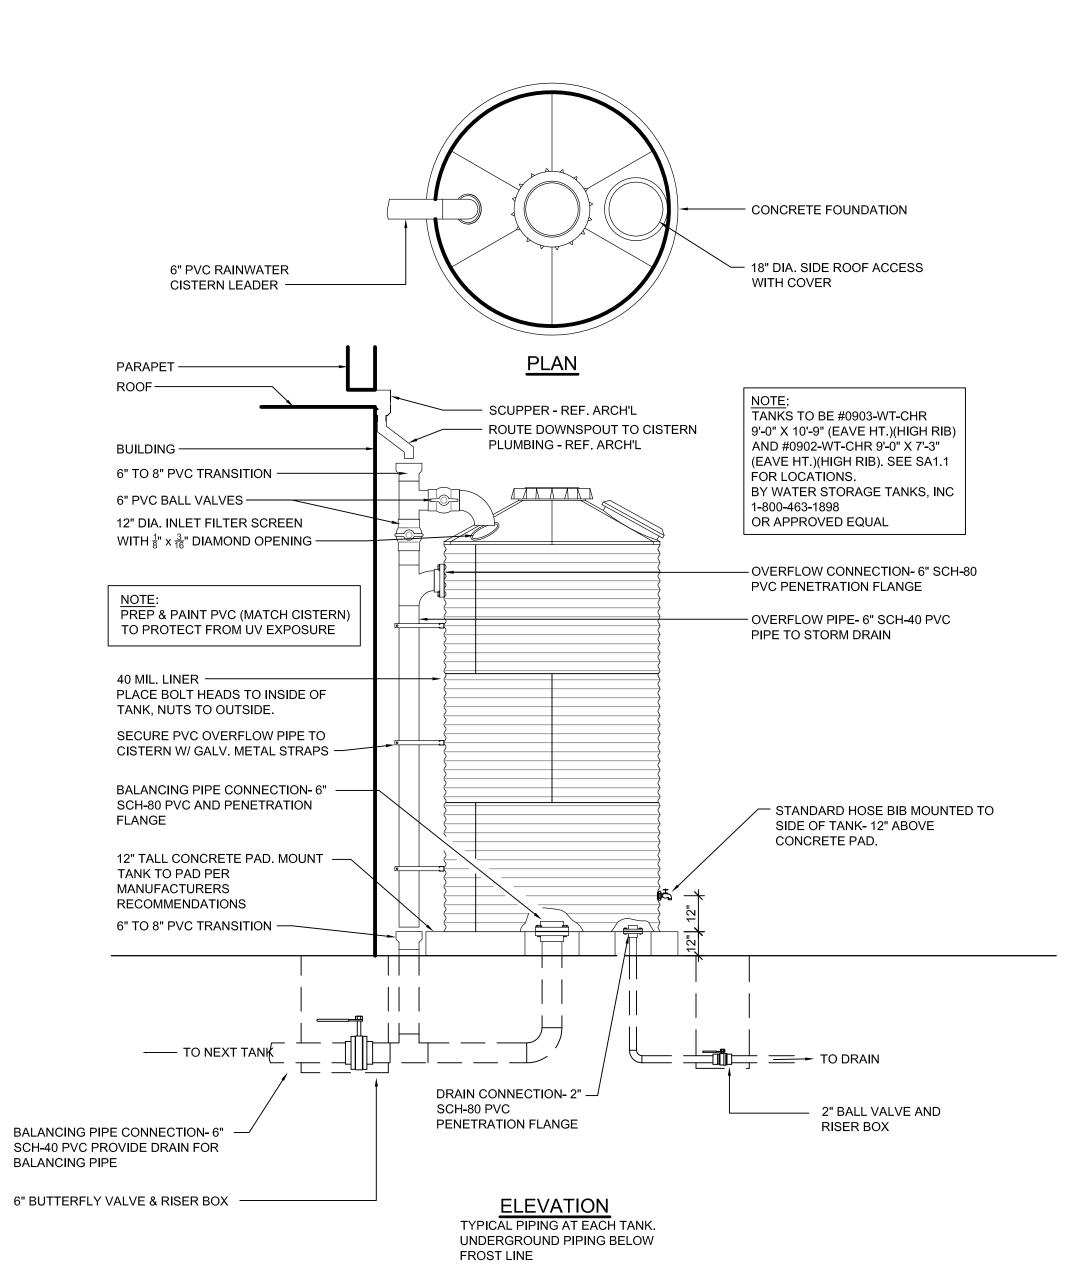

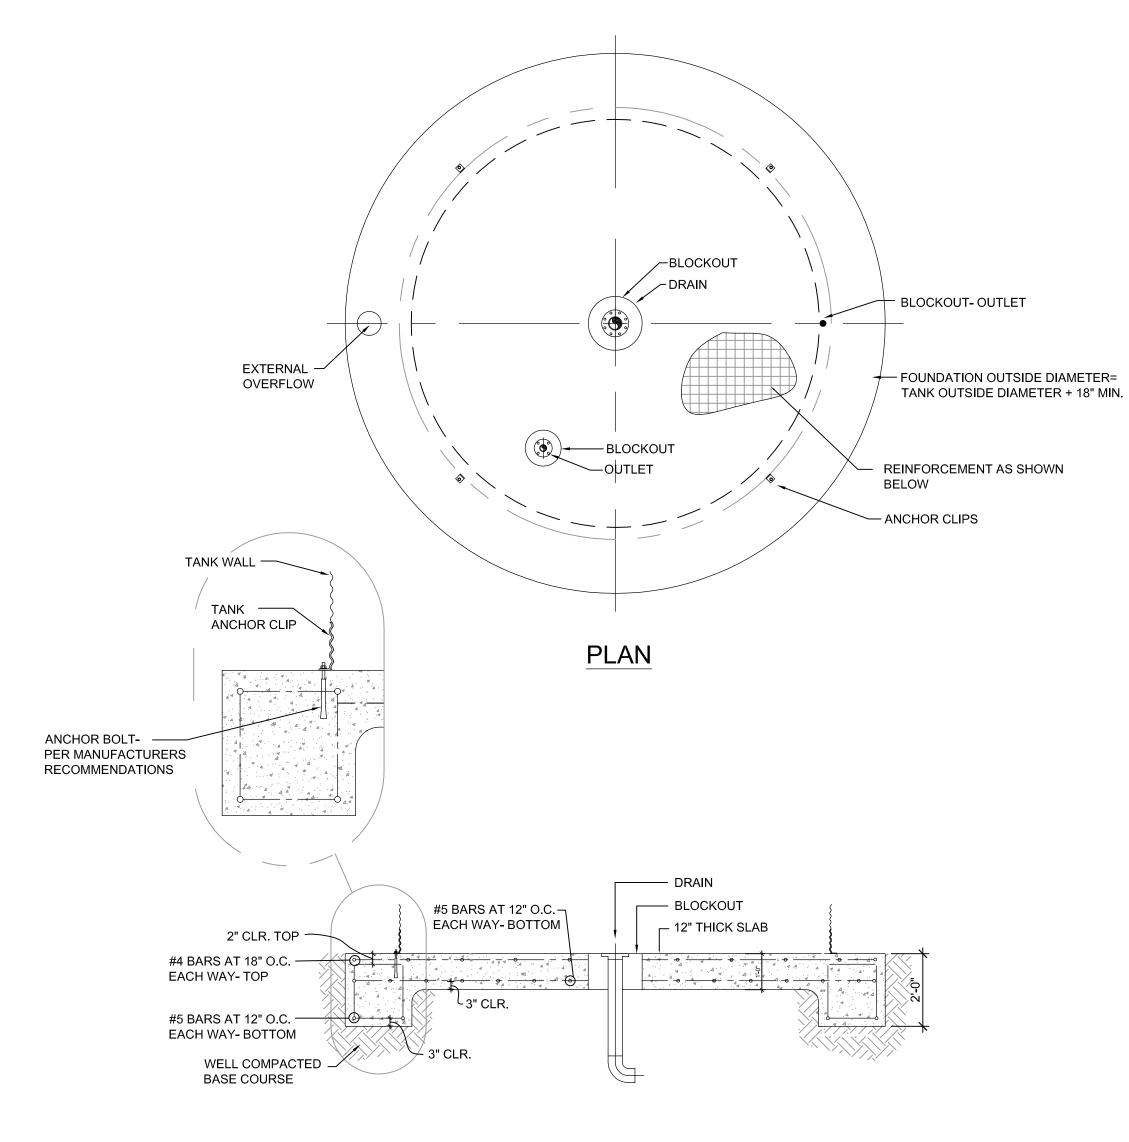

SECTION 'A-A'

1) BASIS OF DESIGN- WATER STORAGE TANK SHALL BE A CORGAL MODEL 0903-WT-CHR OR APPROVED EQUAL WITH STANDARD 30 DEGREE HIGH-RIB ROOF HAVING A NOMINAL CAPACITY OF 5,000 US

2) NOMINAL TANK DIMENSIONS SHALL BE 9'-0" DIAMETER, 10'-9" EAVE HEIGHT, AND 13'-7" OVERALL HEIGHT.

3) THE WATER STORAGE TANK SHALL BE DESIGNED TO STORE WATER WITH A DENSITY OF 62.4 PCF IN A SEISMIC ZONE 2B WITH A WIND SPEED OF 90 MPH, UBC EXPOSURE C.

4) THE TANK STRUCTURE SHALL CONSIST OF CORRUGATED GALVANIZED AND CURVED STEEL WALL SHEETS, CORRUGATED GALVANIZED STEEL HIGH-RIB ROOF PANELS, STANDARD ROOF PEAK ACCESS AND CAP, ANCHOR CLIPS AND NECESSARY HARDWARE FOR TANK ASSEMBLY. PRESS-ON BULB TYPE NEOPRENE EAVE SEAL SHALL BE USED BETWEEN THE TOP WALL PANEL AND THE ROOF PANEL.

5) ALL STEEL PANEL MATERIAL SHALL BE GALVANIZED TO MEET THE G-115 GALVANIZING STANDARD.

6) BOLTS SHALL BE HEAT TREATED TO GRADE SAE 8.2 AND ELECTRO-GALVANIZED WITH JS-500 CLEAR COATING.

7) ROOF BOLTS SHALL HAVE FACTORY INSTALLED, STEEL-BACKED VINYL WASHERS.

8) WALL BOLTS SHALL HAVE SLOTTED BUTTON HEADS FOR INSERTION FROM INSIDE THE TANK TOWARD OUTSIDE.

9) WATER CONTAINMENT SYSTEM SHALL CONSIST OF LINER HANGER BRACKETS, A GEO-TEXTILE PRE-LINER INSTALLED ON THE FOUNDATION AND THE INTERIOR OF THE WALLS AND A 25 MIL. PVC FACTORY WELDED SEAM, FLEXIBLE MEMBRANE MAIN LINER.

10) THE WATER TANK SHALL BE CONSTRUCTED ON A CONCRETE FOUNDATION. SEE DETAILS.

WDM No.

POOL DETAILS

checked: SR

SA3.2

RAINWATER COLLECTION TANK

3/8" = 1' - 0"

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NON-TOXIC WATERPROOF HYDROSTATIC WATERSTOP-CONTINUOUS BETWEEN THEMEWORK STREAM AND CONCRETE HEADWALL FOR LOCATION

WALL DESIGN ENGINEER TO DESIGN WALL SYSTEM. SUBMIT DRAWINGS FOR REVIEW.

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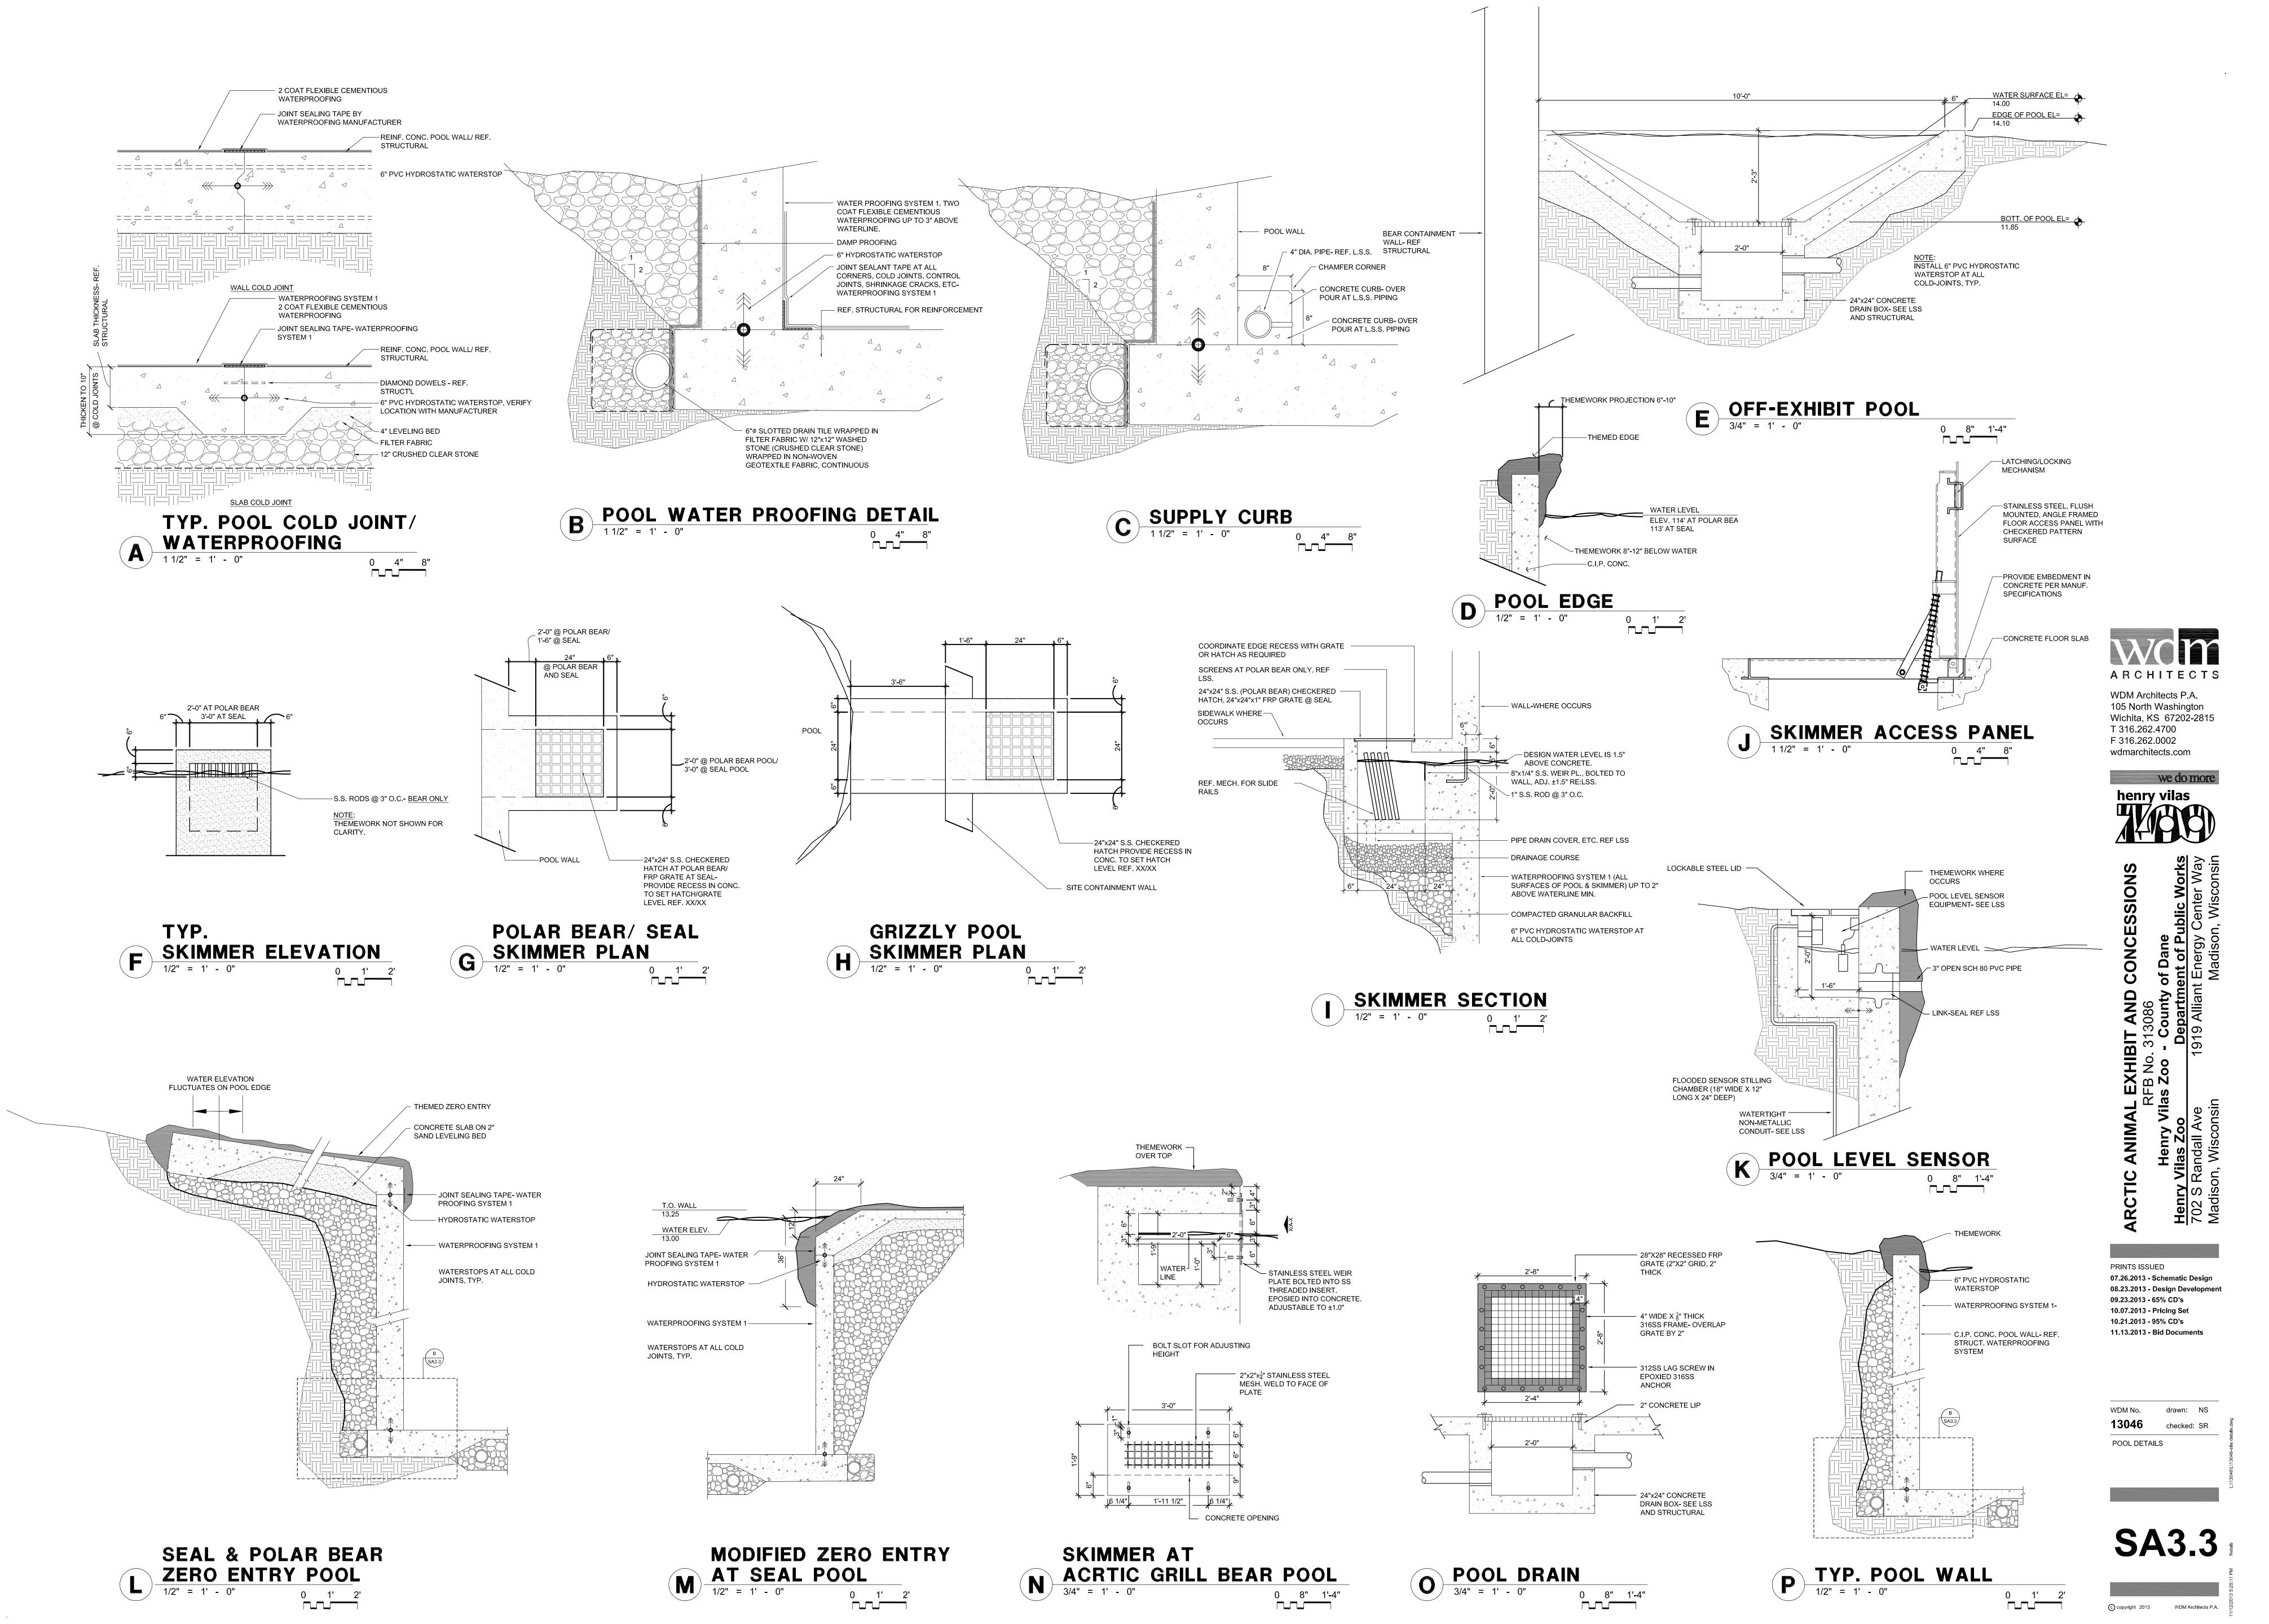
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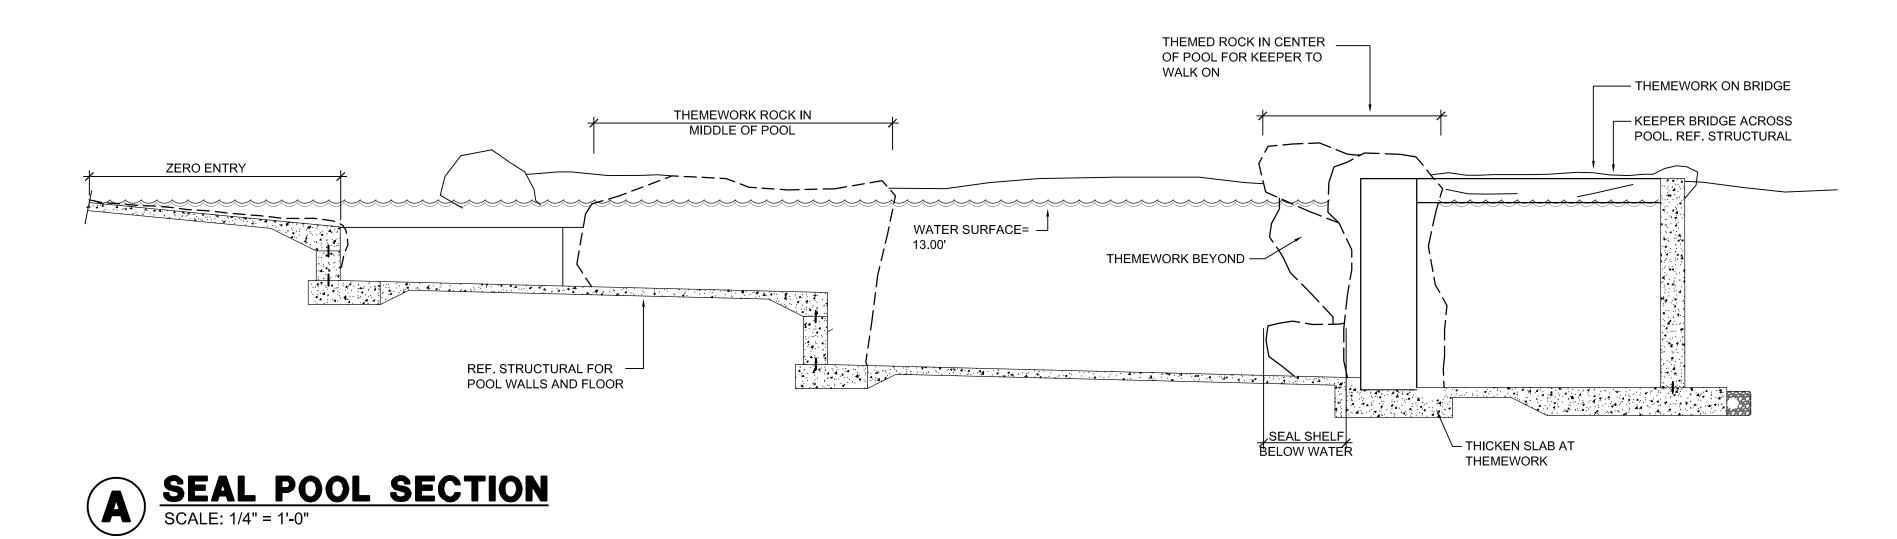


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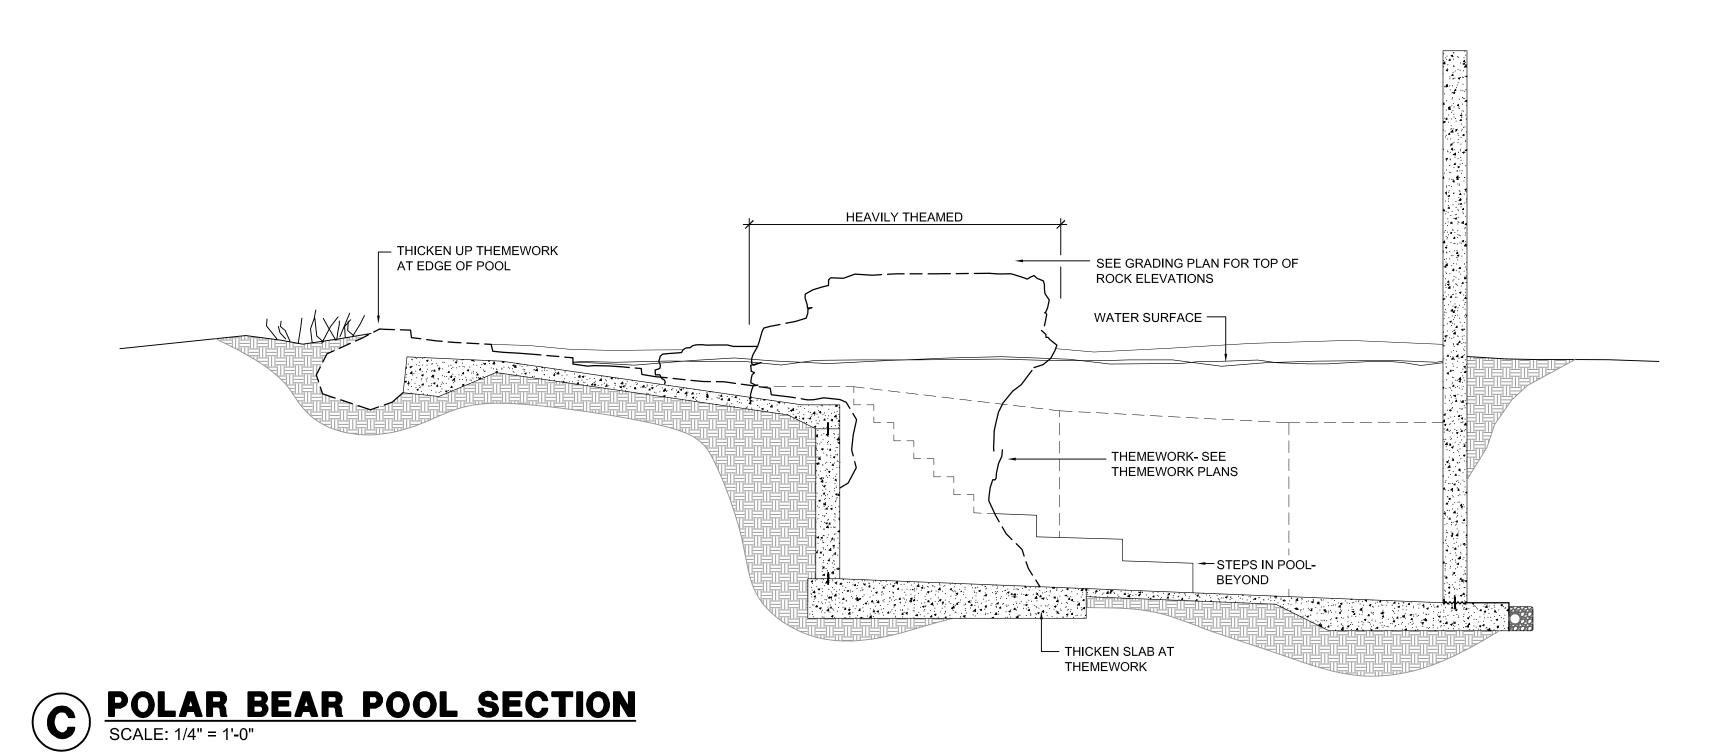
C





BEAR CONTAINMENT WALL -EDGE OF ZERO ENTRY POOL SLAB -----THEME OVER EDGE OF UPPER POOL SLAB 12" TO 18". MINIMAL THEMEWORK BELOW. WATER SURFACE — THEMEWORK ROCK- AT EDGE OF POOL REF. STRUCTURAL FOR — POOL WALLS AND FLOOR KEEPER STEPS

B POLAR BEAR POOL SECTION
SCALE: 1/4" = 1'-0"



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ARCTIC

13046 SITE SECTIONS

SA4.0 gags.

NOTE:

1) WALLS ARE COLORED CONCRETE AS SHOWN.
2) EACH WALL PANEL TO BE POURED CONTINUOUSLY WITHOUT A COLD JOINT.
3) USE FORMING SYSTEM WITH 4X8 RUNNING BOND PATTERN OR LINE FORMS WITH ½" SMOOTH LINER (EG MASONITE) WITH JOINTS IN 4X8 RUNNING BOND PATTERN. HORIZONTAL JOINTS CANNOT BE STAGGERED WITHIN A GIVEN WALL PANEL, BUT CAN STEP FROM ONE WALL PANEL TO THE NEXT.
4) FORM TIES LEFT IN PLACE TO BE STAINLESS STEEL. FORM TIE SPACING TO BE IN NEAT/ EVEN ROWS HORIZONTALLY AND VERTICALLY. FORM TIE HOLES TO BE PATCHED NEATLY WITHOUT OVERLAP ONTO ADJACENT WALL SURFACE. COLOR MATCHING TO BE


DONE BY SOMEONE WITH 10 YEARS EXPERIENCE IN COLOR MATCHING CONCRETE.

7) REVEALS RANGE FROM 3"X4'-0"X\frac{5}{8}" TO 5"X12'-0"X\frac{5}{8}", ALL EDGES BEVELED.\frac{1}{2} OF REVEALS TOUCH THE TOP OF WALL. REVEALS COVER \frac{3}{4} OF VERTICAL JOINTS IN FORMLINER. TYPICAL 17' TALL X 24' WIDE WALL PANEL TO HAVE 18-22 VERTICAL REVEALS.

8) STRIP FORMS WITHIN 24 HOURS AND REMOVE FINS AND

PROJECTIONS.

33.83 **TOP OF WALL** ALL COLORS BY DAVIS COLORS OR INTEGRAL CONCRETE COLOR-APPROVED EQUAL (1-800-356-4848) MIN. WALL HEIGHT ——— 31.25 TOP OF WALL REQUIRED TO MAINTAIN 32.12 TOP OF WALL 17'-0" CONTAINMENT HEIGHT. ♦ 31.86 TOP OF WALL 29.00 TOP OF WALL 29.00 TOP OF WALL ♦ 22.00 TOP OF WALL \ ◆ 22.50
 TOP OF WALL \ 25.50 TOP OF WALL L INTEGRAL CONCRETE COLOR- OUTBACK - INTEGRAL CONCRETE COLOR- <u>SILVERSMOKE</u> INTEGRAL CONCRETE US COLOR- SILVERSMOKE 09.00 INTEGRAL CONCRETE COLOR-<u>MESQUITE</u> - INTEGRAL CONCRETE COLOR- SILVERSMOKE GRADE IN BEAR YARD INTEGRAL CONCRETE COLOR-B CONTAINMENT WALL ELEVATION
SCALE: 1/8" = 1'-0" <u>MESQUITE</u> NOTE: CUSTOM REVEALS/ FORM LINER ALT. BOTH SIDES OF WALL.

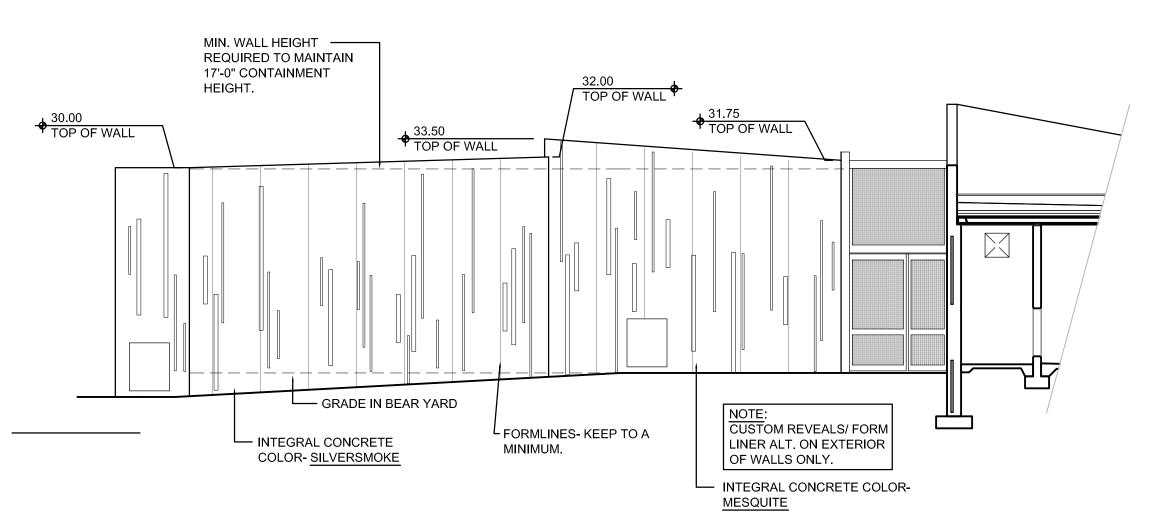

31.92
TOP OF WALL

INTEGRAL CONCRETE COLOR-MESQUITE

C CONTAINMENT WALL ELEVATION


SCALE: 1/8" = 1'-0"

CONTAINMENT WALL ELEVATION

SCALE: 1/8" = 1'-0"



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Henry Vilas Zoo
Henry Vilas Zoo
702 S Randall Ave
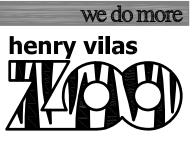
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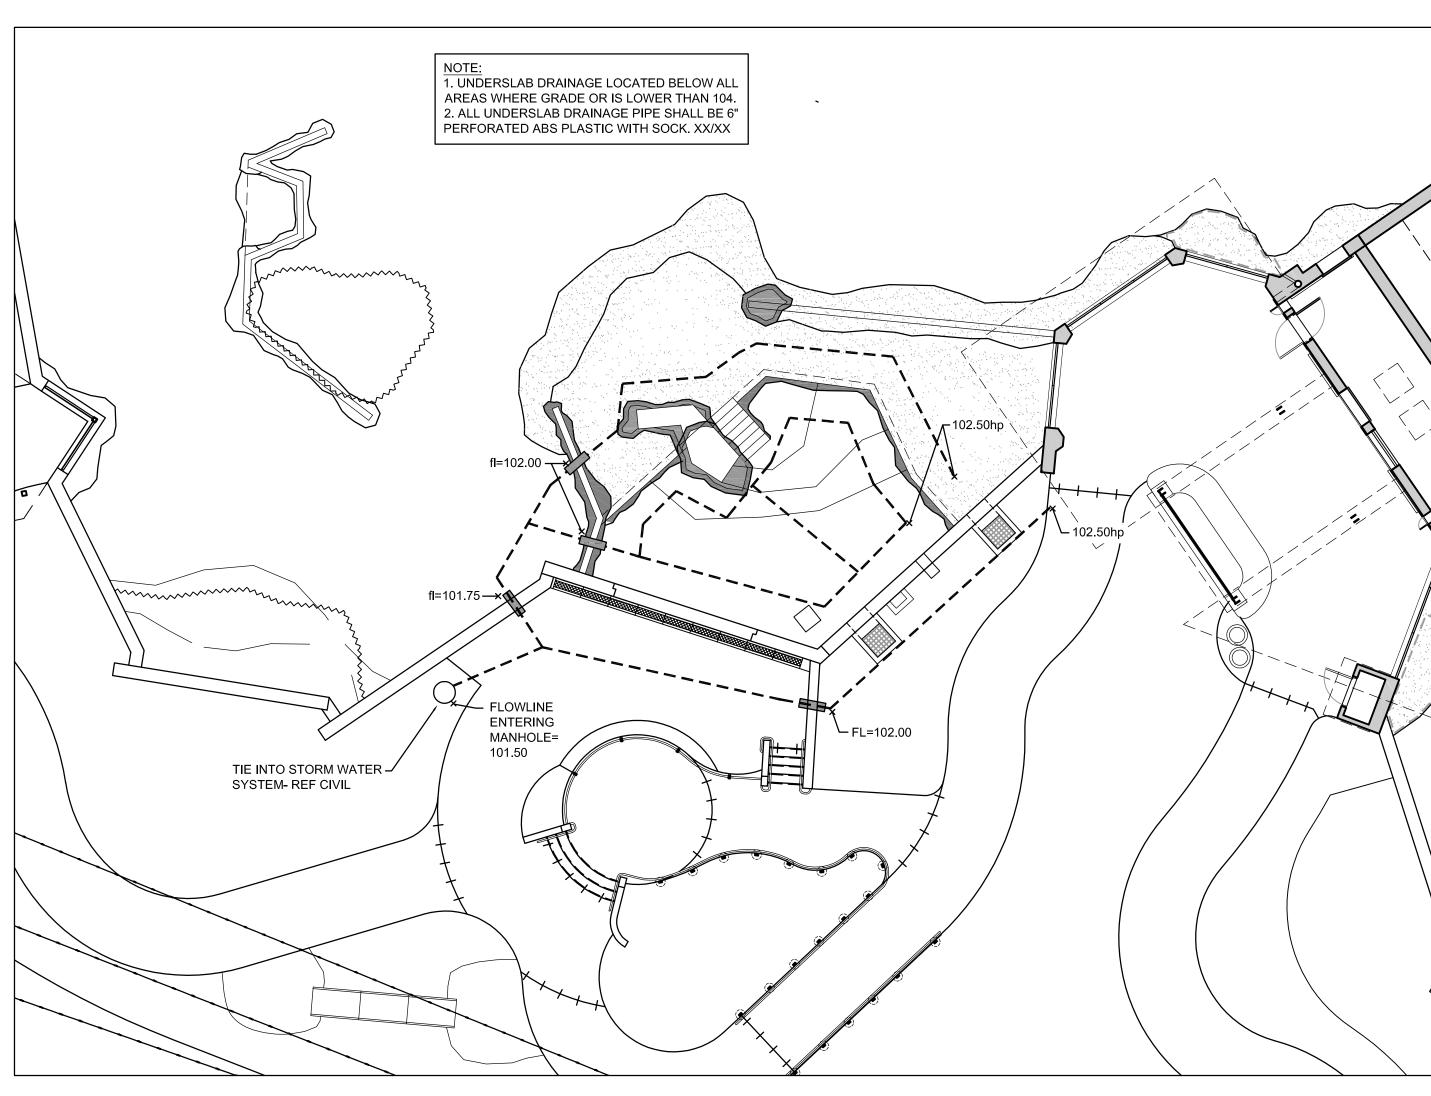
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SITE SECTIONS

SA5.0

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POLAR BEAR POOL
UNDERSLAB DRAINAGE PLAN


SCALE: 1" = 10'

OCCUPATION

OCCUPATI

UNDERSLAB6" SLOTTED DRAIN TILE IN 12" LAYER OF CRUSHED CLEAR STONE, SURROUNDED BY NON-WOVEN GEO-TEXTILE FABRIC.

FOOTING PERIMETER6" SLOTTED DRAIN TILE SURROUNDED BY 12" X 12" OF CRUSHED CLEAR STONE, SURROUNDED BY NON-WOVEN GEO-TEXTILE FABRIC.

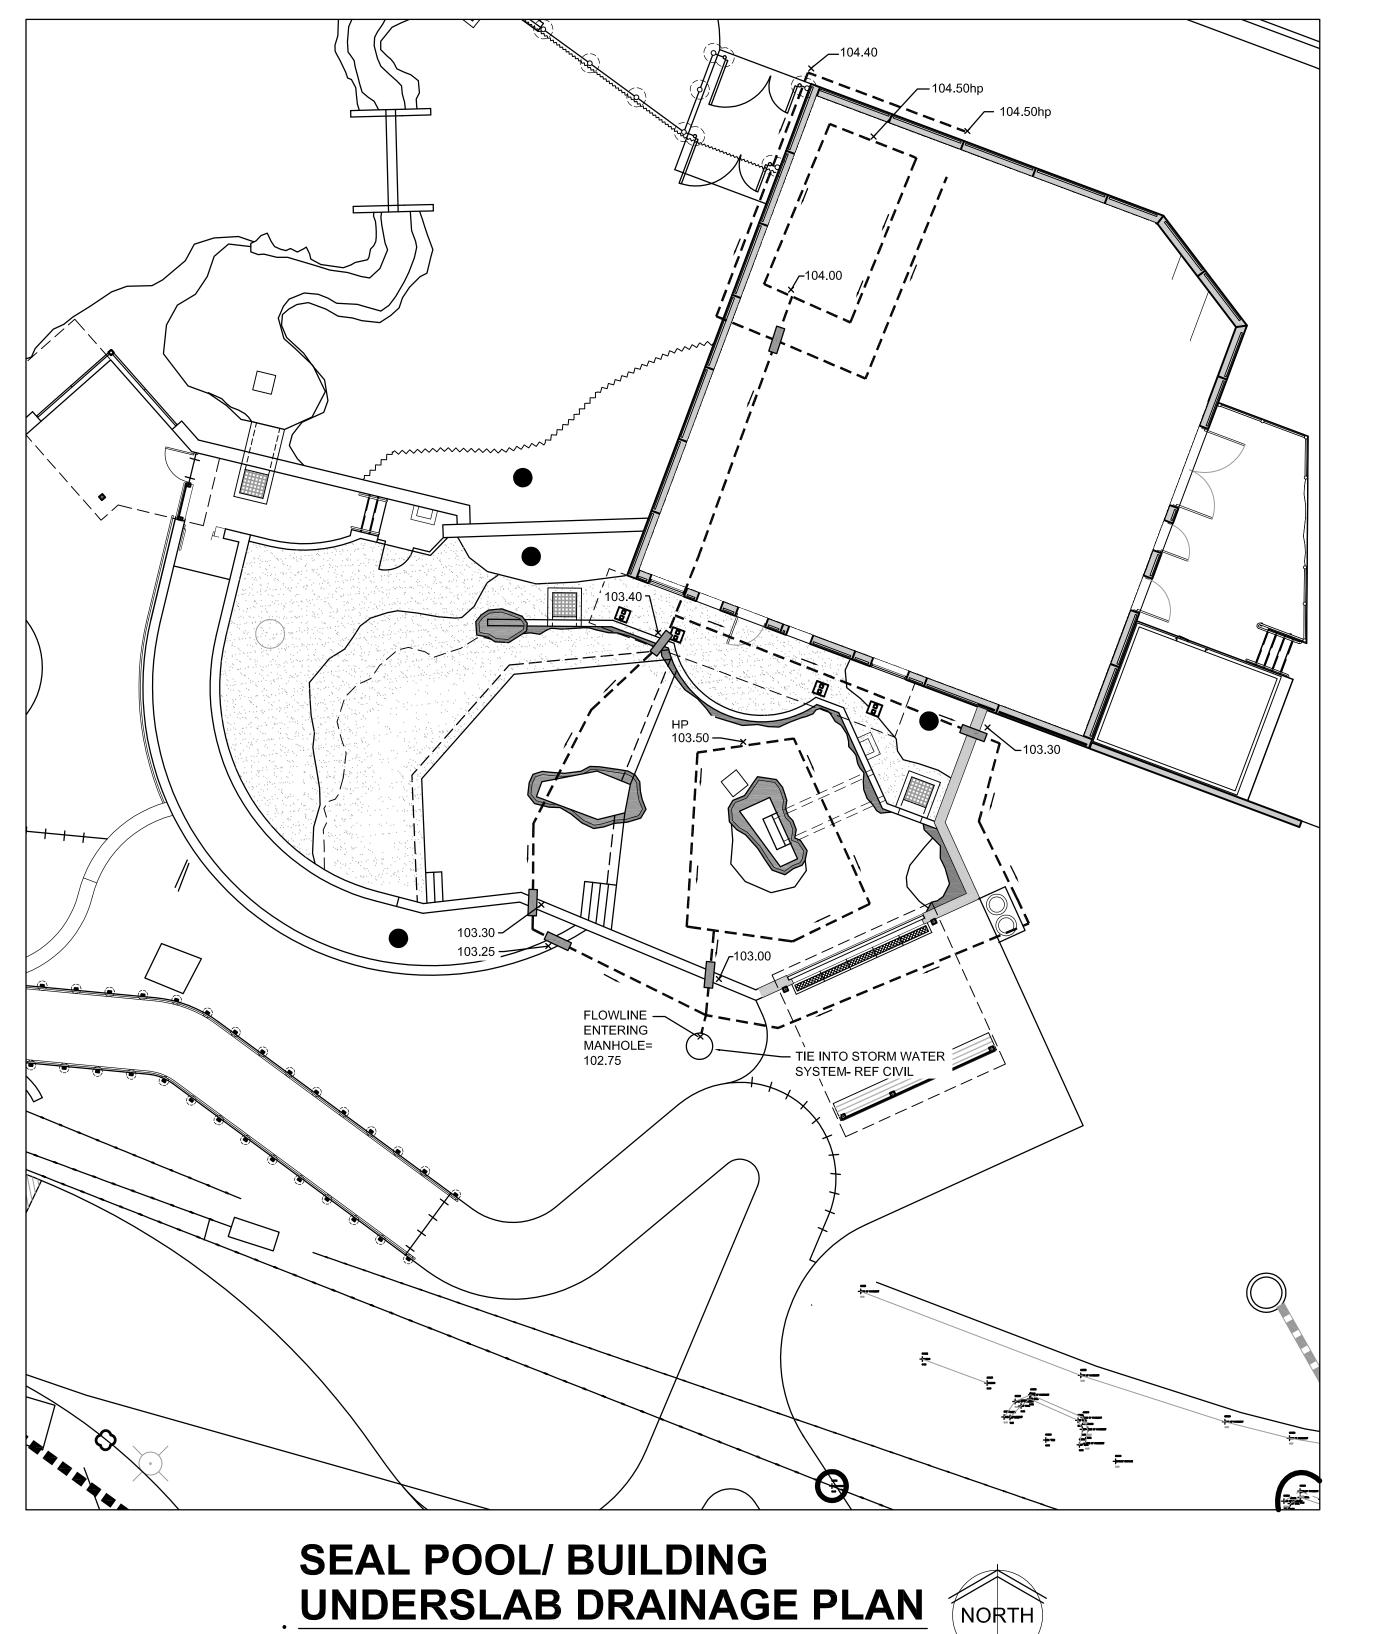


NOTE:

1. UNDERSLAB DRAINAGE LOCATED BELOW ALL AREAS WHERE GRADE OR IS LOWER THAN 104.

2. ALL UNDERSLAB DRAINAGE PIPE SHALL BE 6" PERFORATED ABS PLASTIC WITH SOCK, SIM, XX,XX



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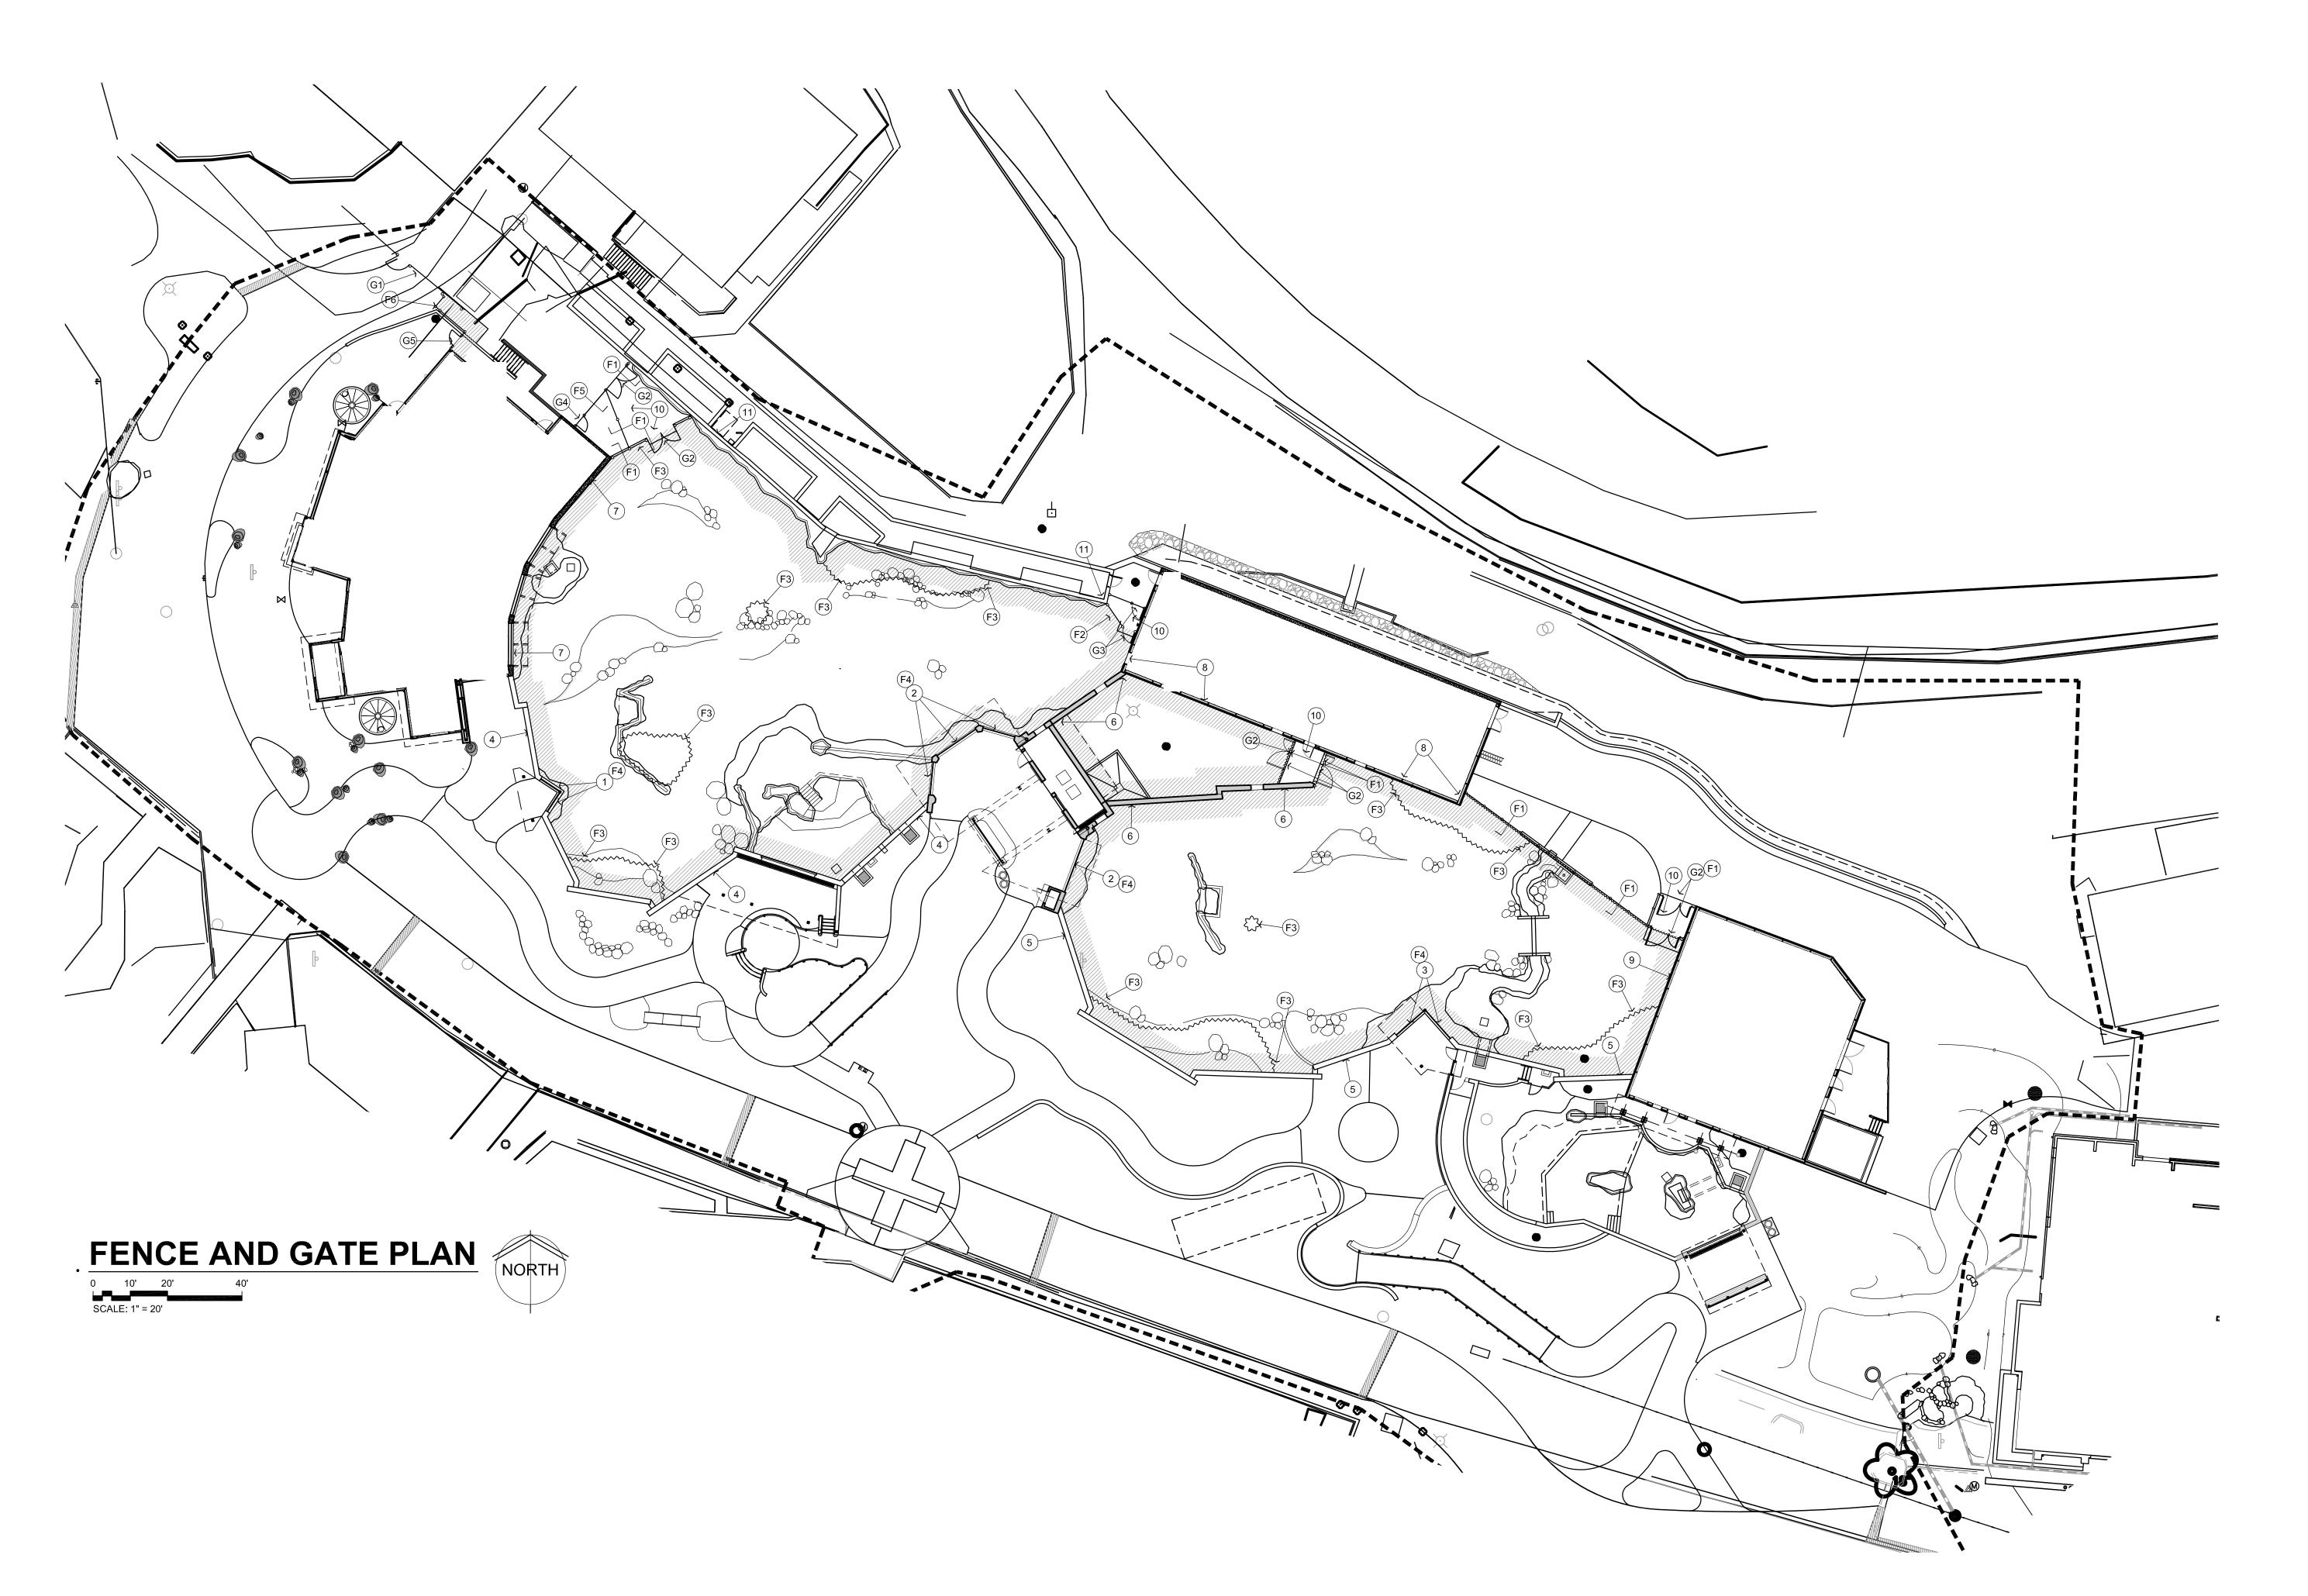
3046 checked: SR

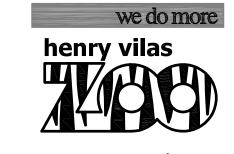MDM No. drawn: NS

13046 checked: SR

UNDERSLAB DRAINAGE PLAN

SA6.0 gas



FENCE TYPES

- (F1) CHAIN-LINK BEAR CONTAINMENT FENCE- REFER TO 1/SA7.1
- F2 SIM. TO F1; ALSO REFER TO 3/A3.3 & STRUCT.
- F3 HOT GRASS- REFER TO C/SA7.1
- F4) STAINLESS STEEL WOVEN MESH REF. F/SA7.1
- (F5) 8' TALL CHAIN LINK FENCE
- (F6) 6' TALL WOOD FENCE- I/SA7.1

GATE TYPES

- (G1) EXISTING AUTOMATIC CANTILEVER SLIDING GATE TO REMAIN.
- G2 SWING GATE PAIR REF. C9/CW3.1
- G3 SWING GATE- REF. C10/CW3.1
 G4 CHAINLINK SWING GATE
- G5 WOOD GATE- I/SA7.1

KEY NOTES

- 1 CONTAINMENT / VIEW STRUCTURE REF. A/A4.1
- 2 CONTAINMENT / VIEW STRUCTURE REF. A/A4.3
- (3) CONTAINMENT / VIEW STRUCTURE REF. F/A4.1
 (4) CONTAINMENT WALLS REF. SA1.5
- 5 CONTAINMENT WALLS REF. SA1.6
- (5) CONTAINMENT WALLS REF. SA1.6 (6) CONTAINMENT WALLS REF. SA1.7
- 7) CONTAINMENT / CONCESSIONS BUILDING WALLS REF. A1 DRAWINGS
- 8 CONTAINMENT / BEAR HOLDING BUILDING WALLS REF. A3 DRAWINGS
- 9 CONTAINMENT / SEAL HOLDING BUILDING WALLS REF. A5 DRAWINGS
- (10) CHAINLINK CONTAINMENT LID @ VESTIBULE
 (11) CONTAINMENT WALLS REF. SA1.1,M/SA3.0

LEGEND

HOT GRASS PROTECTED AREA

NOTE:
ALL WALLS, BUILDINGS, & FENCES AROUND BEAR
YARDS REQUIRED TO BE 17'-0" FROM GRADE TO TOP
OF CONTAINMENT AT ANY GIVEN POINT AROUND YARD
PERIMETER.



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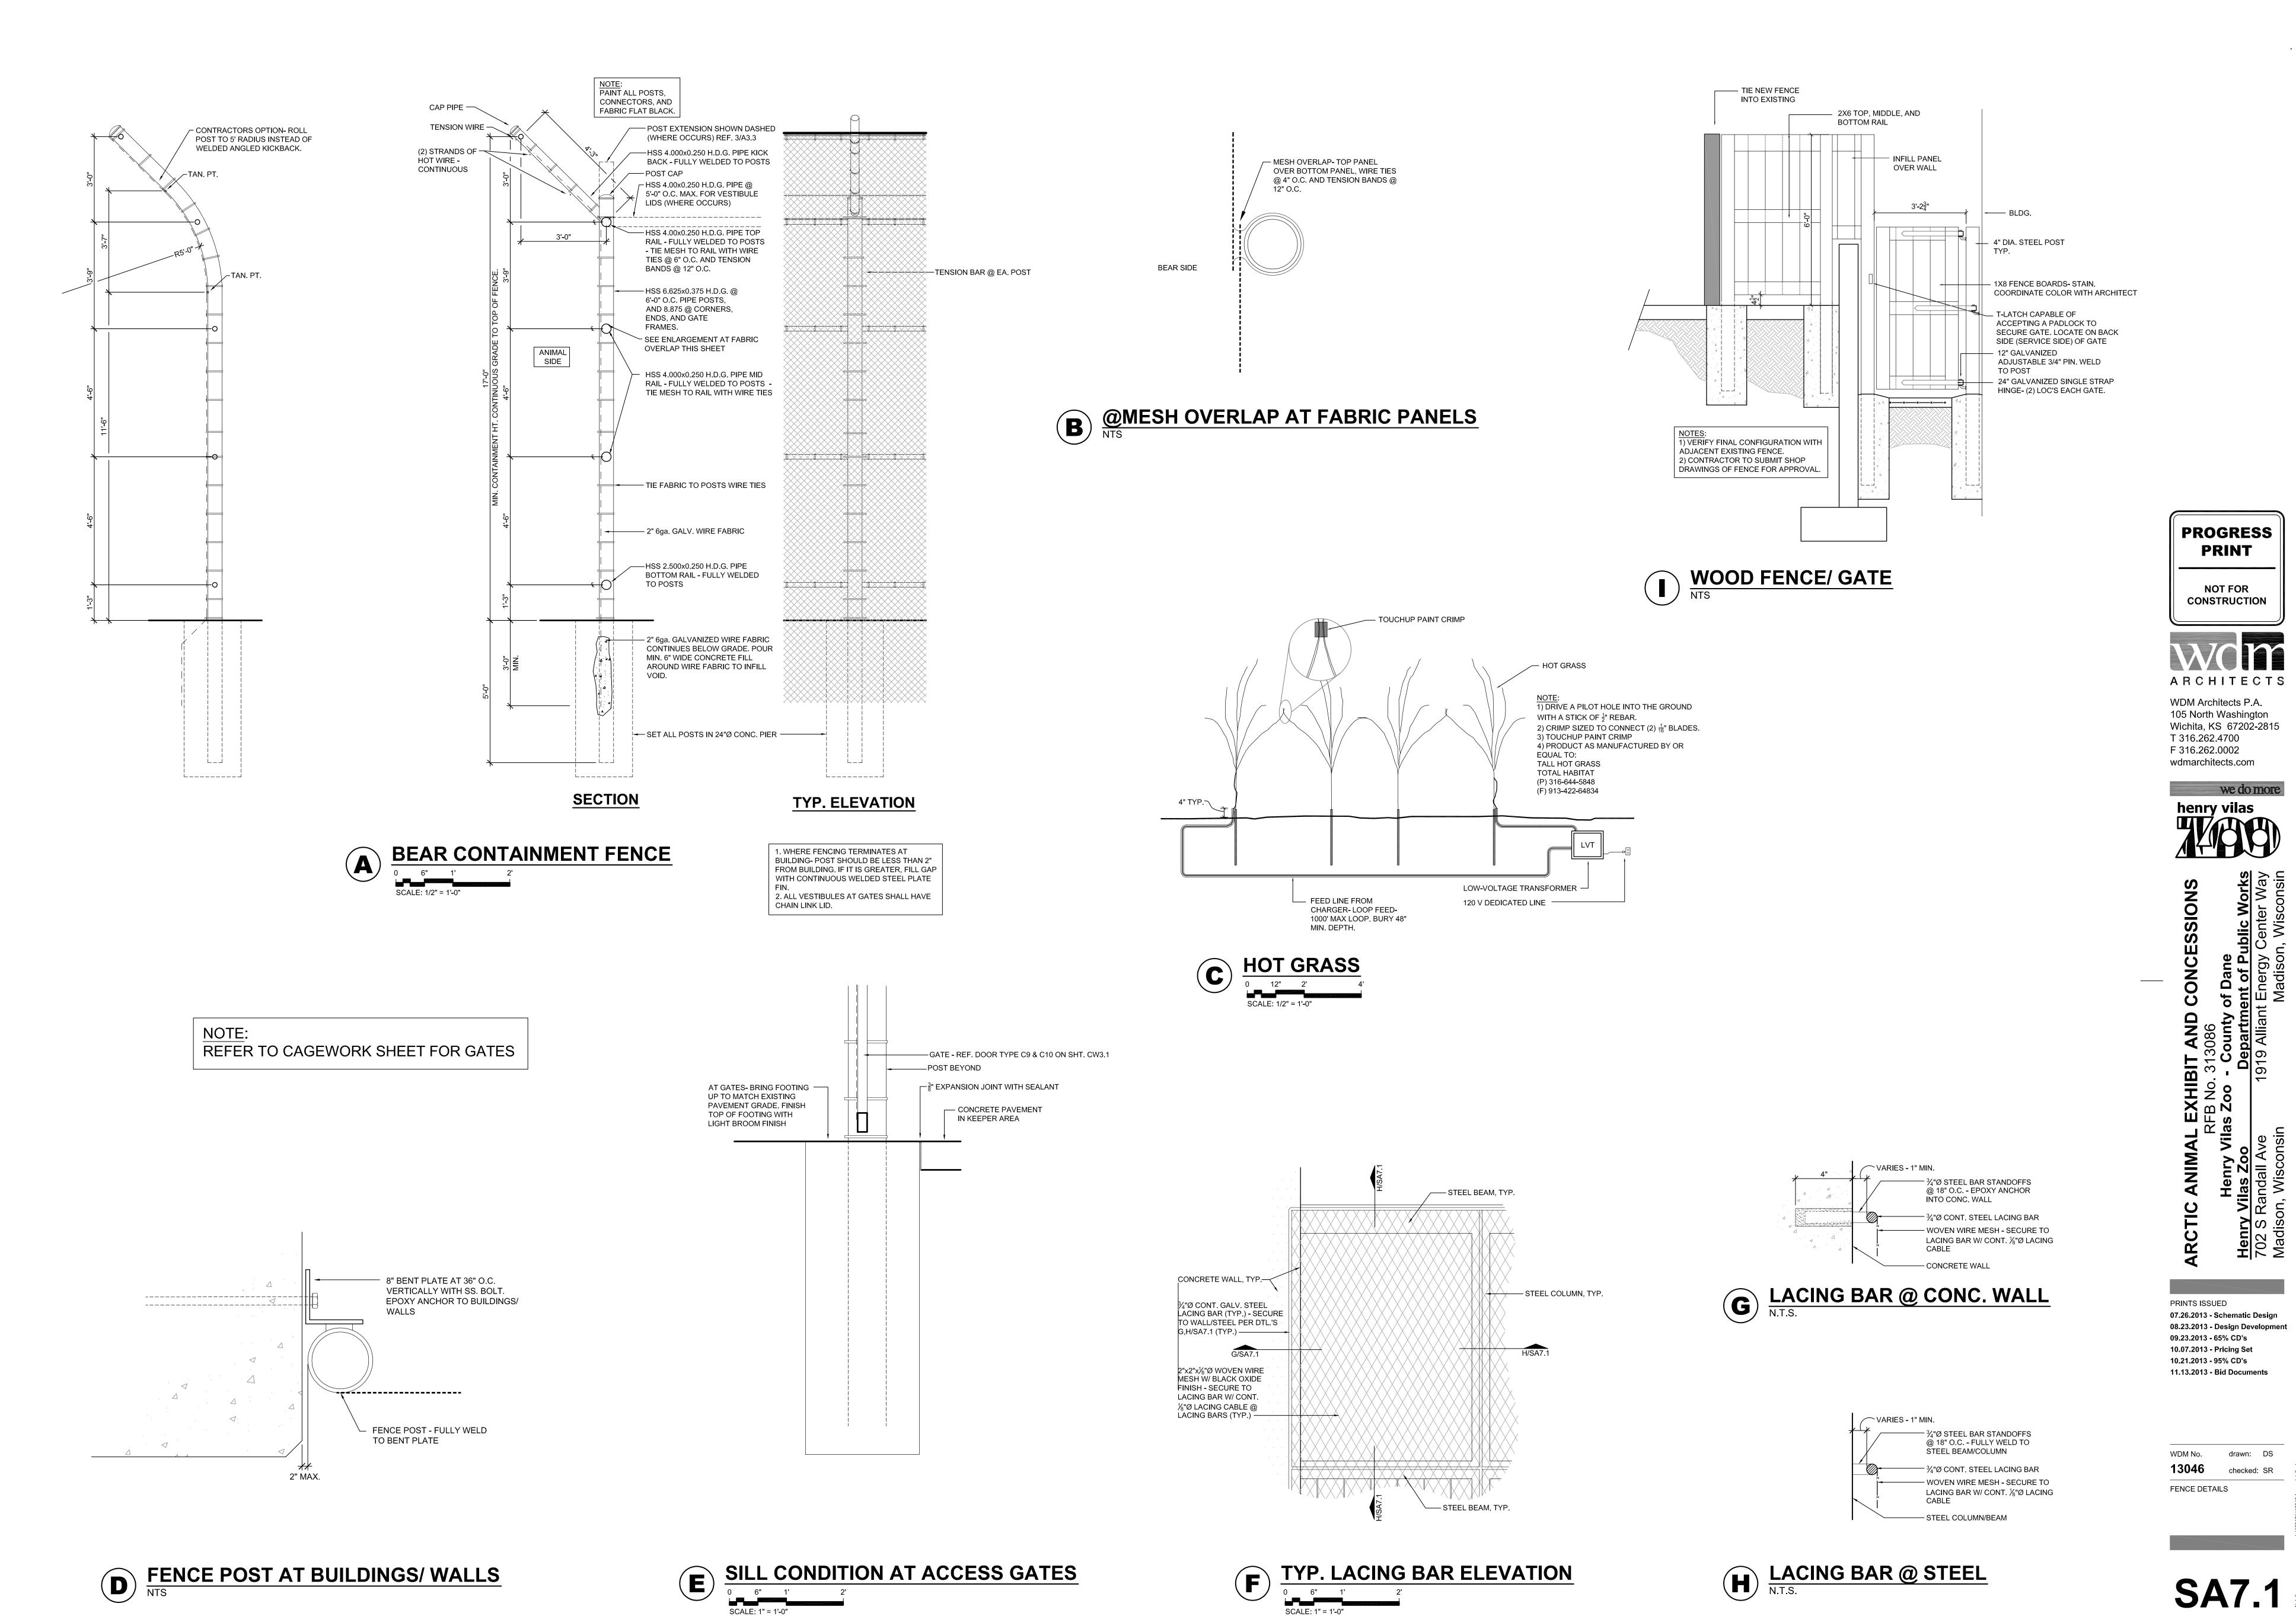
10.21.2013 - 95% CD's


11.13.2013 - Bid Documents

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FENCE AND GATE PLAN

SA7.0 stall



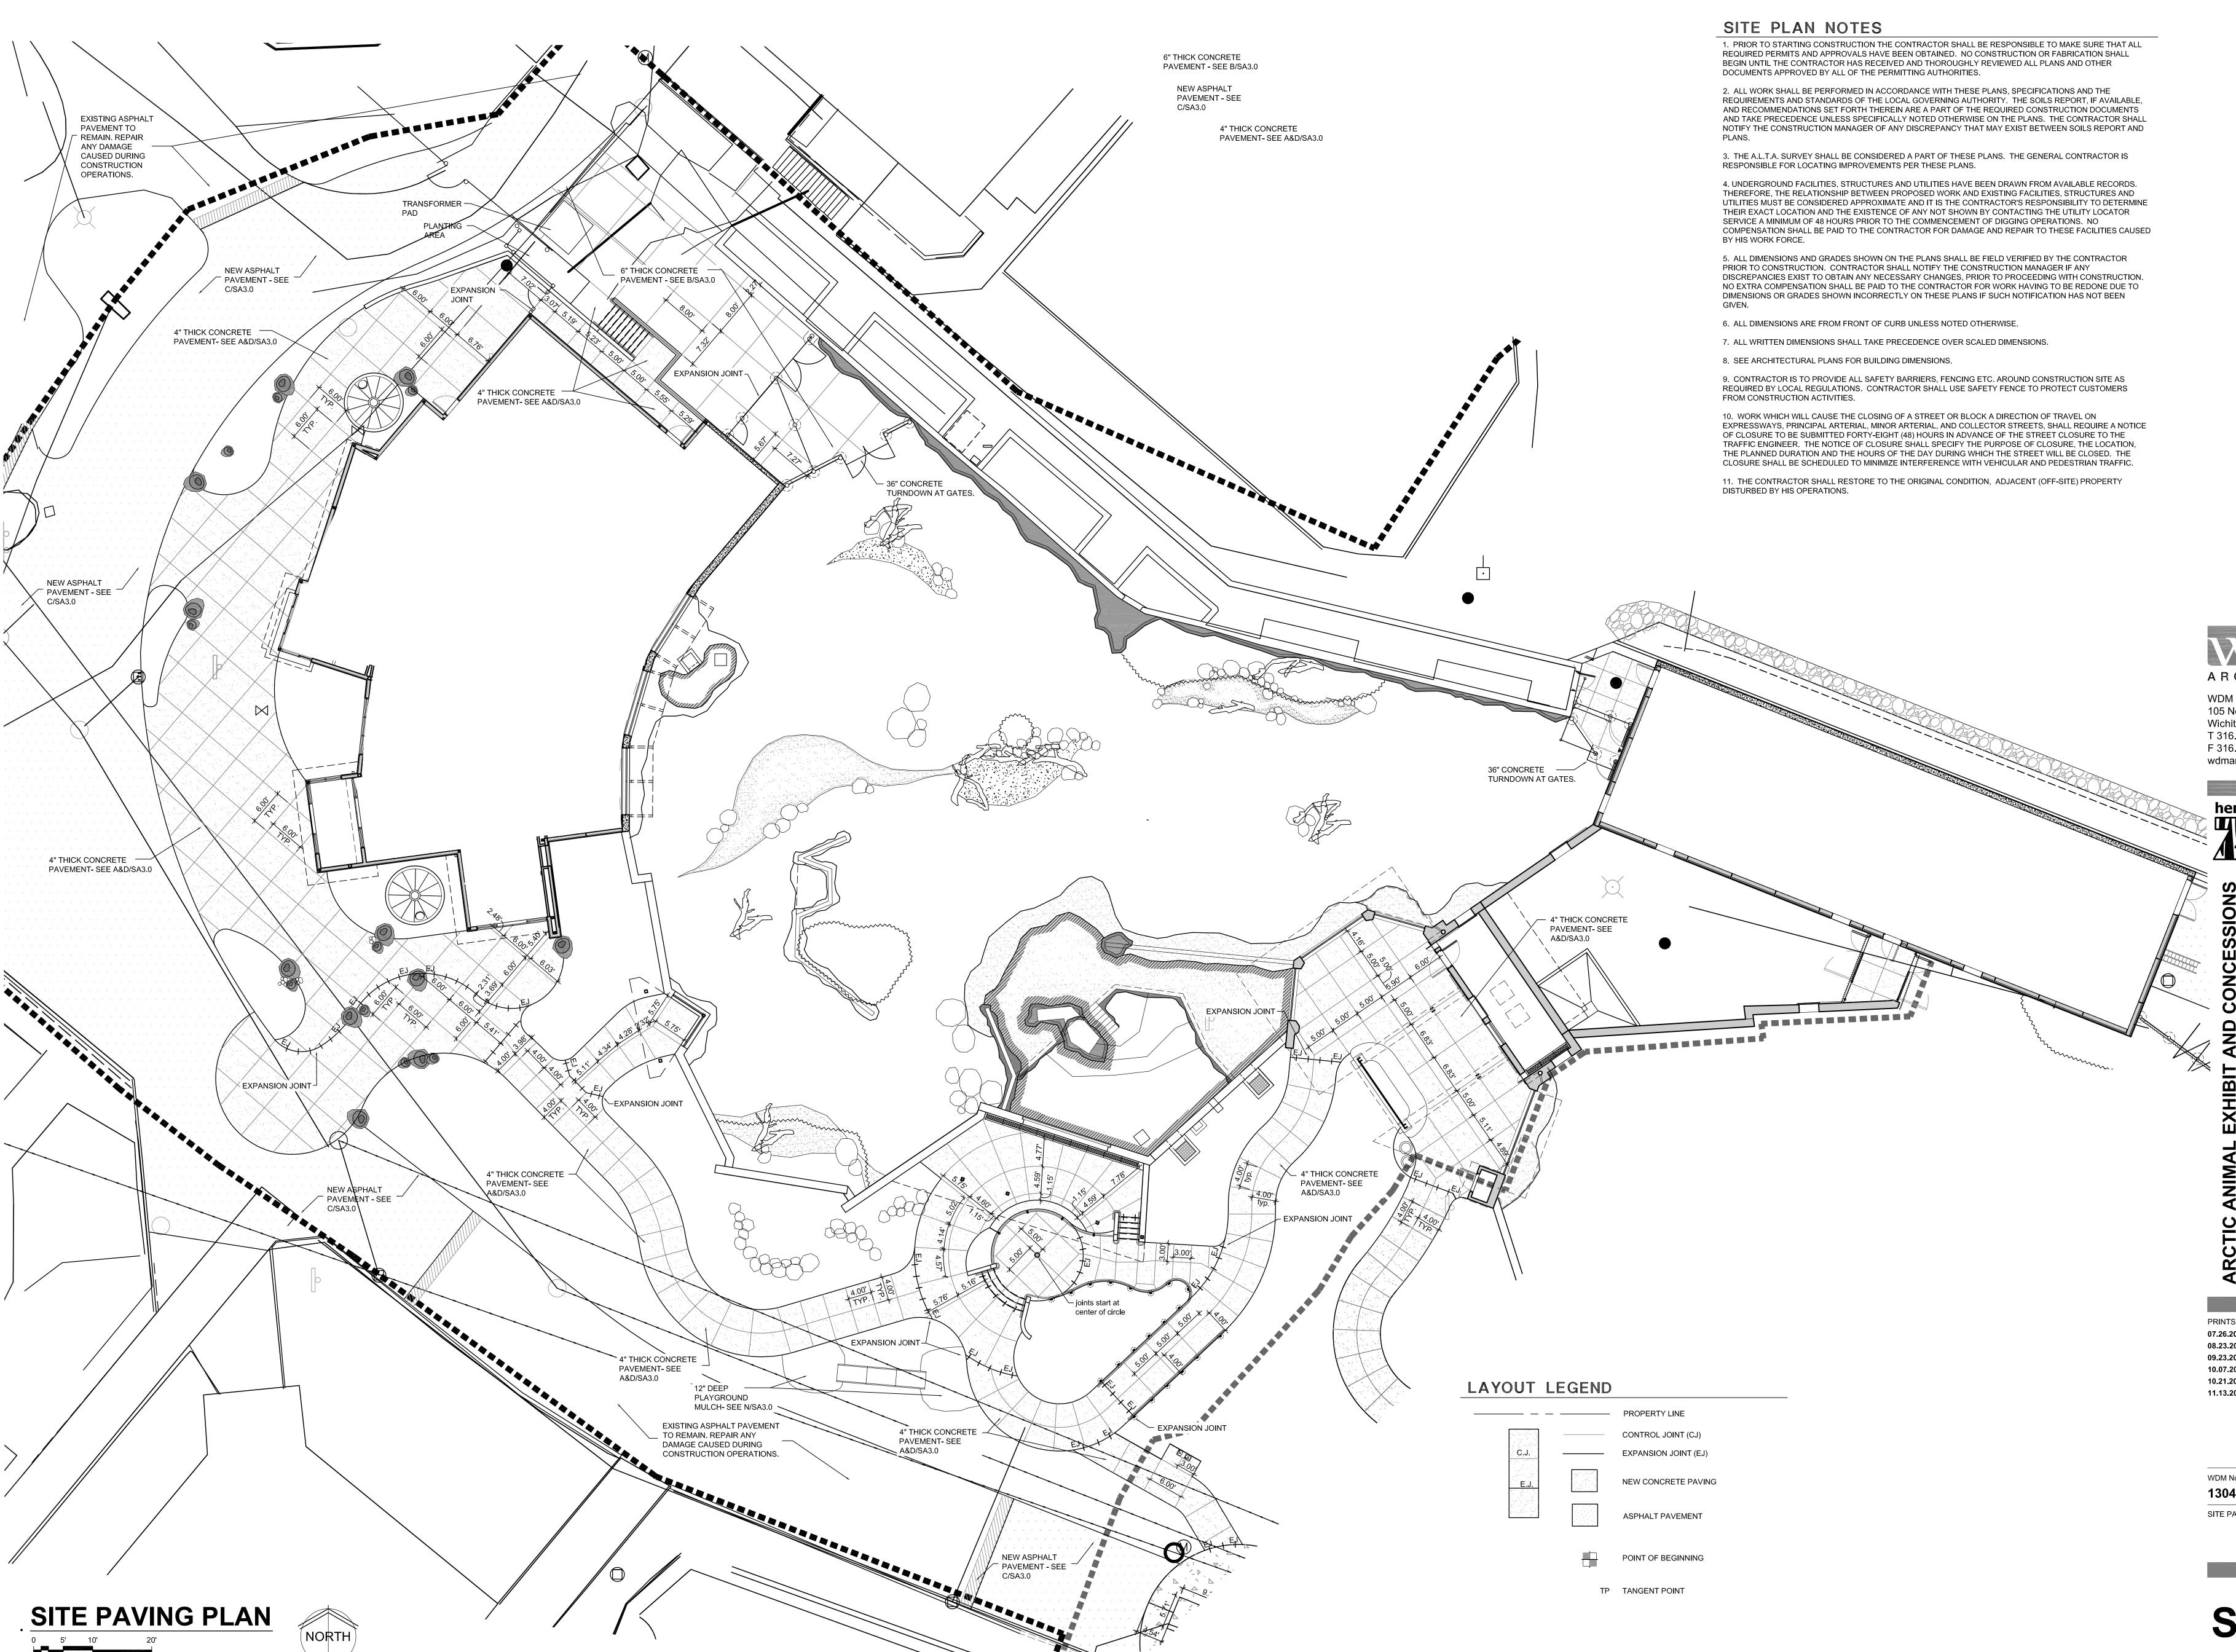

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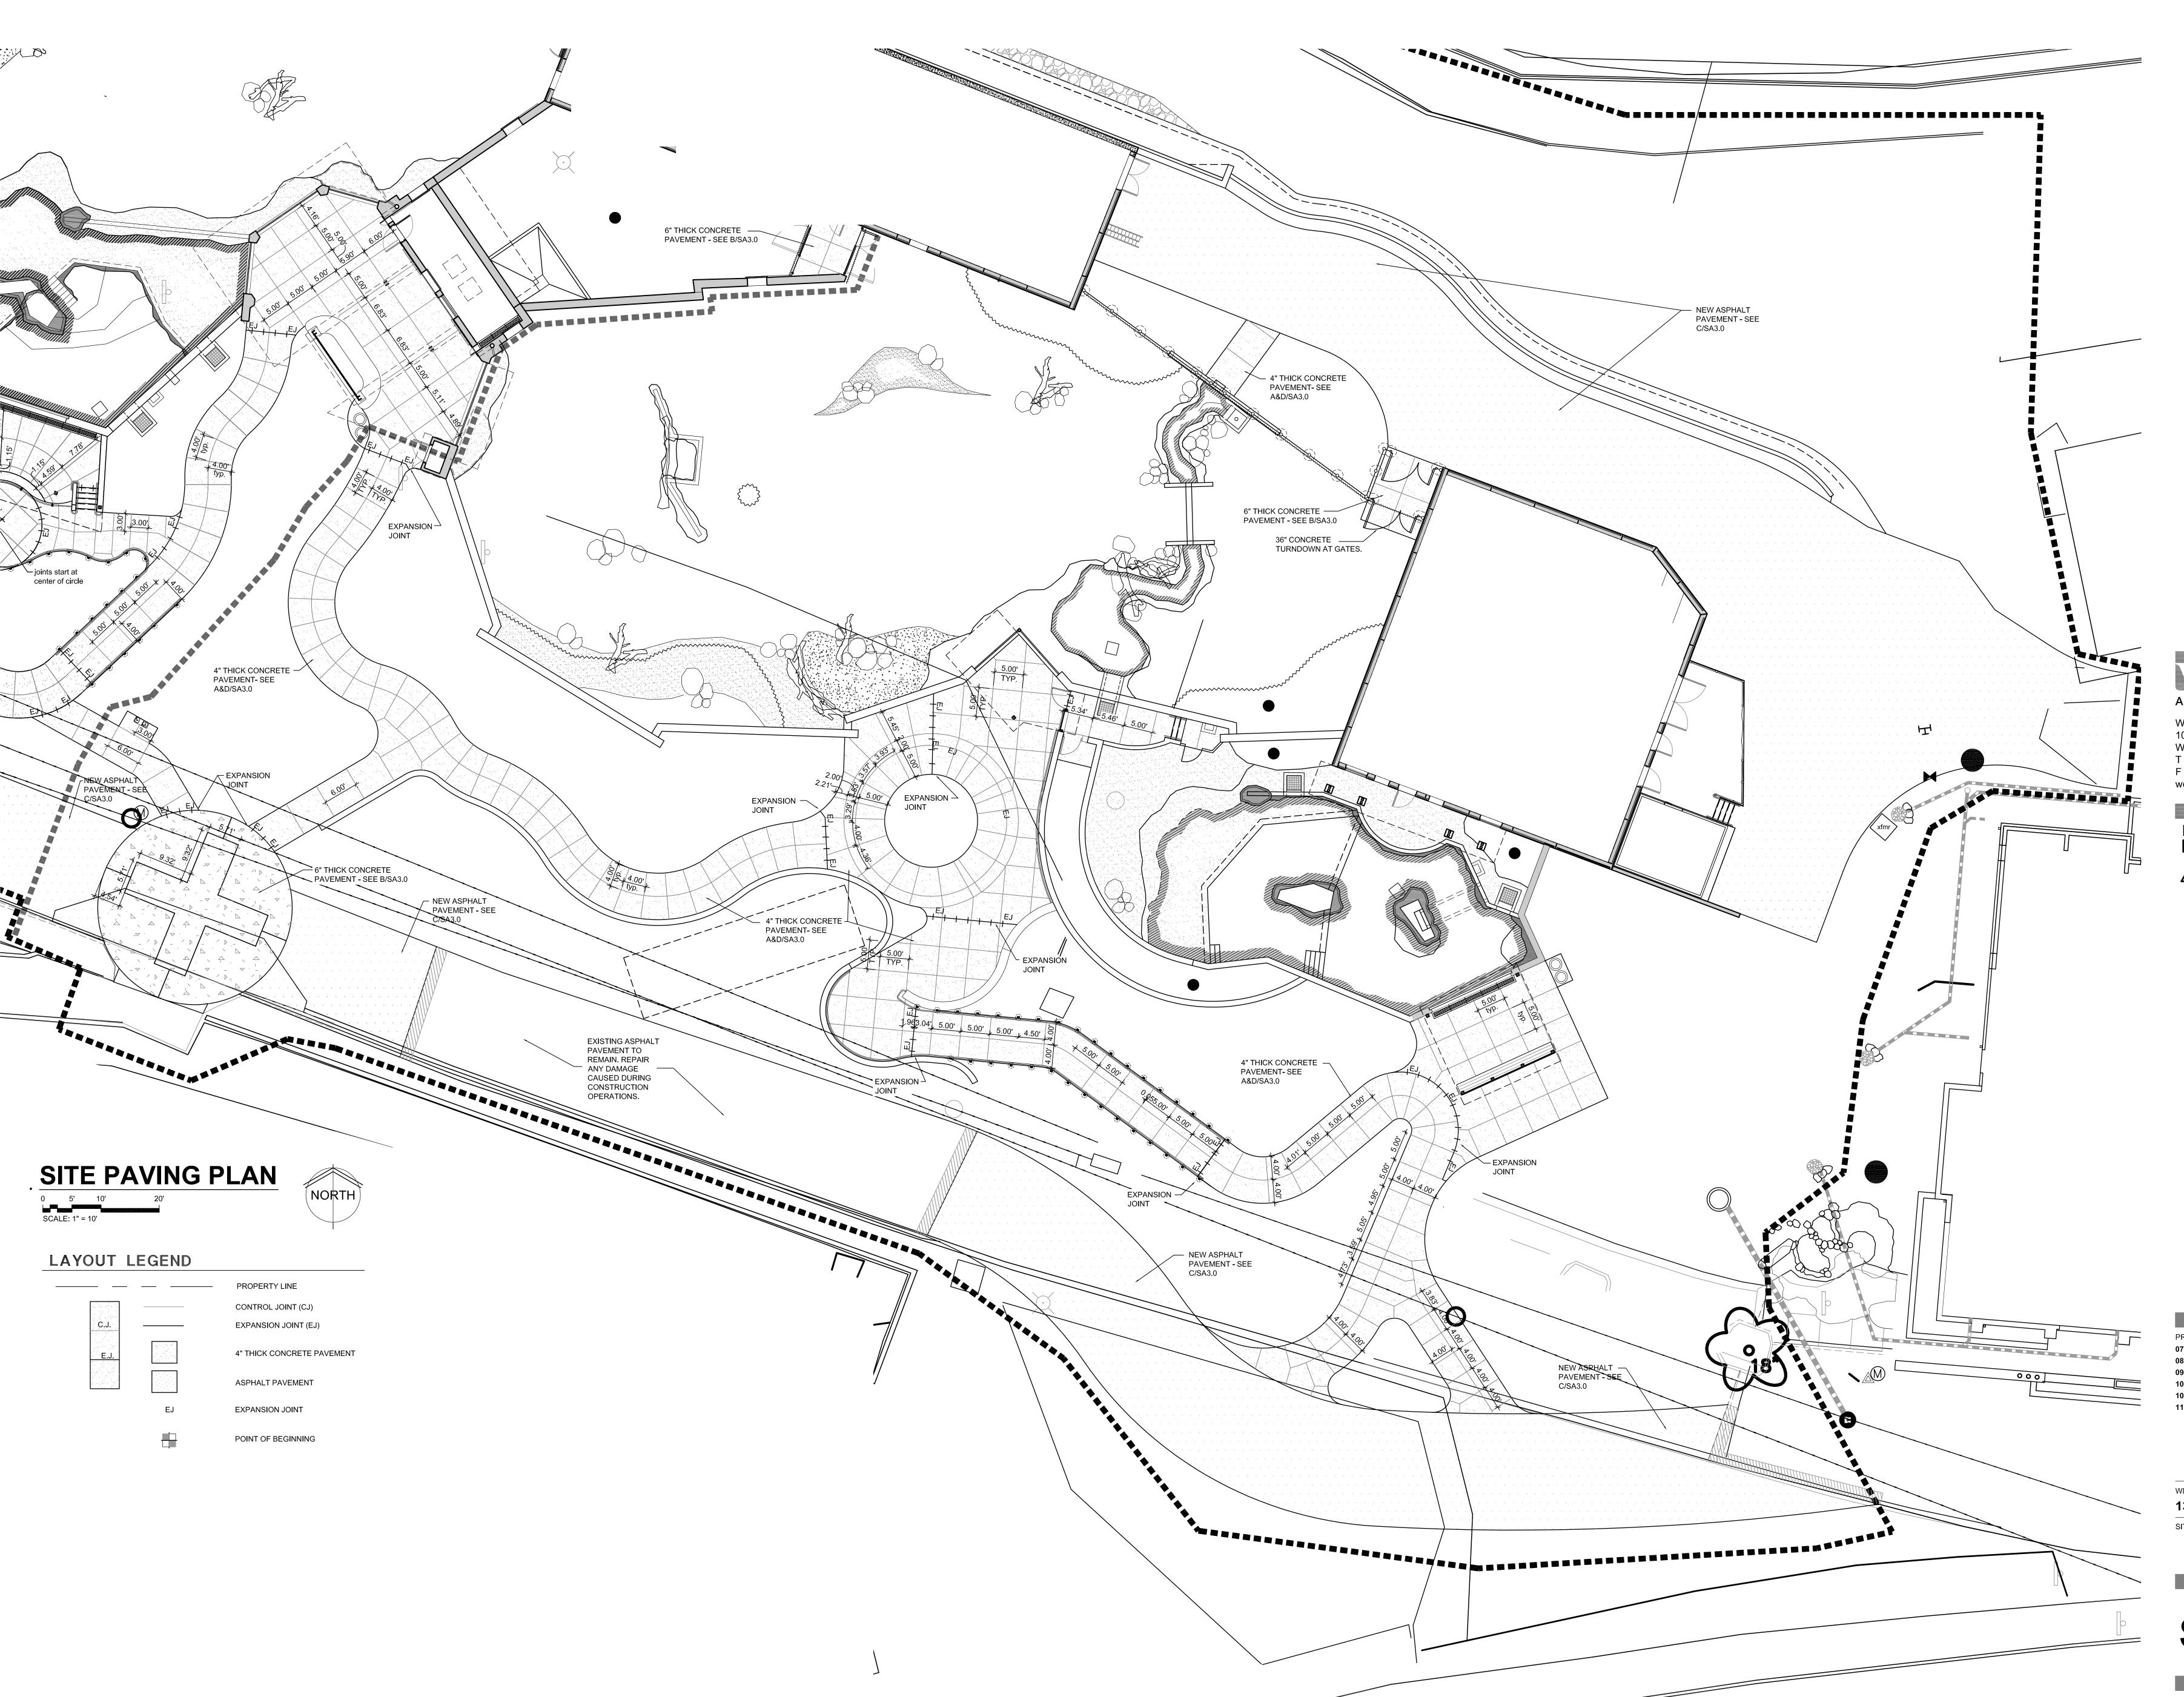
10.21.2013 - 95% CD's

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1 No. drawn: NS

13046 checked: SR
SITE PAVING PLAN

SA8.1



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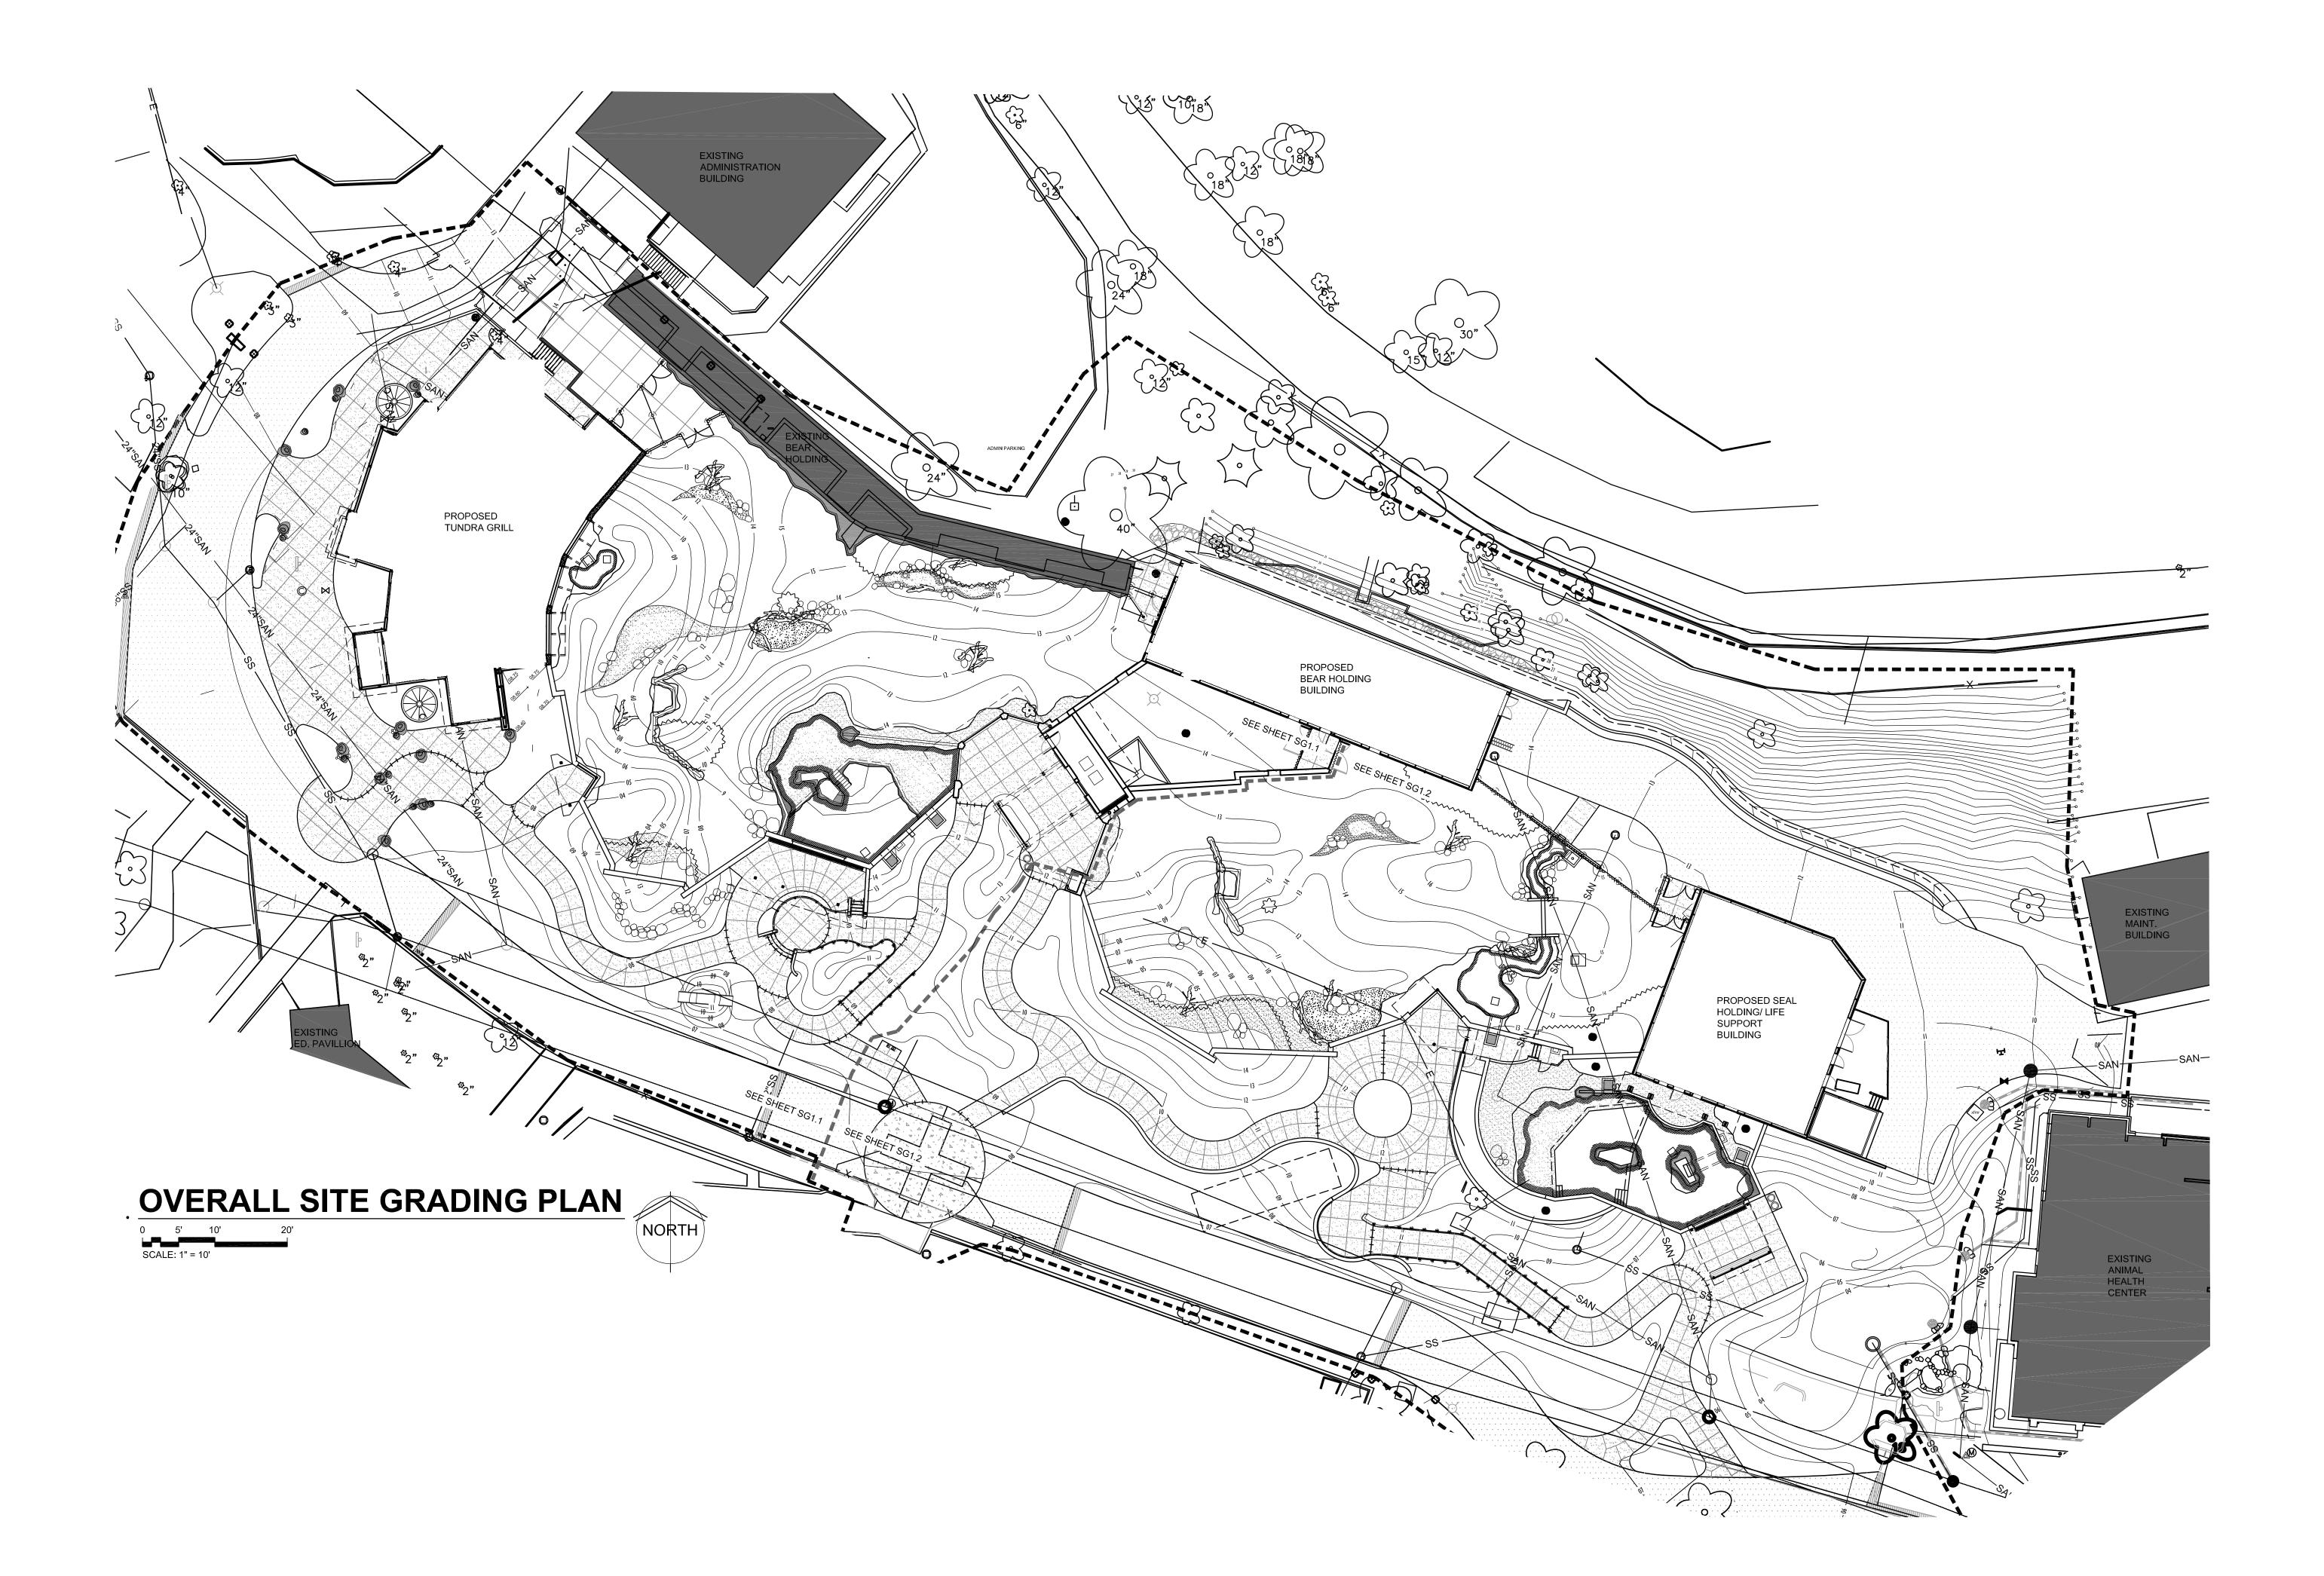
10.07.2013 - Pricing Set

10.21.2013 - 95% CD's

11.13.2013 - Bid Documents

WDM No. drawn: NS
13046 checked: SR
SITE PAVING PLAN

SA8.2



NOTES:

ARCHITECT.

- 1. PROTECT ALL EXISTING UTILITIES TO REMAIN. 2. CONTRACTOR TO VERIFY LOCATION OF UTILITIES
- PRIOR TO EXCAVATION. 3. REMOVE TOPSOIL IN ALL AREAS TO BE DISTURBED
- AND STOCKPILE. COORDINATE LOCATIONS WITH ARCHITECT.
- 4. CONTOUR INTERVAL FOR EXISTING AND PROPOSED CONTOUR LINES ARE 1'-0"
- 5. PROPOSED CONTOURS SHOWN ARE FINISH GRADES AND READ TO TOP OF PAVEMENT AND
- FINISH DIRT GRADE. 6. THE CONTRACTOR SHALL BE RESPONSIBLE TO PROTECT GRADED AREAS FROM, AND AS NECESSARY RESTORE TO GRADE, ANY RUTS, WASHES OR OTHER CHANGES FROM THE DESIGN ELEVATIONS SHOWN HEREON, UNTIL GRADING WORK IS ACCEPTED BY THE OWNER AND
- 7. ALL GRADING SHALL BE DONE TO INSURE POSITIVE DRAINAGE AWAY FROM BUILDINGS. IF DISCREPANCY EXISTS ON PLAN IMMEDIATELY
- NOTIFY ARCHITECT. 8. ALL SIDEWALKS (NON-RAMP) SHALL BE GRADED TO SLOPES NO GREATER THAN 1:20 (5%) IN THE

DIRECTION OF TRAVEL. CROSS SLOPES (RAMPS

- INCLUDED) NO GREATER THAN 1:50 (2%). 9. ALL WEEDS, TRASH, DEBRIS, RUBBLE, BROKEN ASPHALT, ORGANIC MATERIAL (EXCLUDING TOP SOIL) AND REFUSE, OR ANY OTHER MATERIAL WHICH WOULD BE HARMFUL AS FILL MATERIAL OR INCAPABLE OF SUPPORTING BUILDING, VEHICULAR AND OR OVERBURDEN LOADS TO BE CLEARED, GRUBBED OR EXCAVATED AS THE CASE MAY DICTATE. THIS MATERIAL SHALL BE REMOVED
- GRADING. 10. TOPOGRAPHIC SURVEY BY: MSA PROFESSIONAL SERVICES

FROM THE SITE AND DISPOSED OF PRIOR TO


- 2901 INTERNATIONAL LANE MADISON, WI 53704 1-800-446-0679
- 11. TOP OF WALL DESIGNATION REFERS TO TOP OF CONCRETE WALL ONLY.
- 12. BOLT GRATES TO ALL SWS CATCH BASINS. SEE
- 13. ALL GRADES SHALL MEET ADA REQUIREMENTS.

<u>LEGEND</u>

608-242-7779

TF		TOP OF FENCE	
TW		TOP OF WALL	
TR		TOP OF ROCK (
TP		TOP OF PAVEM	IENT
MT		TOP OF PAVEM	ENT (MO
E		EXISTING GRAI TO BE MA	
EOF)	EDGE OF PAVE	MENT
ВР		воттом ог Ро	OOL
LP		LOW POINT	
HP		HIGH POINT	
GR		GRADE	
FL		FLOW LINE	
DB		DRAIN BASIN	
FFE		FINISH FLOOR	ELEVATI
WS		WATER SURFAC	CE
TC		TOP OF COLUM	N
POC	L RET.	POOL RETURN	
TT		TOP OF TUNNE	L



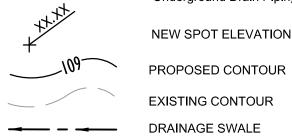

EX

TOP



EXISTING

TOP OF INLET



SIDEWALKS

RETAINING WALL RULES:


- UNLESS NOTED OTHERWISE, CONCRETE RETAINING WALLS ARE LEVEL ON TOP AT LOWER SPOT ELEVATION, STEPPING UP AT LOCATION OF HIGHER ELEVATION.
- AN ARROW ON TOP OF A RETAINING WALL INDICATES SLOPING TOP FROM ONE ELEVATION TO NEXT.

LOCATION OF STEP IN WALL.

3. LINE ACROSS RETAINING WALL INDICATES



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11.13.2013 - Bid Documents

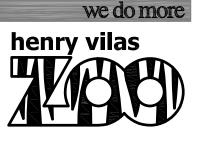SITE GRADING PLAN

SG1.0



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> drawn: NS checked: SR


WDM No. 13046 SITE GRADING PLAN

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SIDEWALKS

3. LINE ACROSS RETAINING WALL INDICATES

LOCATION OF STEP IN WALL.

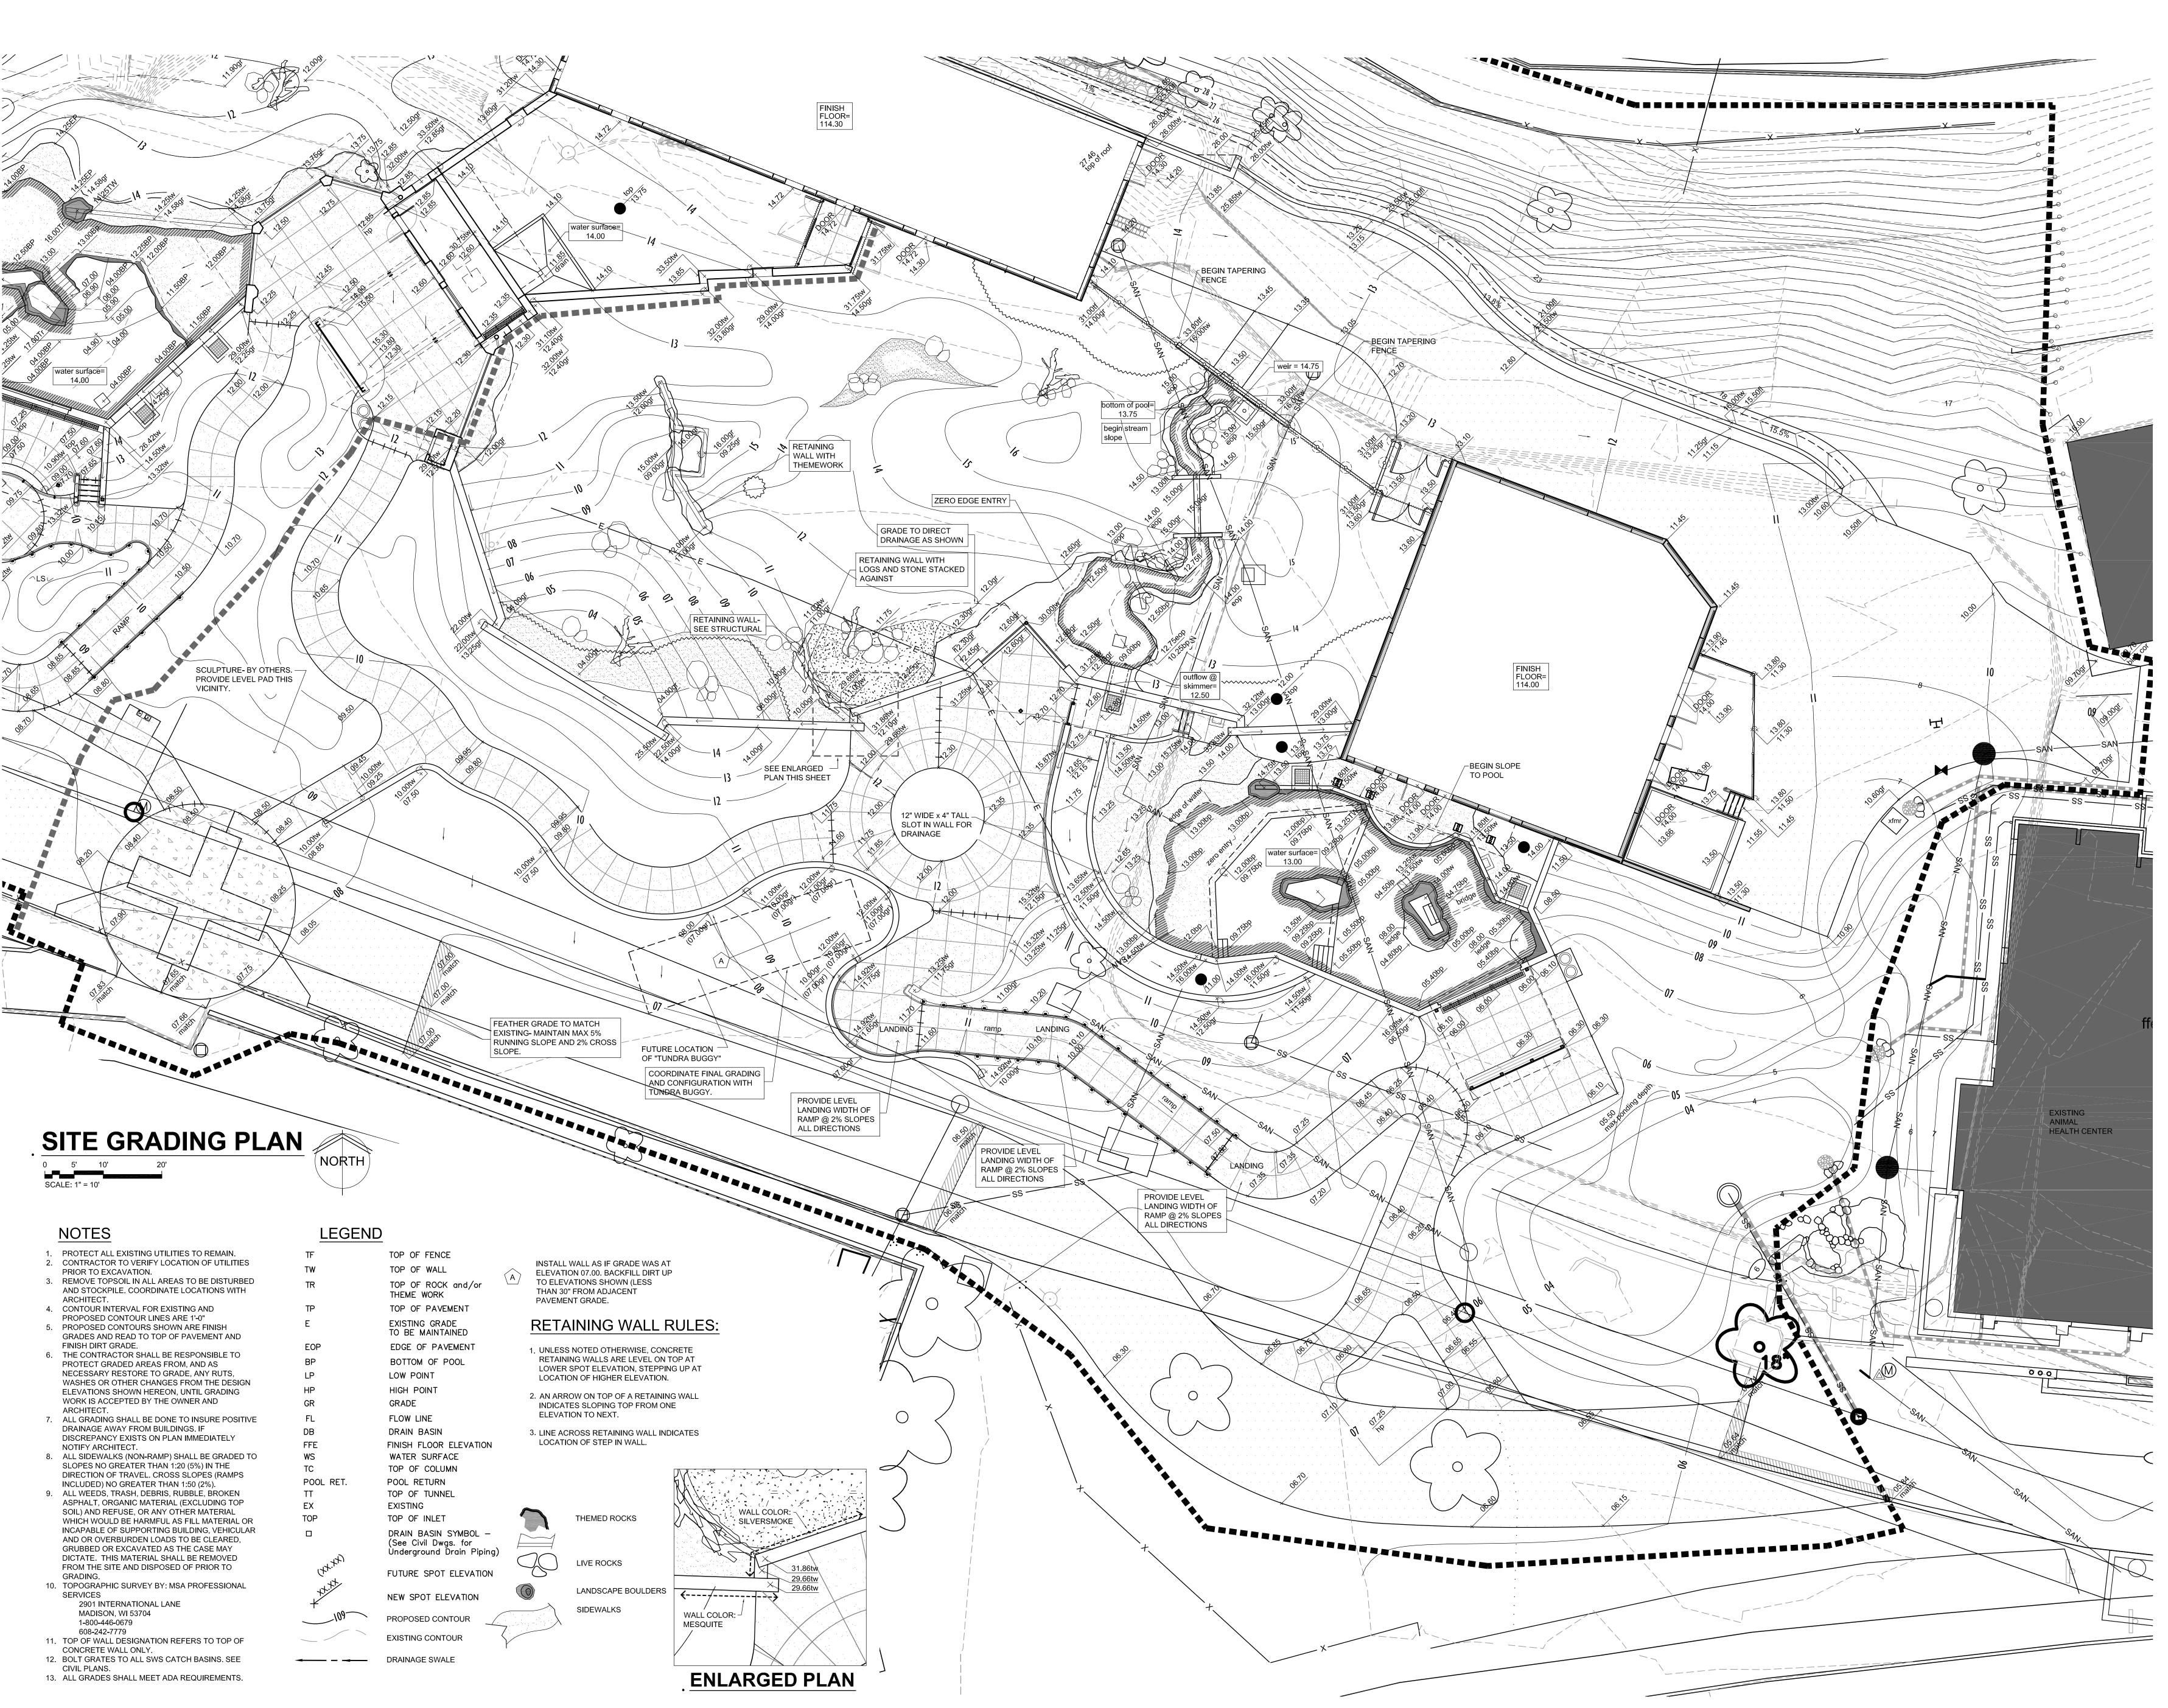


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NOTES:

- PROTECT ALL EXISTING UTILITIES TO REMAIN.
 CONTRACTOR TO VERIFY LOCATION OF UTILITIES PRIOR TO EXCAVATION.
- 3. REMOVE TOPSOIL IN ALL AREAS TO BE DISTURBED AND STOCKPILE. COORDINATE LOCATIONS WITH
- 4. CONTOUR INTERVAL FOR EXISTING AND
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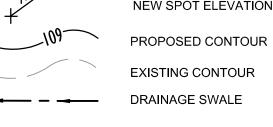
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- 11. TOP OF WALL DESIGNATION REFERS TO TOP OF
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- BASINS. SEE CIVIL PLANS. 13. ALL GRADES SHALL MEET ADA REQUIREMENTS.

LEGEND

	TF	TOP OF FENCE
	TW	TOP OF WALL
	TR	TOP OF ROCK and/or THEMEWORK
	TP	TOP OF PAVEMENT
	MT	TOP OF PAVEMENT (M
	E	EXISTING GRADE TO BE MAINTAIN
	EOP	EDGE OF PAVEMENT
	BP	BOTTOM OF POOL
	LP	LOW POINT
	HP	HIGH POINT
	GR	GRADE
	FL	FLOW LINE
	DB	DRAIN BASIN
	FFE	FINISH FLOOR ELEVAT
,	WS	WATER SURFACE
•	TC	TOP OF COLUMN
	POOL RET.	POOL RETURN
	тт	TOP OF TUNNEL

DRAIN BASIN SYMBOL -(See Civil Dwgs. for Underground Drain Piping) NEW SPOT ELEVATION

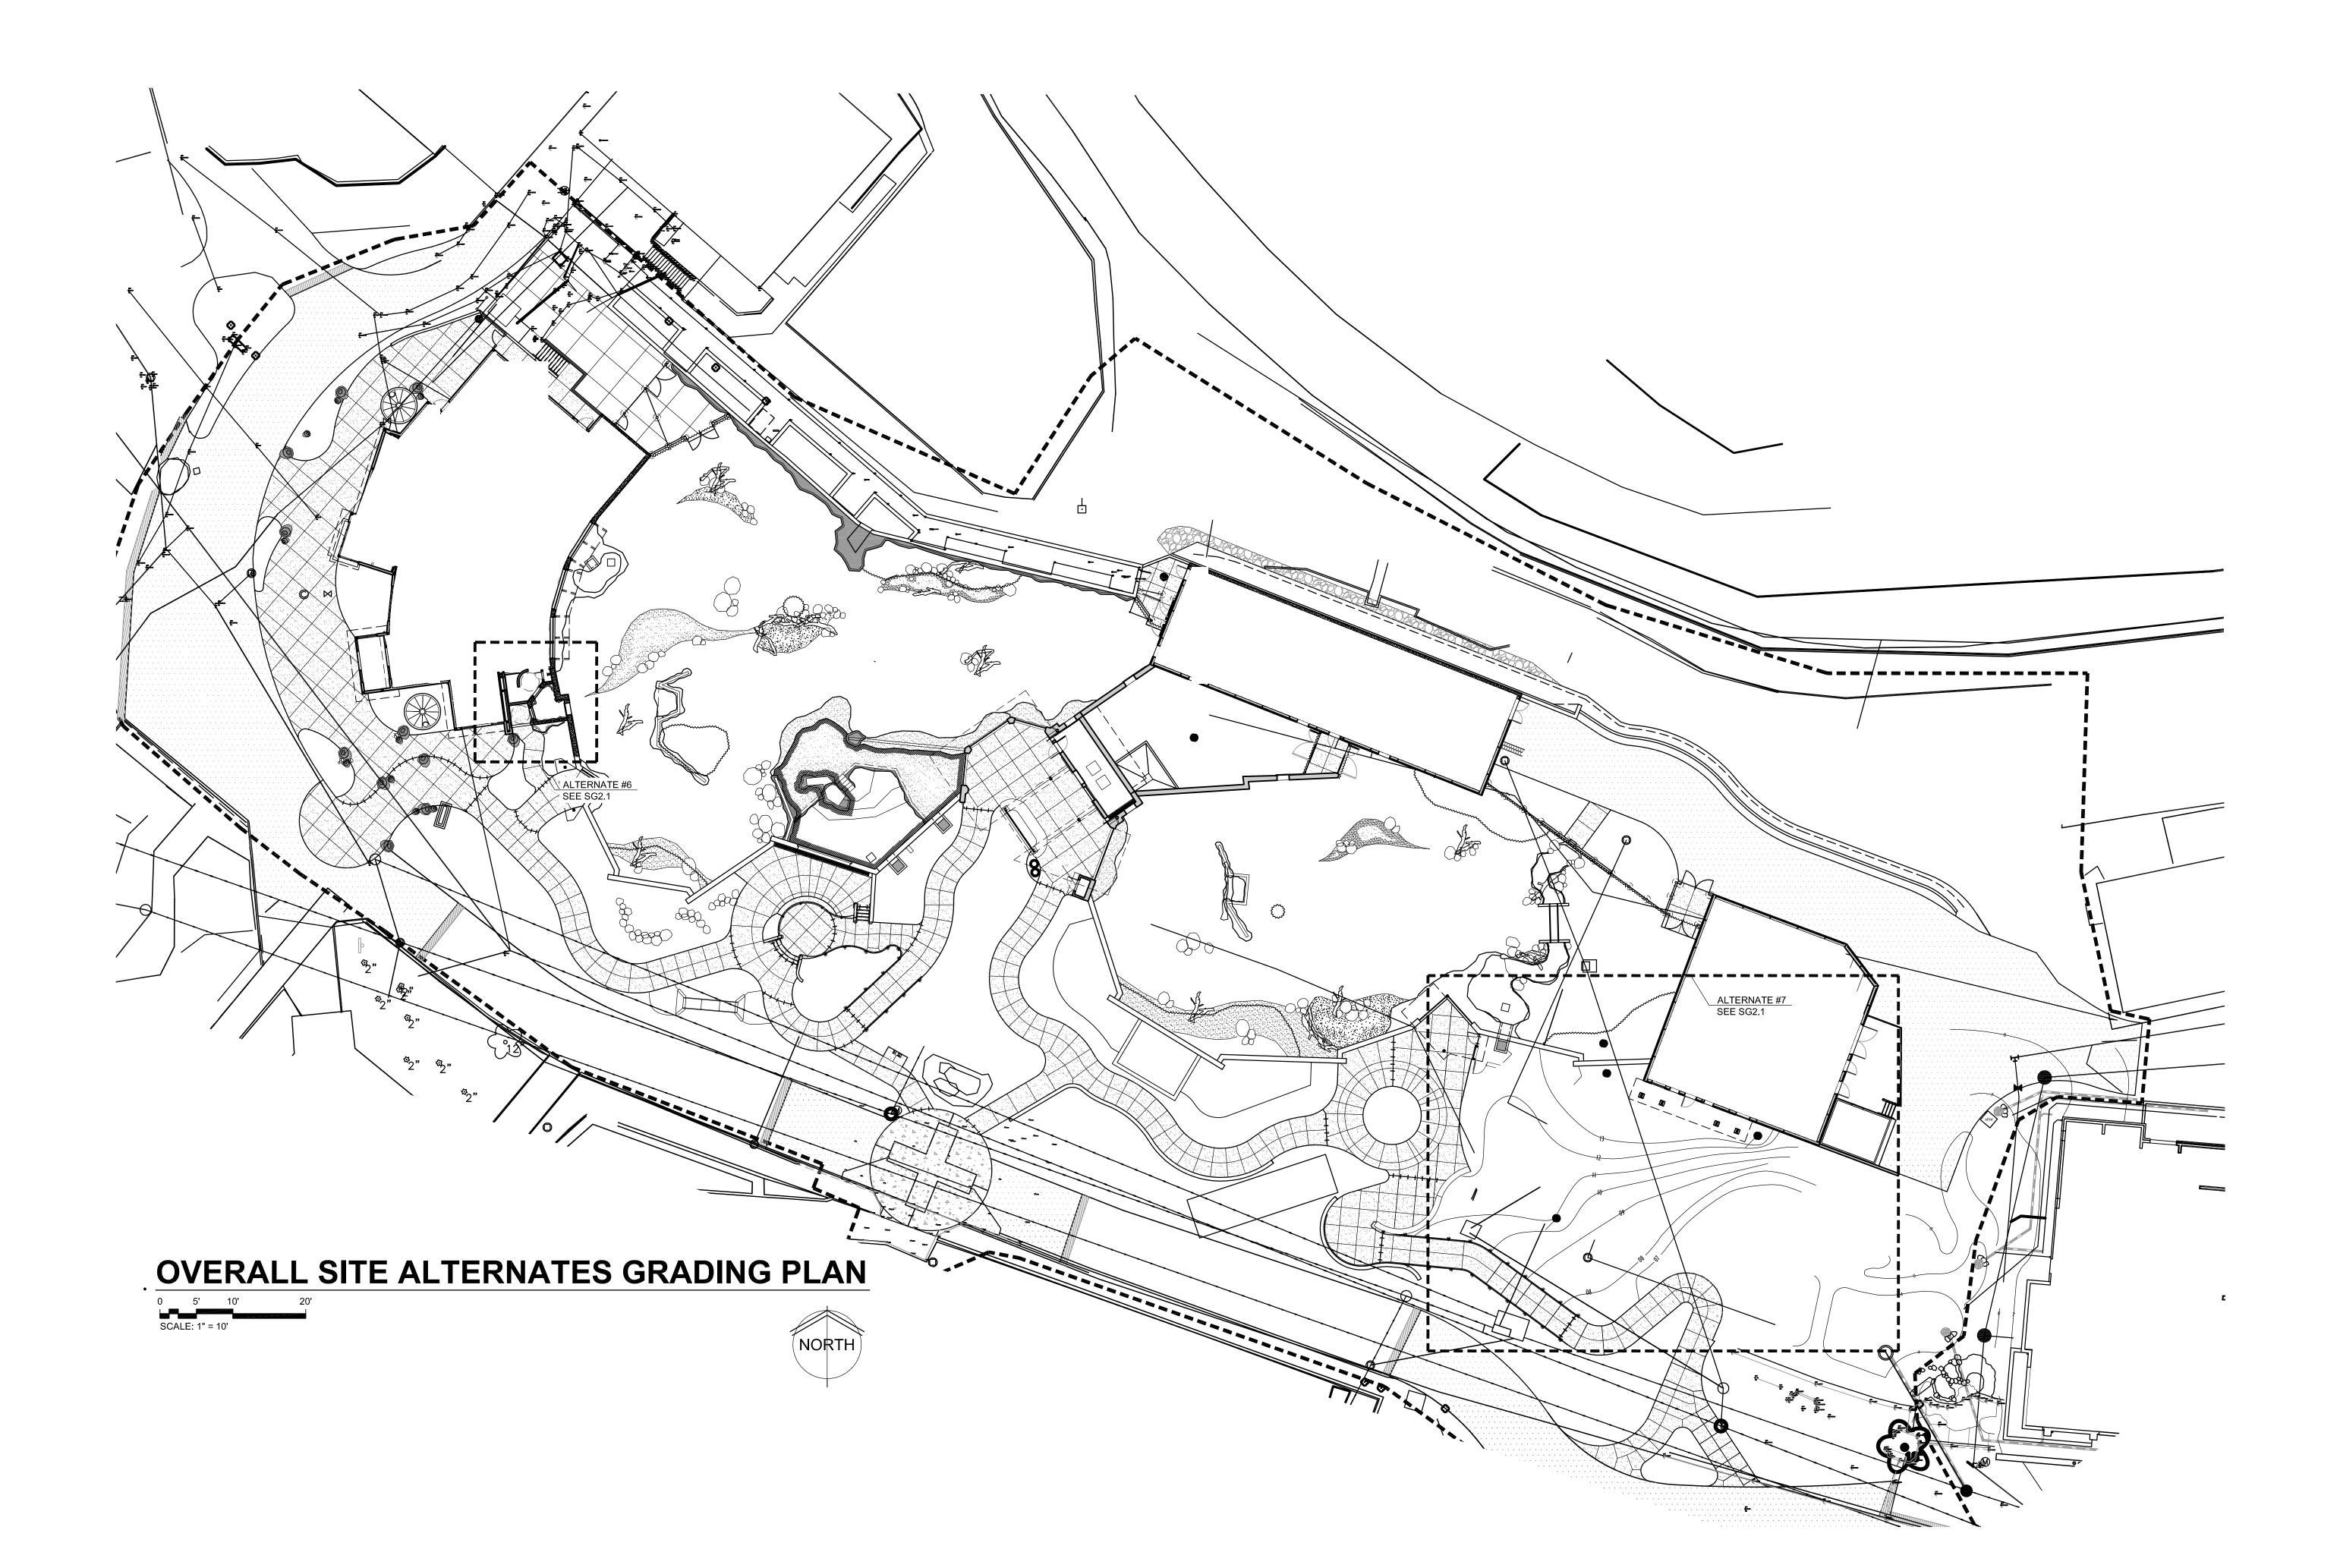

DRAINAGE SWALE THEMED ROCKS

EXISTING TOP OF INLET



LIVE ROCKS

RETAINING WALL RULES:

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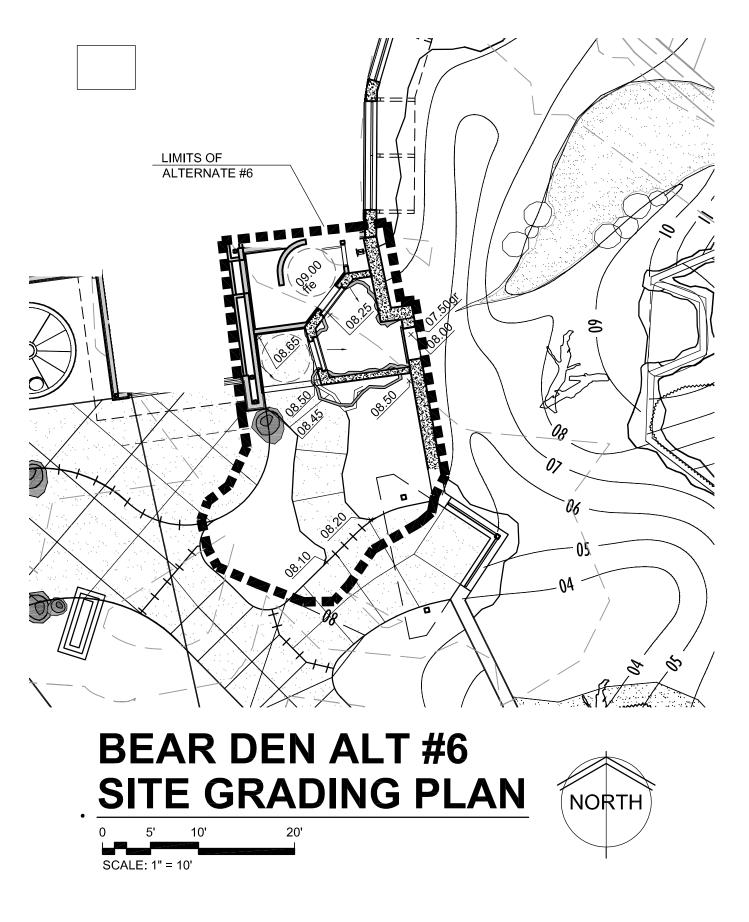



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SITE GRADING PLAN

-ALTERNATES-

SG2.0



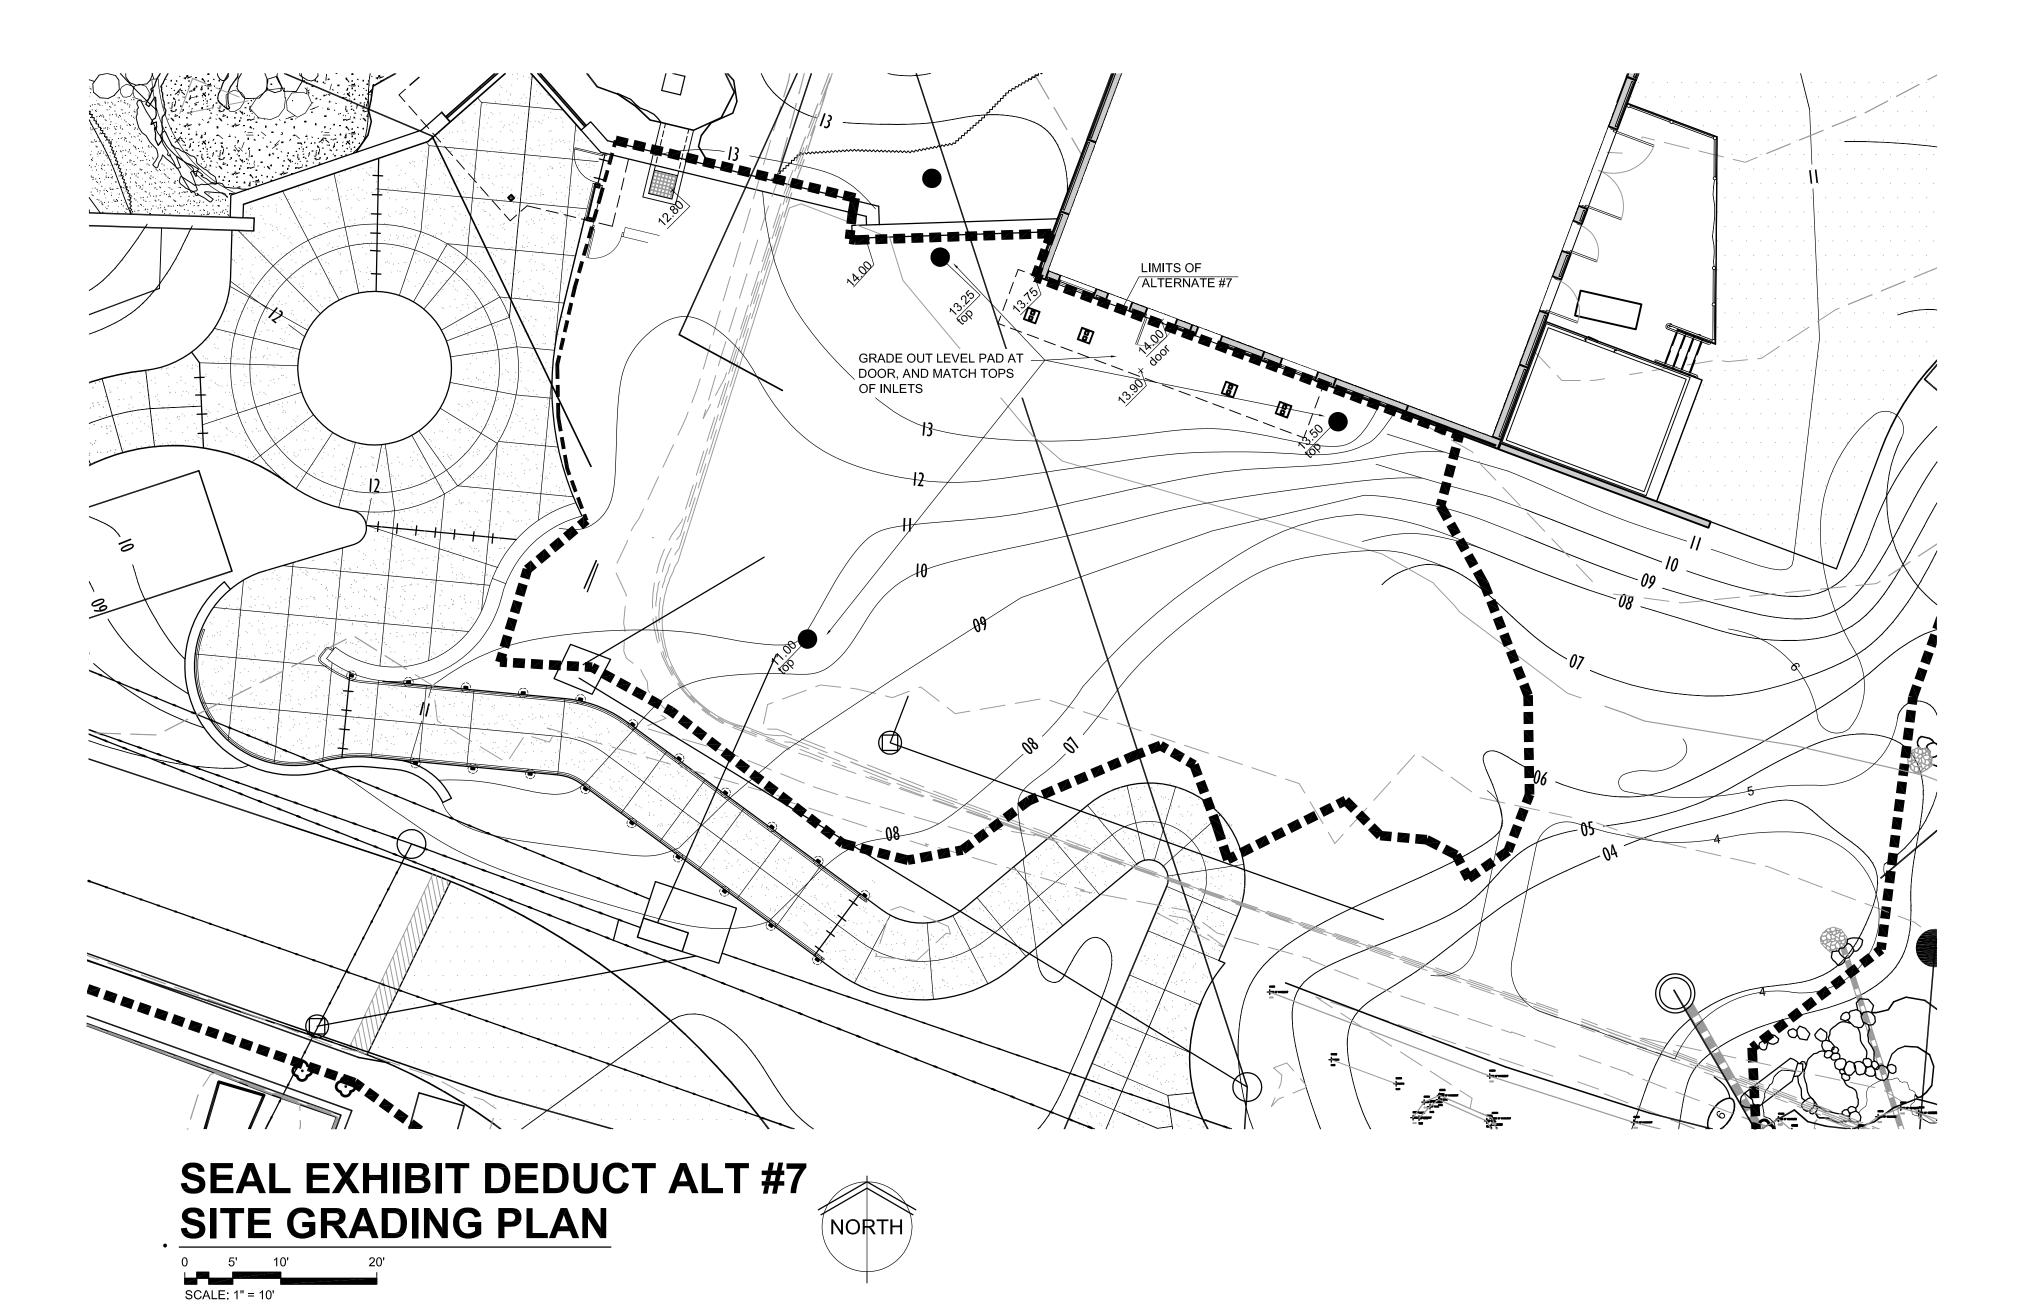

NOTES:

- 1. PROTECT ALL EXISTING UTILITIES TO REMAIN. 2. CONTRACTOR TO VERIFY LOCATION OF UTILITIES
 - PRIOR TO EXCAVATION.
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LEGEND

TOP OF FENCE TOP OF WALL TOP OF ROCK and/or THEMEWORK TOP OF PAVEMENT TOP OF PAVEMENT (MOAT) EXISTING GRADE TO BE MAINTAINED EDGE OF PAVEMENT

BOTTOM OF POOL LOW POINT HIGH POINT GRADE


FLOW LINE DRAIN BASIN FINISH FLOOR ELEVATION WATER SURFACE TOP OF COLUMN

POOL RET. POOL RETURN TOP OF TUNNEL **EXISTING** TOP TOP OF INLET

DRAIN BASIN SYMBOL -(See Civil Dwgs. for Underground Drain Piping) NEW SPOT ELEVATION

PROPOSED CONTOUR EXISTING CONTOUR **→ →** DRAINAGE SWALE

THEMED ROCKS

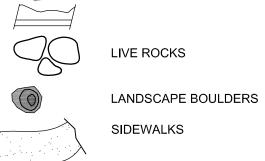

RETAINING WALL RULES:

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ARC.

SITE GRADING PLAN

-ALTERNATES-