

STANDARD LEGEND

EXISTING	DESIGN	ROADWAYS
		GRAVEL
		PAVED
		RAILROAD
		CENTERLINE
		WALKS/DRIVES
		WALLS/FENCES
		EARTH WALL
		FENCE LINE
		CONTOURS
		INDEX CONTOUR (10' INTERVAL)
		INTERMEDIATE CONTOUR (2' INTERVAL)
		DEPRESSION
		SPOT ELEVATION
		TREES
		DECIDUOUS
		CONIFER
		BUSH
		TREE LINE AND/OR BUSH
		WATER
		BODIES OF WATER
		RIVER/STREAMS
		INTERMITTENT STREAM
		DITCH WITH FLOW AND DIRECTION
		BRIDGE
		CULVERT
		EDGE OF WATER / APPROXIMATE LIMITS OF WET AREA
		AREA CONTAINING WETLAND VEGETATION
		BUILDING
		BUILDING
		FEATURES
		WATER TABLE WELL
		SOIL BORING
		TEST PIT
		PIEZOMETER
		STAFF GAUGE
		PRIVATE WELL
		LEACHATE HEAD WELL
		LEACHATE HEAD WELL MONITORING PORT
		GAS VENT
		GAS MONITORING PROBE
		LYSIMETER
		SEPTIC COVER
		SEPTIC VENT
		ABANDONED PRIVATE WELL
		ABANDONED MONITORING WELL
		ABANDONED PIEZOMETER
		UTILITIES
		STORM SEWER LINE
		SANITARY SEWER LINE
		UNDERGROUND ELECTRIC
		ELECTRICAL WIRES
		UNDERGROUND TELEPHONE
		TELEPHONE
		CABLE
		WATER
		GAS
		LIGHT POLE BASE
		MISCELLANEOUS
		LIMITS OF COMPOSITE LINER CONSTRUCTION
		SEDIMENT CONTAINMENT FENCE
		LIMITS OF WASTE
		PHASE / MODULE LINE
		APPROXIMATE LIMITS OF CONSTRUCTION
		SEDIMENT EROSION CONTROL LOGS

NOTE:
 1. THESE SYMBOLS DO NOT APPLY TO SHEET 3, ALL EXISTING FEATURES SHOWN AS BOLD ON PLAN SHEET 3
 2. SYMBOLS IN LEGEND ON INDIVIDUAL SHEETS SUPERSEDE SYMBOLS SHOWN IN THIS SHEET.

EXISTING	PROPOSED	SURVEY DATA
		PROPERTY LINE
		RIGHT-OF-WAY LINE
		BENCH MARK
		SURVEY CONTROL POINT
		MONUMENT
		SECTION-CORNER / QUARTER-CORNER
		PIPE
		COLLECTION PIPE CLEANOUT
		MANHOLE
		COLLECTION PIPE (PERFORATED)
		TRANSFER PIPE (SOLID WALL)
		LEACHATE FORCEMAIN
		SURFACE
		PHASE/MODULE DELINEATION BERM
		SEDIMENTATION BASIN
		FINAL COVER DIVERSION BERM
		RIPRAP SPILLWAY
		STONE TRACKING PAD
		EROSION CONTROL MAT / TURF REINFORCEMENT MAT
		PLAN SHEET
		GRID TICK AND STATION
		GRID TICK AND STATION
		DETAIL 3 ON SHEET 10
		SLOPE PERCENT AND DIRECTION
		ENGINEERING/GEOLOGIC CROSS SECTION LOCATION
		SURFACE WATER FLOW ARROW

STANDARD NOTES

- NOTES**
- TOPOGRAPHIC INFORMATION WAS DEVELOPED BY SPlicing THE FEBRUARY 2, 2016 AECOM GROUND SURVEY (PHASE 10 - CELL 2 AREA), DECEMBER 2, 2014 AECOM GROUND SURVEY (IN THE STOCKPILE AREA SOUTH OF FUTURE PHASE 11), FEBRUARY 4, 2014 AECOM GROUND SURVEY (IN THE AREA SOUTH OF PHASE 9 - CELL 1), AND AS-BUILT PHASE 9 - CELL 1 AND AS-BUILT PHASE 10 - CELL 1 GRADES INTO THE APRIL 2, 2013 KBM, INC. AERIAL SURVEY. ADDITIONAL TOPOGRAPHIC INFORMATION OUTSIDE OF APRIL 2, 2013 KBM, INC. AERIAL SURVEY WAS OBTAINED FROM: DANE COUNTY LAND INFORMATION OFFICE MADISON, WI., TWO-FOOT CONTOURS DATED 2009.
 - HORIZONTAL DATUM IS BASED ON NAD27 WISCONSIN STATE PLANE COORDINATE SYSTEM.
 - VERTICAL DATUM IS REFERENCED TO USGS MEAN SEA LEVEL (M.S.L.) DATUM. THE TOPOGRAPHIC CONTOUR INTERVAL IS TWO FEET.

HORIZONTAL AND VERTICAL CONTROL POINT LOCATIONS				
NAME	NORTHING STATE PLANE (FEET)	EASTING STATE PLANE (FEET)	ELEVATION (FT-MSL)	DESCRIPTION
203	381,404.98	2,198,495.01	875.020	CP 0.75 REBAR SOUTH SIDE OF PAVED ENTRY ROAD
5141	381,812.47	2,201,335.74	906.000	CP 100D WEST SIDE CTH AB WEST OF MAILBOX 3620
5143	380,264.80	2,201,121.12	883.000	CP MEDIAN SO OF INLET NORTH SIDE MEDIAN 12/18 WEST OF CTH AB
5146	383,160.34	2,201,292.29	870.930	CP 100D SW OF NE CONST FENCE CORNER
6001	382,847.88	2,200,698.84	889.452	CP SPIKE IN GRAVEL DRIVE SW OF FO WEST END OF TALL FENCING NORTH OF P10 CELL 1
6002	382,615.37	2,200,252.21	880.659	CP SPIKE SOUTH SIDE OF ACCESS ROAD WEST OF P10 CELL 1
6003	382,602.35	2,200,447.27	879.687	BM CUT SQ. SW CORNER CONCRETE SLAB WEST OF BERM P10 SOUTH OF ACCESS ROAD
6007	381,590.05	2,200,730.86	889.218	BM TOP OF LIFT BRACE ON NORTH SIDE OF MH IN AREA OF P10 CELL 2

NOTE: THE CONTRACTOR SHALL NOTIFY ALL AREA UTILITY COMPANIES PRIOR TO COMMENCING WORK ON THIS CONTRACT, IN ACCORDANCE WITH STATE AND LOCAL REQUIREMENTS.

NOTE: THESE PLANS ARE ACCOMPANIED BY A PROJECT MANUAL OF THE SAME TITLE. THESE DOCUMENTS ARE INTERRELATED AND ARE INTENDED TO BE USED TOGETHER.

NO.	BY	DATE	REVISION	APPD.

PROJECT: **DANE COUNTY NO. 2 (RODEFELD) LANDFILL**
PHASE 10 - CELL 2
LINER CONSTRUCTION
DANE COUNTY, WISCONSIN


TITLE: **STANDARD LEGEND AND GENERAL NOTES**

DRAWN BY: RNOLDEN	PROJ. NO.: 250205.0000.0000.00002
CHECKED BY: DM	SHEET 2 OF 11
APPROVED BY: DRG	
DATE: JUNE 2016	

708 Heartland Trail
 Suite 3000
 Madison, WI 53717
 Phone: 608.826.3600

FILE NO.: 250205.SHT02-LG.dwg


PLOT DATE: JUN 02 2016 6:05PM ... LAYOUT: SHEET 2
 DRAWING NAME: J:\Dane County LP\250205 - P10-C2-Liner\00002-250205.SHT02-LG.dwg

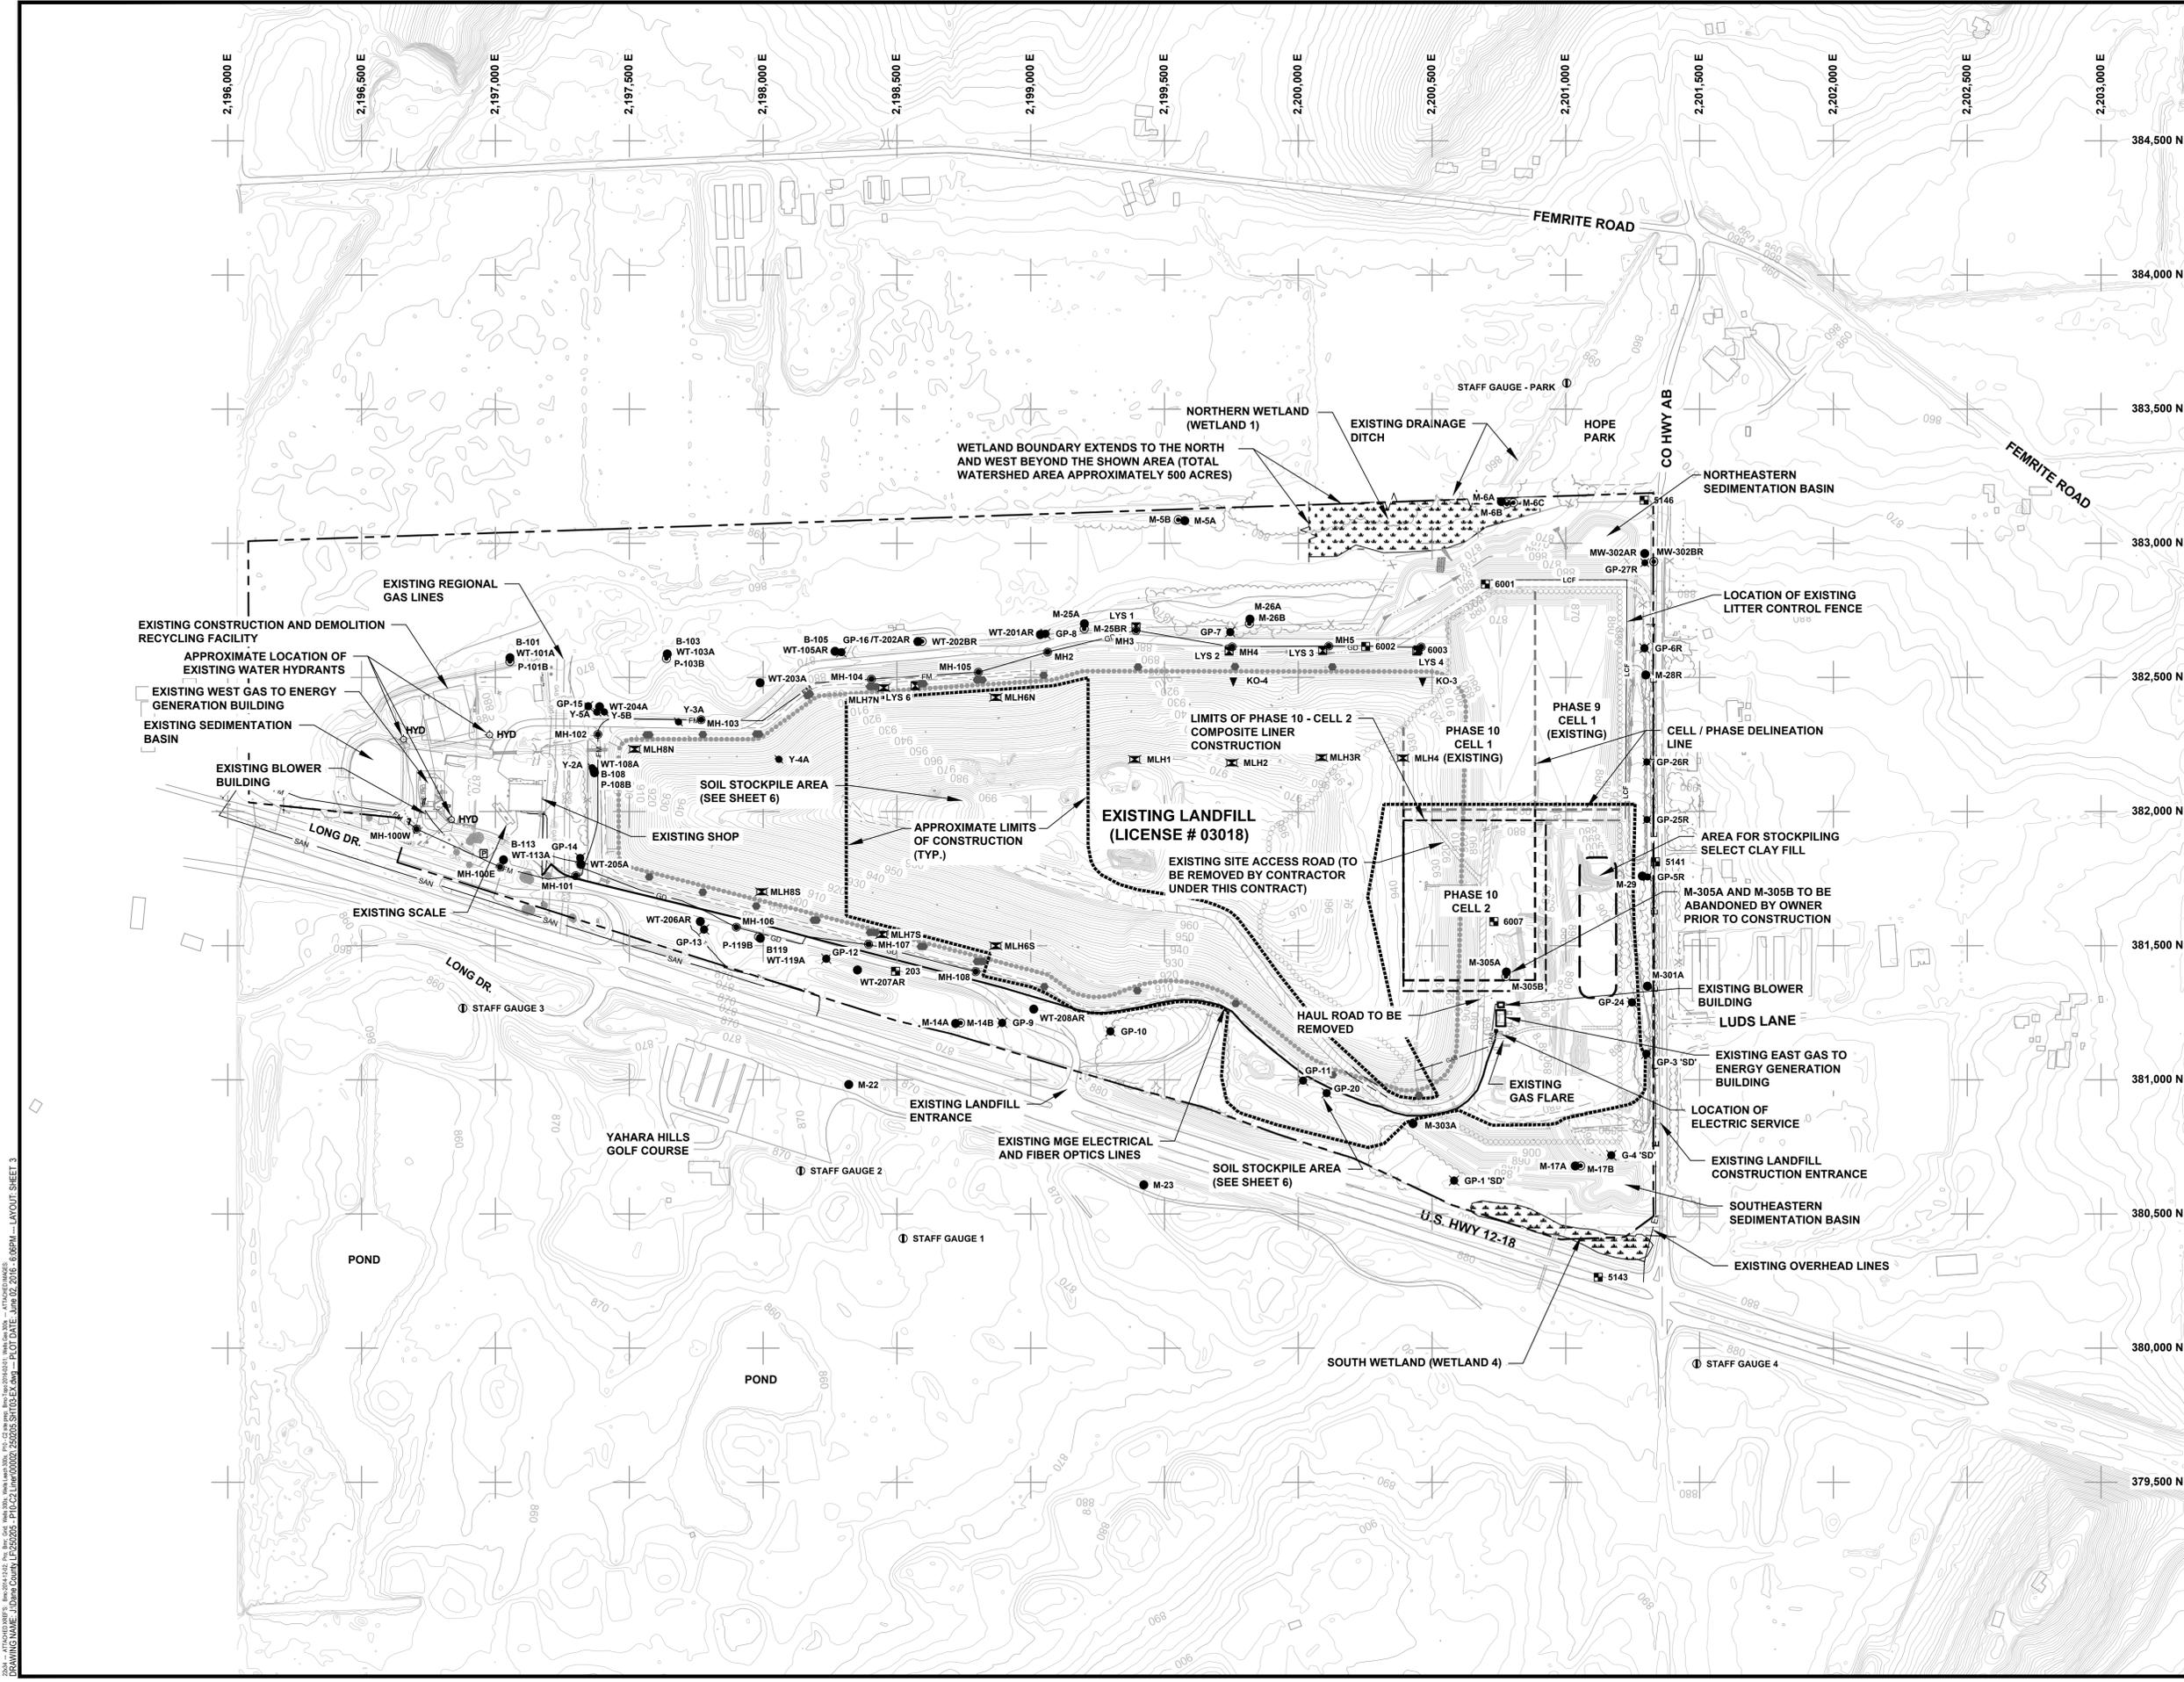

LEGEND

	APPROXIMATE PROPERTY BOUNDARY
	GRID LOCATION
	EXISTING PAVED ROAD
	EXISTING UNPAVED ROAD
	EXISTING FENCE
	EXISTING BUILDING
	EXISTING 10' CONTOUR
	EXISTING 2' CONTOUR
	EXISTING SPOT ELEVATION
	EXISTING TREES AND/OR BRUSH
	EXISTING WET AREA AND WETLAND LIMITS
	EXISTING EDGE OF WATER
	EXISTING OVERHEAD LINES
	DRAINAGE DITCH
	EXISTING APPROVED LIMITS OF WASTE
	APPROVED LIMITS OF WASTE
	CELL/PHASE DELINEATION LINE
	LIMITS OF COMPOSITE LINER CONSTRUCTION
	LIMITS OF CONSTRUCTION
	EXISTING LEACHATE FORCEMAIN LINE
	EXISTING LEACHATE GRAVITY DRAIN LINE
	EXISTING SANITARY SEWER LINE
	EXISTING SURVEY CONTROL MONUMENT
	EXISTING MONITORING WELL LOCATION
	EXISTING PIEZOMETER LOCATION
	EXISTING GAS MONITORING PROBE LOCATION
	EXISTING GAS EXTRACTION WELL
	EXISTING LYSIMETER LOCATION
	EXISTING MANHOLE LOCATION
	EXISTING CLEANOUT LOCATION
	EXISTING LEACHATE HEAD WELL
	EXISTING STAFF GAUGE LOCATION
	EXISTING GRINDER PUMP
	EXISTING WATER HYDRANT
	EXISTING LITTER CONTROL FENCE
	EXISTING HAUL ROAD TO BE REMOVED

- NOTES**
1. PROPERTY BOUNDARIES IN THE VICINITY OF THE EASTERN EXPANSION SURVEYED BY AECOM DATED: SEPTEMBER 19, 2012.
 2. BUILDING INFORMATION PROVIDED BY DANE COUNTY LAND INFORMATION OFFICE MADISON, WI. BUILDING FOOTPRINTS DATED: 2005.
 3. UTILITY LOCATIONS SHOWN PROVIDED BY DANE COUNTY.
 4. PROJECT CONSTRUCTION INCLUDES PHASE 10 - CELL 2 COMPOSITE LINER, ASSOCIATED PIPING AND APPURTENANCES, ACCESS ROADS, STOCKPILE AND BERMS.

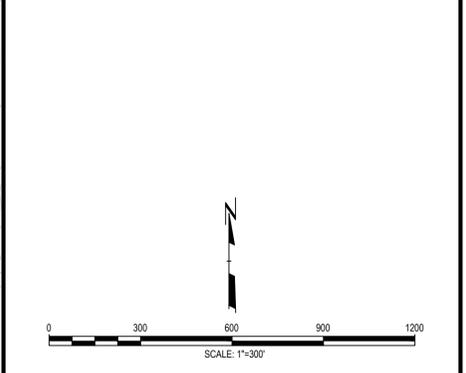

NOTE: THE CONTRACTOR SHALL NOTIFY ALL AREA UTILITY COMPANIES PRIOR TO COMMENCING WORK ON THIS CONTRACT, IN ACCORDANCE WITH STATE AND LOCAL REQUIREMENTS.


NOTE: THESE PLANS ARE ACCOMPANIED BY A PROJECT MANUAL OF THE SAME TITLE. THESE DOCUMENTS ARE INTERRELATED AND ARE INTENDED TO BE USED TOGETHER.

NO.	BY	DATE	REVISION	APPD.
PROJECT: DANE COUNTY NO. 2 (RODEFELD) LANDFILL PHASE 10 - CELL 2 LINER CONSTRUCTION DANE COUNTY, WISCONSIN				
TITLE: EXISTING CONDITIONS MAP				
DRAWN BY: RNOLDEN		PROJ. NO.: 250205.0000.0000.000002		
CHECKED BY: DM		SHEET 3 OF 11		
APPROVED BY: DRG		DATE: JUNE 2016		
DATE: JUNE 2016		FILE NO.: 250205.SHT03-EX.dwg		

TRC

708 Heartland Trail
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FILE NO.: 250205.SHT03-EX.dwg
 DRAWING NAME: J:\Dane County\1250205 - PD-C2 Liner\0002_250205_SHT03-EX.dwg - PLOT DATE: Jun 02 2016 - 6:08PM - LAYOUT-SHEET 3

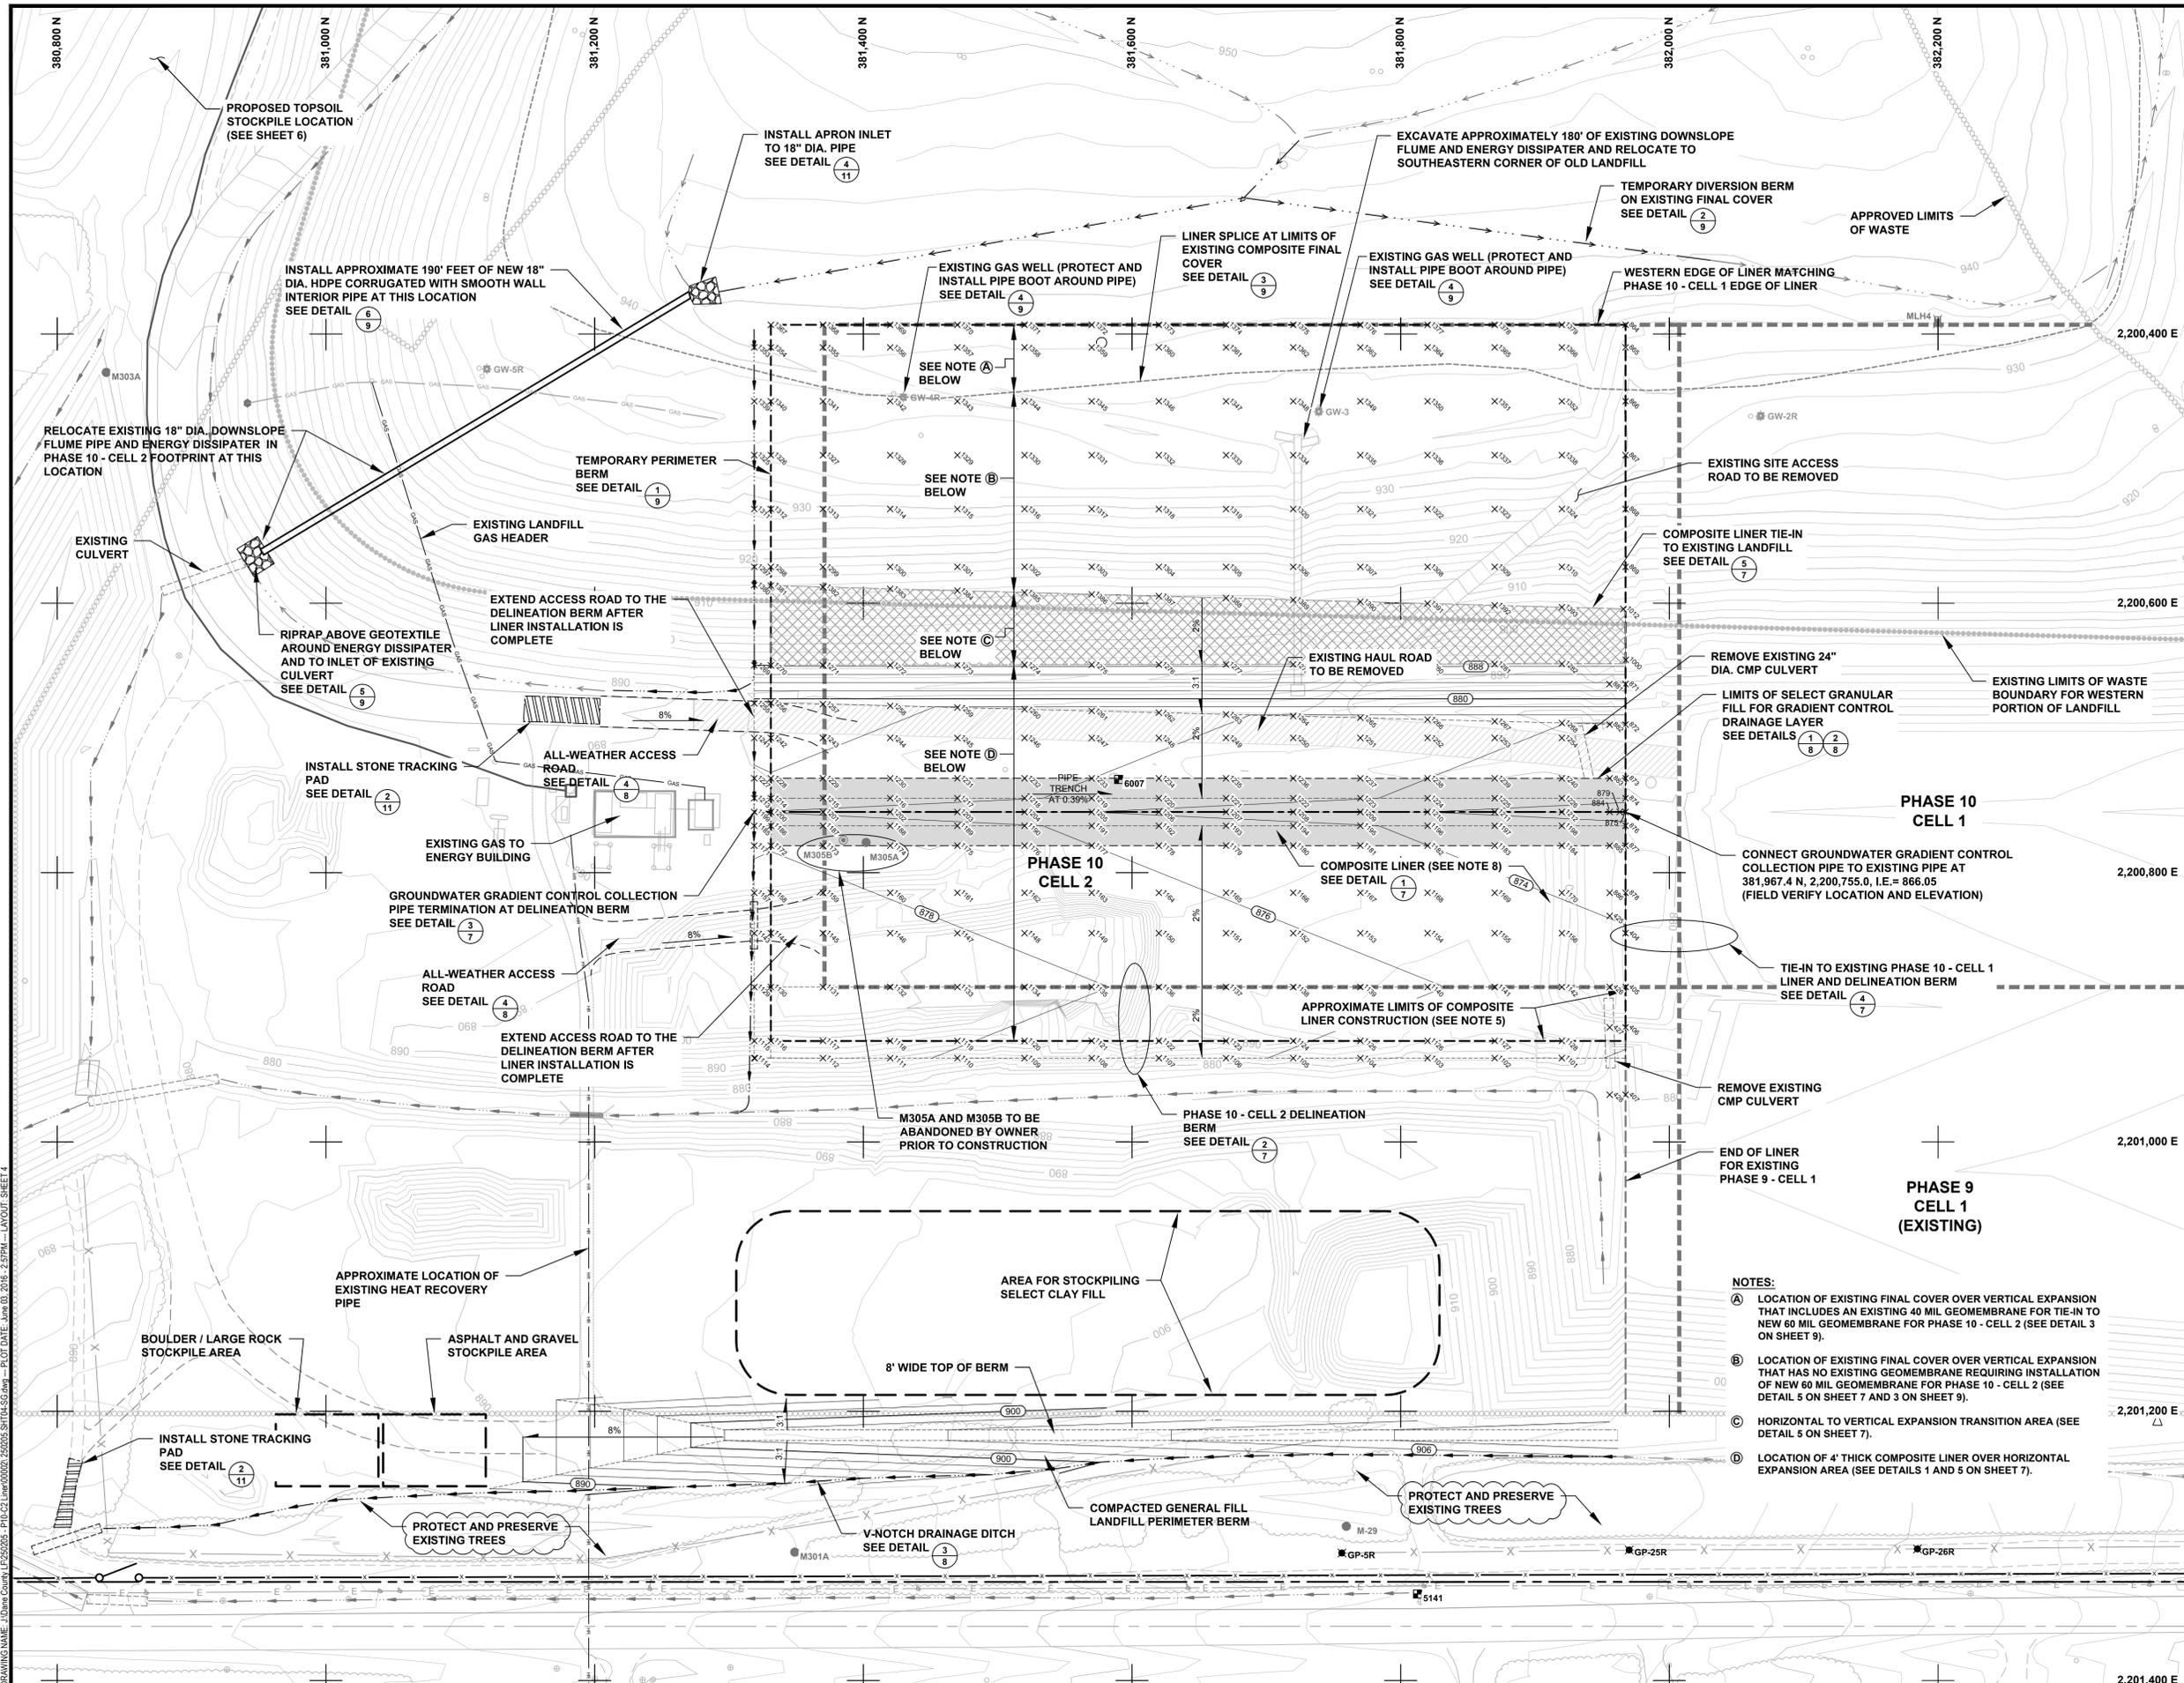

NOTES

- REFER TO SHEET 2 OF THIS PLAN SET FOR LEGEND SYMBOLS AND LIST OF NOTES.
- FULL TONE CONTOURS WITHIN THE LIMITS OF PHASE 10 - CELL 2 COMPOSITE LINER CONSTRUCTION REPRESENT THE BOTTOM OF THE COMPACTED CLAY LINER (SUBBASE GRADES). REFER TO DETAIL 1 ON PLAN SHEET 7 FOR LEACHATE COLLECTION LINE EXCAVATION.
- FULL TONE CONTOURS OUTSIDE THE LIMITS OF PHASE 10 - CELL 2 COMPOSITE LINER CONSTRUCTION REPRESENT FINISHED GRADING (e.g. TOP OF TOPSOIL, TOP OF GRAVEL ROAD, ETC.).
- REFER TO TABLES 1 & 2 FOR CONSTRUCTION COORDINATE LOCATIONS AND ELEVATIONS.
- TIE-IN TO EXISTING LINER IN PHASE 10 - CELL 1 BASED ON TRC ENVIRONMENTAL CORP. PHASE 10 - CELL 1 LINER CONSTRUCTION DOCUMENTATION PLANS, NOVEMBER 2015. TIE-IN TO EXISTING LINER IN PHASE 9 - CELL 1 BASED ON TRC ENVIRONMENTAL CORP. PHASE 9 - CELL 1 LINER CONSTRUCTION DOCUMENTATION PLANS, DECEMBER 2014. CONTRACTOR TO FIELD VERIFY EXISTING LINER LOCATIONS AND ELEVATIONS PRIOR TO CONSTRUCTING LINER SPLICE.
- NO TREES TO BE REMOVED OUTSIDE LIMITS OF CONSTRUCTION LINE.
- TYPE A EROSION CONTROL AND VEGETATION MAT (ECRM) ON ALL 3:1 SLOPES AND STEEPER EXCEPT IN CLAY LINER AREA. REFER TO PLAN SHEET 10.
- LINER SUBBASE AT 0.8% SLOPE AND PIPE TRENCH AT 0.39% SLOPE.



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NO.	BY	DATE	REVISION	APP'D.

PROJECT: DANE COUNTY NO. 2 (RODEFELD) LANDFILL
 PHASE 10 - CELL 2
 LINER CONSTRUCTION
 DANE COUNTY, WISCONSIN


TITLE: SUBBASE GRADES / GROUNDWATER GRADIENT CONTROL SYSTEM

DRAWN BY: RNOLDEN
 CHECKED BY: DM
 APPROVED BY: DRG
 DATE: JUNE 2016

PROJ. NO.: 250205.0000.0000.00002
 SHEET 4 OF 11

- NOTES:**
- (A) LOCATION OF EXISTING FINAL COVER OVER VERTICAL EXPANSION THAT INCLUDES AN EXISTING 40 MIL GEOMEMBRANE FOR TIE-IN TO NEW 60 MIL GEOMEMBRANE FOR PHASE 10 - CELL 2 (SEE DETAIL 3 ON SHEET 9).
 - (B) LOCATION OF EXISTING FINAL COVER OVER VERTICAL EXPANSION THAT HAS NO EXISTING GEOMEMBRANE REQUIRING INSTALLATION OF NEW 60 MIL GEOMEMBRANE FOR PHASE 10 - CELL 2 (SEE DETAIL 5 ON SHEET 7 AND 3 ON SHEET 9).
 - (C) HORIZONTAL TO VERTICAL EXPANSION TRANSITION AREA (SEE DETAIL 5 ON SHEET 7).
 - (D) LOCATION OF 4" THICK COMPOSITE LINER OVER HORIZONTAL EXPANSION AREA (SEE DETAILS 1 AND 5 ON SHEET 7).

DRAWING NAME: J:\Dane County\LP\20205 - PD-C2 (LP)00002 - 250205.SHT4-5.dwg - PLOT DATE: June 02, 2016 - 2:57PM - LAYOUT - SHEET 4
 FILE NO.: 250205.SHT04-SG.dwg

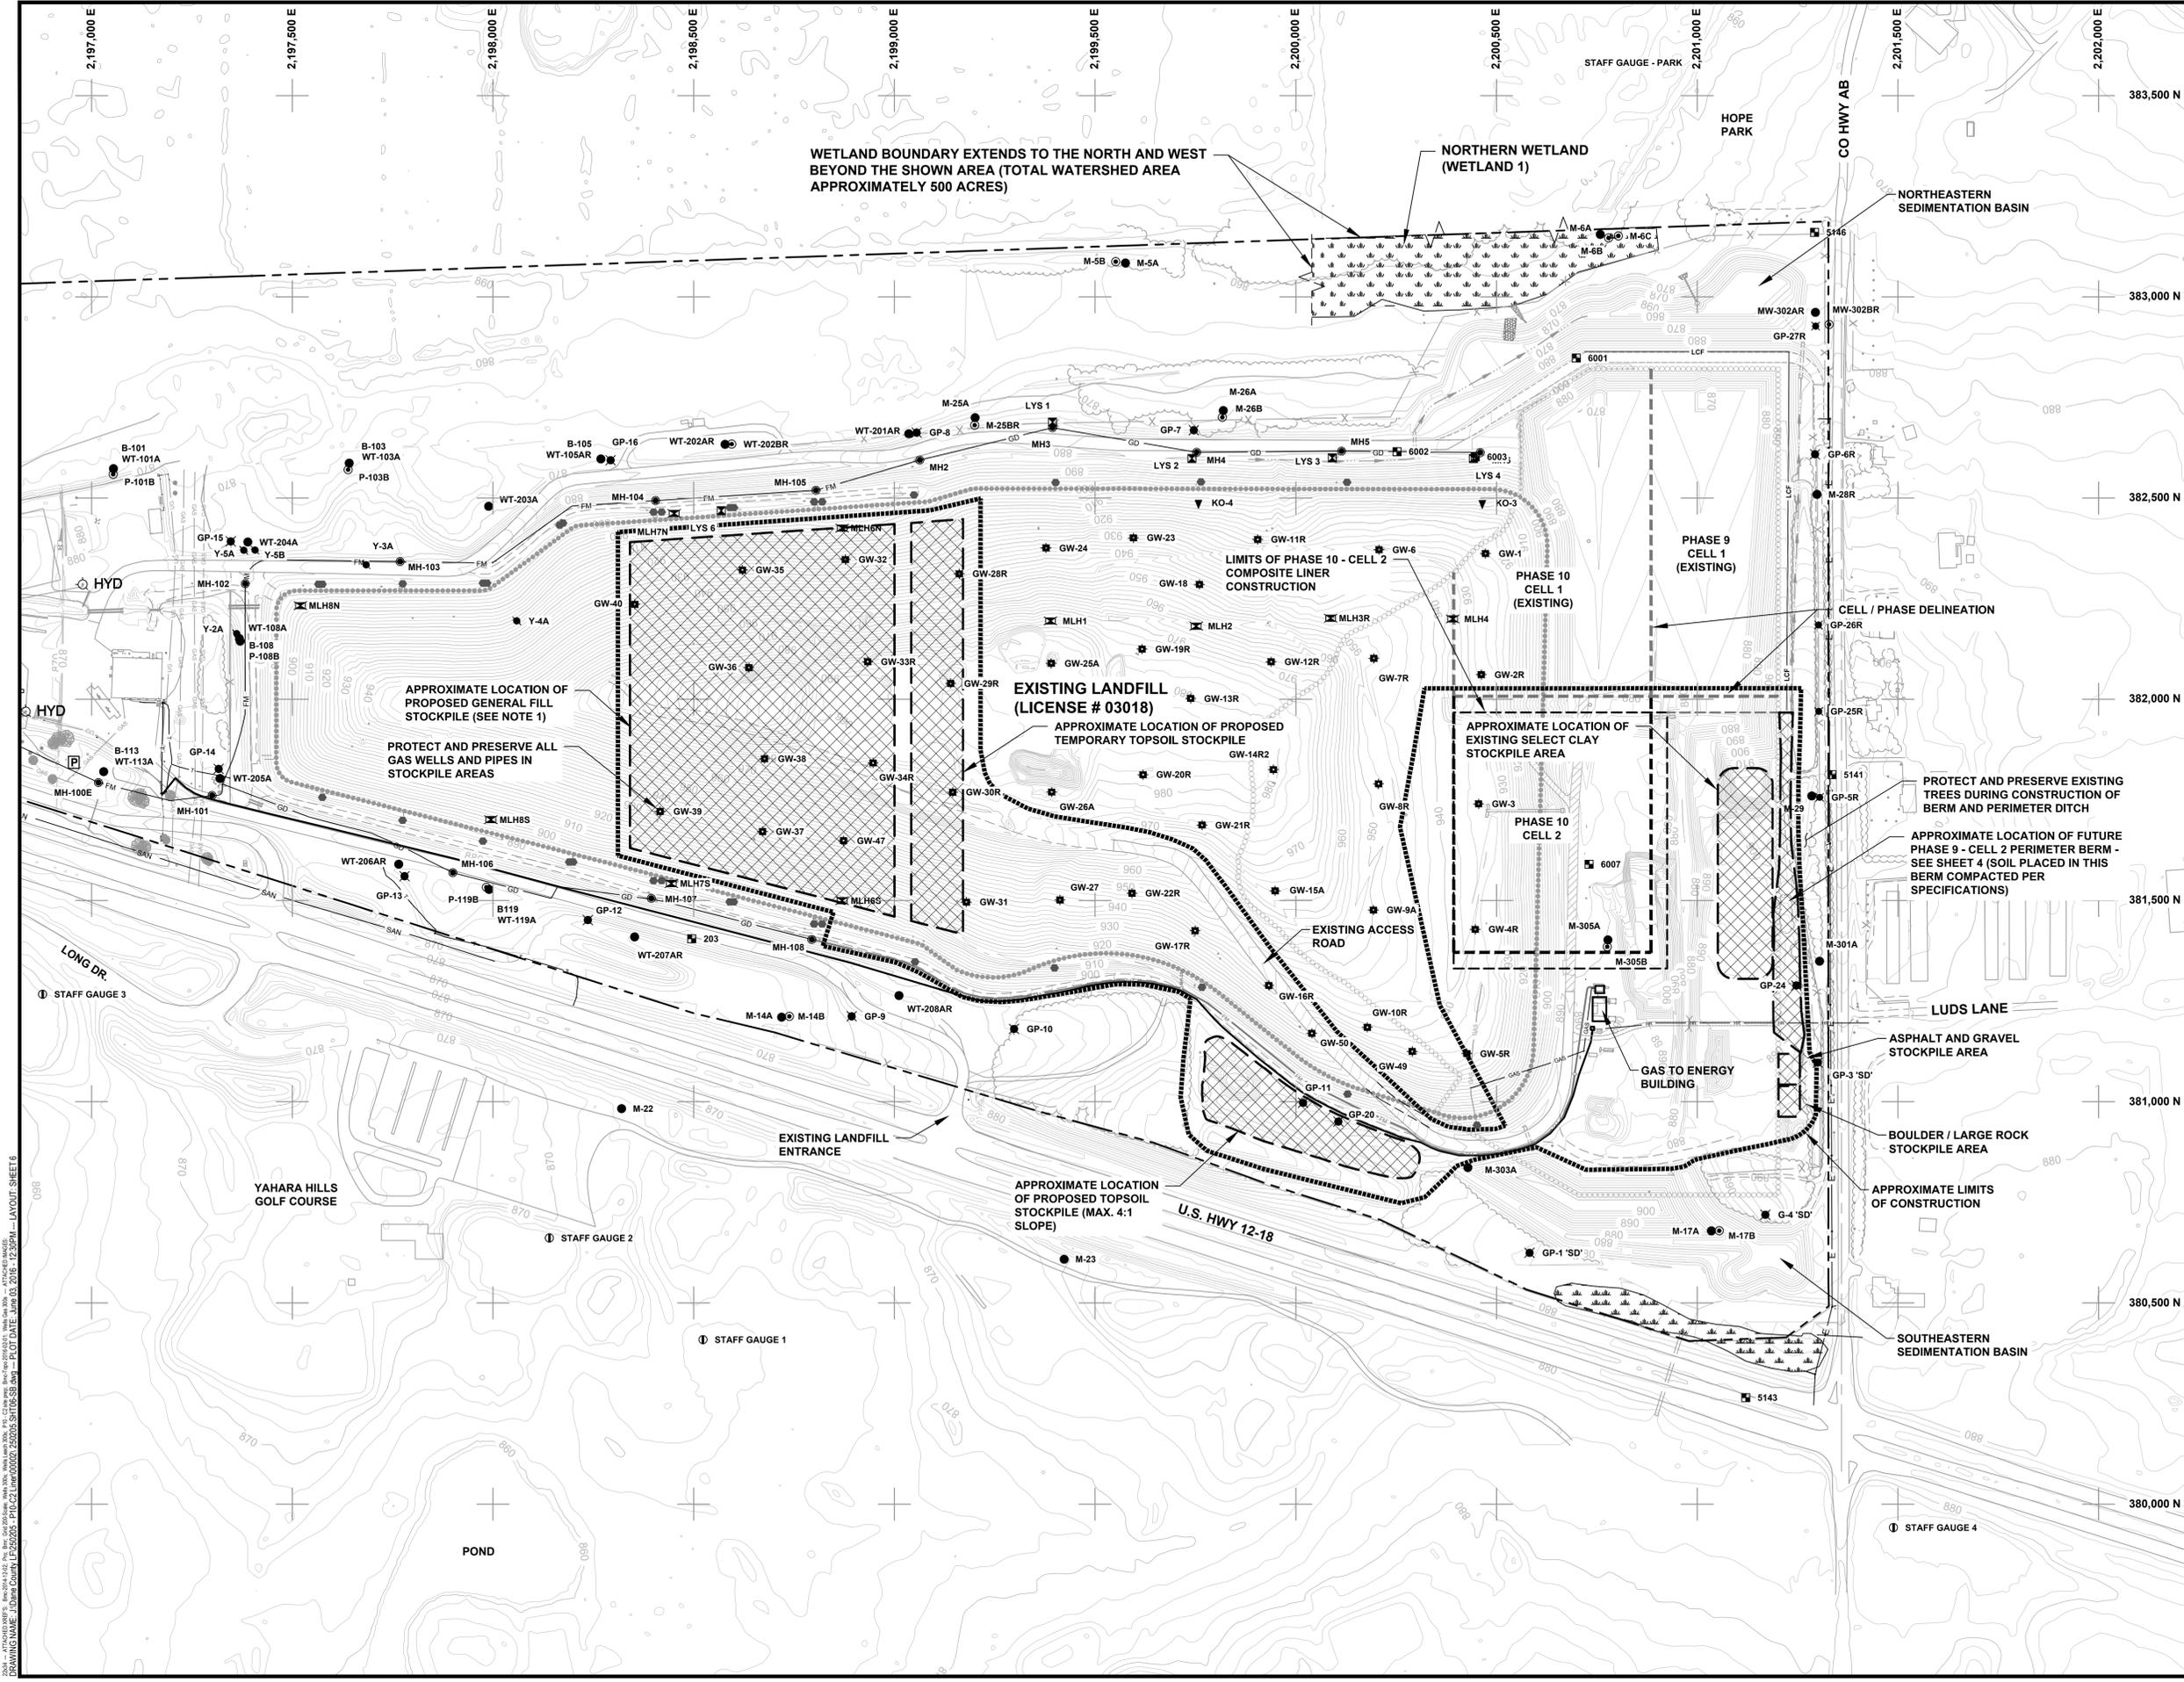

LEGEND

[Hatched Box] APPROXIMATE LIMITS OF AREA FOR STOCKPILING SOIL (GENERAL FILL, TOPSOIL, AND SELECT CLAY FILL)

NOTES

- GENERAL FILL MATERIALS TO BE SEGREGATED BY MATERIAL TYPE WITHIN GENERAL FILL STOCKPILE AREA.
- BOULDERS AND LARGE ROCKS ENCOUNTERED DURING EXCAVATION SHALL BE SEGREGATED AND STOCKPILED AS SHOWN.

SCALE

0 200 400 600 800

NOTES

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NO.	BY	DATE	REVISION	APPD.

PROJECT: **DANE COUNTY NO. 2 (RODEFELD) LANDFILL**
PHASE 10 - CELL 2
LINER CONSTRUCTION
DANE COUNTY, WISCONSIN

TITLE: **SOIL STOCKPILE AREAS**


DRAWN BY: RNOLDEN	PROJ. NO.: 250205.0000.0000.000002
CHECKED BY: DM	
APPROVED BY: DRG	SHEET 6 OF 11
DATE: JUNE 2016	

CTRC


708 Heartland Trail
Suite 3000
Madison, WI 53717
Phone: 608.826.3600

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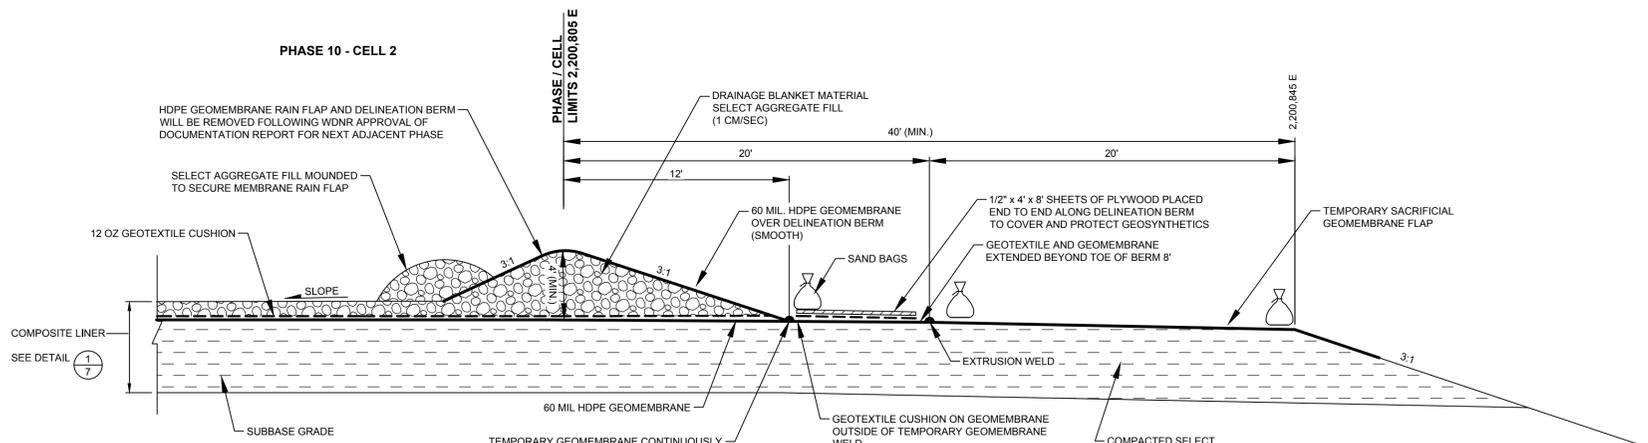
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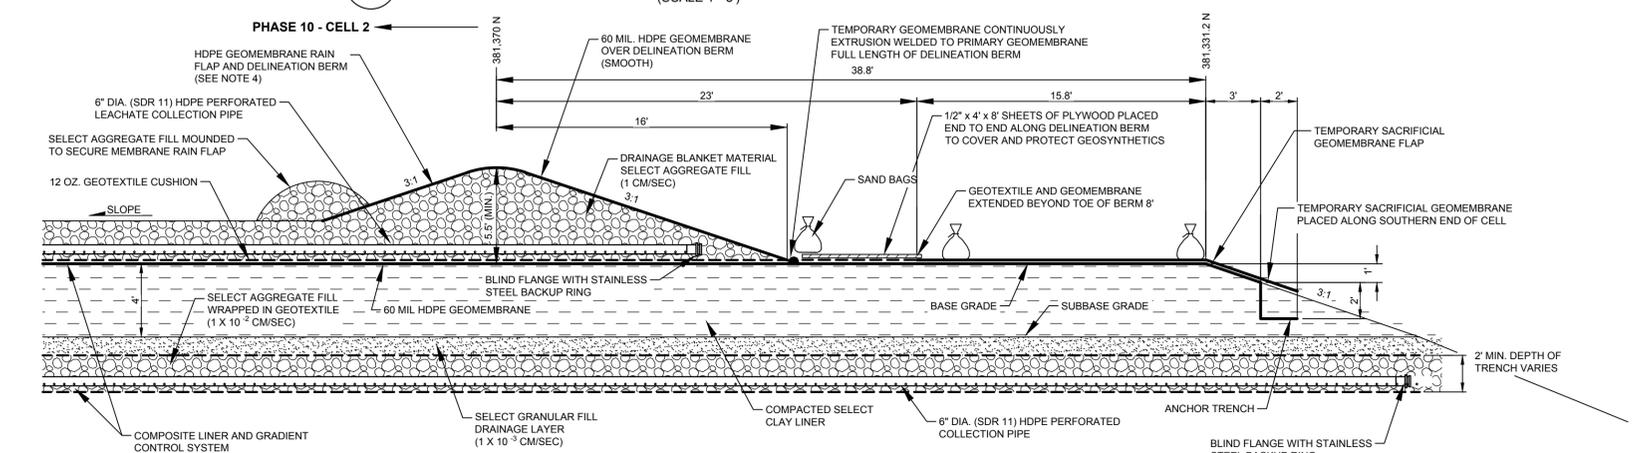
LEACHATE COLLECTION PIPE TRENCH
(NOT TO SCALE)

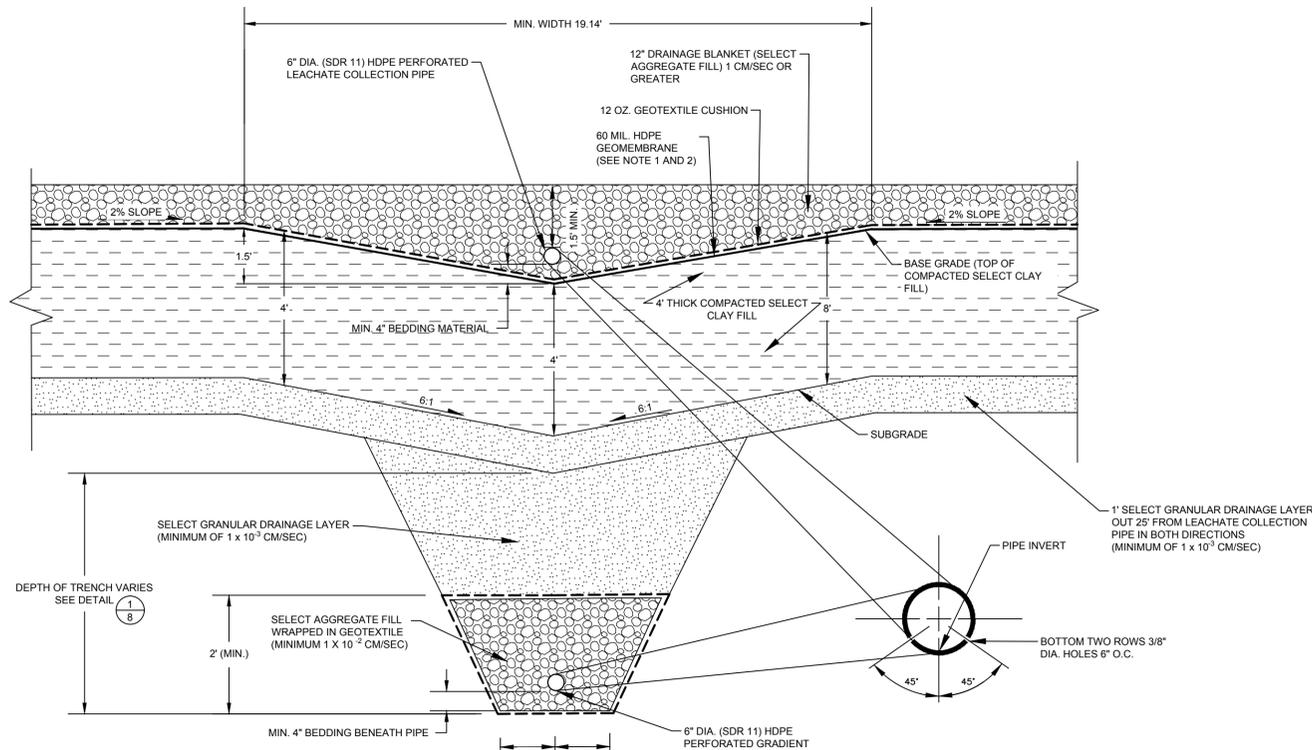


LINER SPLICE BETWEEN PHASE 10 - CELL 2 AND PHASE 10 - CELL 1
(NOT TO SCALE)

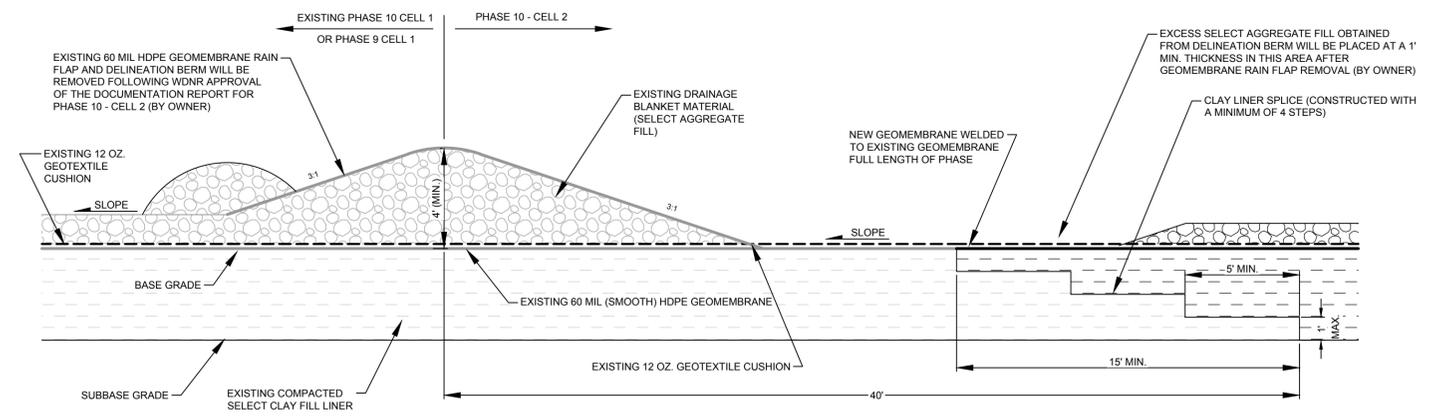

DELINEATION BERM (TYPICAL)
(SCALE 1"=5')



SOUTH DELINEATION BERM AT LEACHATE COLLECTION PIPES
(SCALE 1"=5')

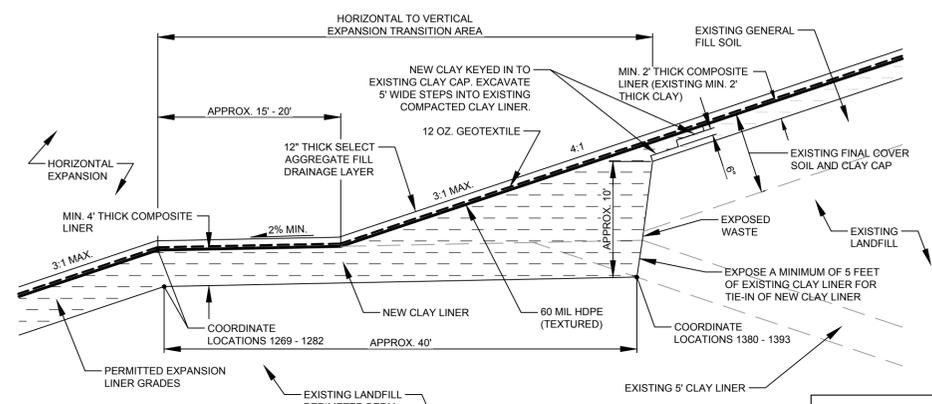

COMPOSITE LINER ANCHOR TIE-IN TO EXISTING LANDFILL
(NOT TO SCALE)

- NOTES**
- HORIZONTAL EXPANSION AREA - REMOVE TOPSOIL AND GENERAL FILL FROM SIDESLOPE OF EXISTING LANDFILL BERM TO THE SUBBASE GRADES SHOWN ON PLAN SHEET 4 AND PLACE MINIMUM 4" COMPOSITE LINER.
 - VERTICAL EXPANSION AREA - REMOVE TOPSOIL AND GENERAL FILL FROM EXISTING FINAL COVER (SEE NOTES A AND B ON PLAN SHEETS 4 AND 5). LEAVE APPROXIMATELY 6" THICK LAYER OF GENERAL FILL OVER EXISTING GEOMEMBRANE IN AREA IDENTIFIED AS AREA A. IN AREA WITH NO GEOMEMBRANE, IDENTIFIED AS AREA B, VERIFY EXISTING 2" THICK CLAY LAYER MEETS COMPACTION REQUIREMENTS PER SPECIFICATIONS OR RECOMPACT TO SPECIFICATION REQUIREMENTS (SECTION 02320).
 - PLACE 60 MIL GEOMEMBRANE OVER 4" THICK CLAY HORIZONTAL EXPANSION LINER AND 2" THICK CLAY VERTICAL EXPANSION LINER. CONTINUOUS WELD 60 MIL GEOMEMBRANE ENTIRE LENGTH OF PHASE.
 - PLACE 12 OZ. GEOTEXTILE AND 1" THICK SELECT AGGREGATE DRAINAGE LAYER OVER HORIZONTAL EXPANSION AND ON VERTICAL OVER-LAP OF EXISTING SITE LANDFILL.
 - BOLD INFORMATION REPRESENTS NEW LINER SYSTEM. SCREENED INFORMATION REPRESENTS EXISTING LINER AND FINAL COVER.

LINE AND SHADING LEGEND


	60 MIL HDPE GEOMEMBRANE		GEOCOMPOSITE
	GEOTEXTILE		TOPSOIL
	GENERAL FILL		NATIVE SOIL
	SELECT GRANULAR FILL		CONCRETE
	BARRIER LAYER FINE GRADED SOIL		RIPRAP
	SELECT AGGREGATE		BITUMINOUS PAVING
	COMPACTED SELECT CLAY FILL		SELECT FOUNDRY BYPRODUCT

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NO.	BY	DATE	REVISION	APP'D.
PROJECT: DANE COUNTY NO. 2 (RODEFELD) LANDFILL				
PHASE 10 - CELL 2				
LINER CONSTRUCTION				
DANE COUNTY, WISCONSIN				
TITLE: DETAILS - HORIZONTAL AREA LINER, GRADIENT CONTROL, AND LEACHATE COLLECTION				
DRAWN BY:	RNOLDEN	PROJ. NO.:	250205.0000.0000.00002	
CHECKED BY:	DM	Suite 3000		
APPROVED BY:	DRG	Madison, WI 53717		
DATE:	JUNE 2016	Phone: 608.826.3600		
SHEET 7 OF 11				


DATE: 06/16/2016 10:00:00 AM
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 PLOT DATE: JUN 02 2016 6:08PM
 LAYOUT: SHEET 7



CROSS SECTION 2,200,755E ALONG LEACHATE / GRADIENT CONTROL PIPES

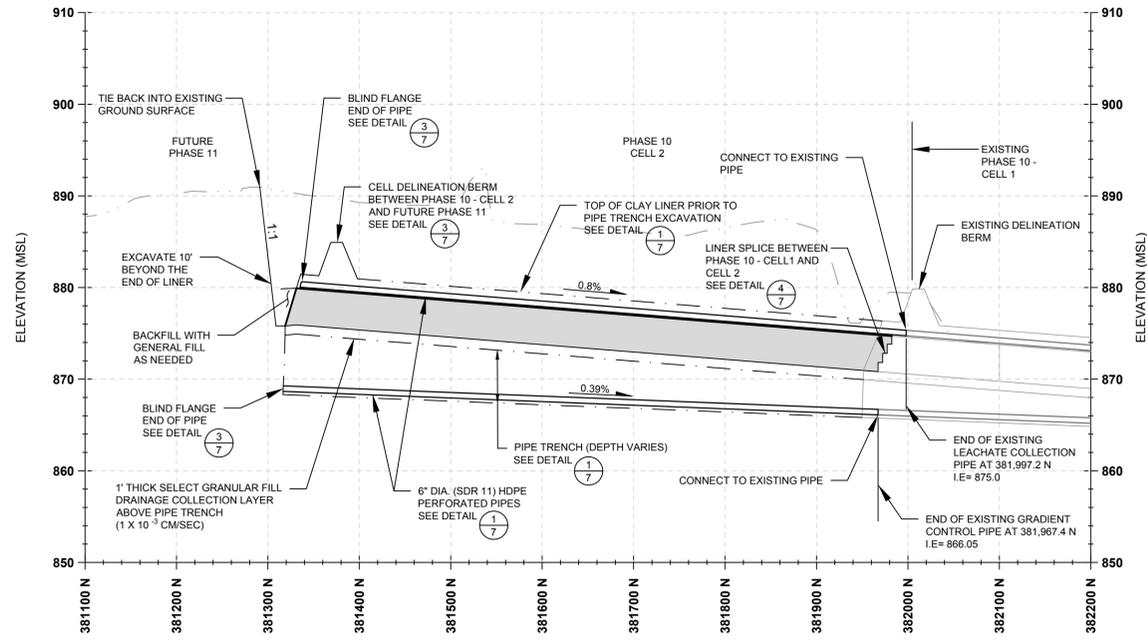1
8


(AS SHOWN)

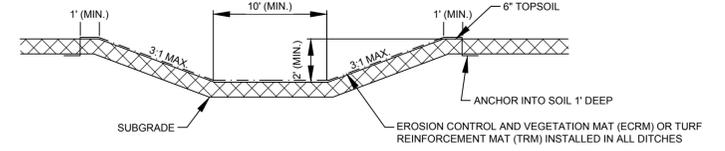

NOTES:

- 1. ECRM AND TRM INSTALLED A MINIMUM OF 2' IN ELEVATION ON SIDE SLOPES OF DITCHES.

FLAT BOTTOM DRAINAGE DITCH

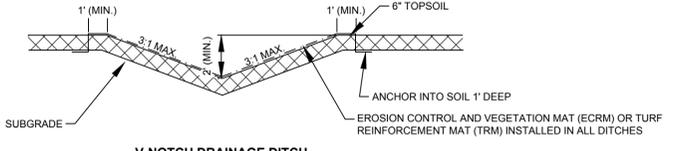


V-NOTCH DRAINAGE DITCH

3
8

PERIMETER DRAINAGE DITCH (TYP.)


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CROSS SECTION 381,600 N - LOOKING NORTH

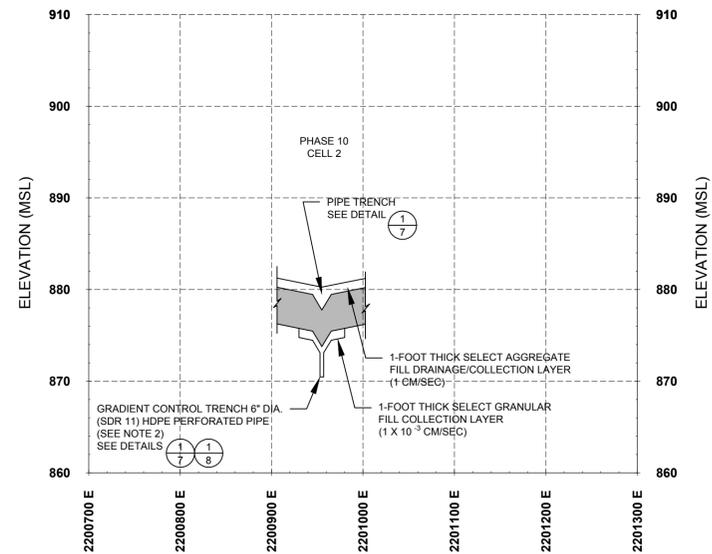
2
8

(AS SHOWN)



CROSS SECTION LOCATOR

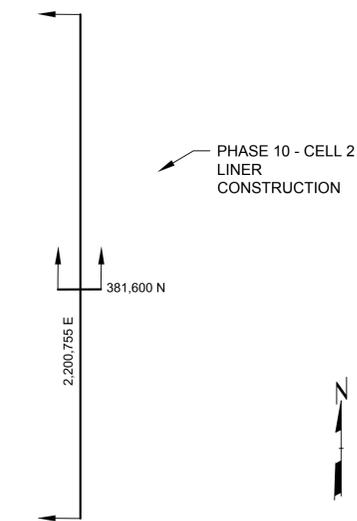1" = 200'

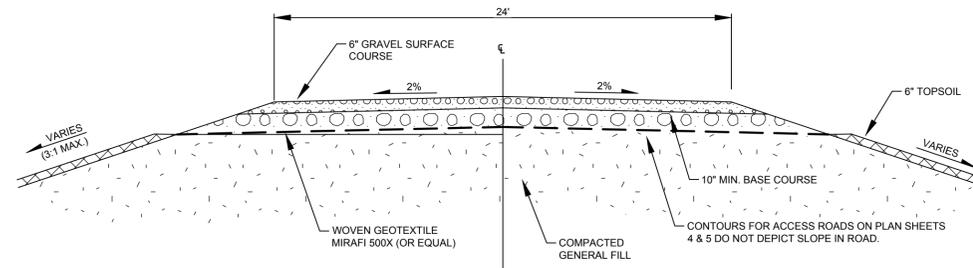

ALL-WEATHER ACCESS ROAD (TYP.)

4
8

(NOT TO SCALE)

NOTES:

- 1. SCREENED INFORMATION REPRESENTS EXISTING FEATURES. BOLD INFORMATION REPRESENTS NEW FEATURES.

LINE AND SHADING LEGEND

60 MIL HDPE GEOMEMBRANE	GEOCOMPOSITE
GEOTEXTILE	
TOPSOIL	NATIVE SOIL
GENERAL FILL	CONCRETE
SELECT GRANULAR FILL	RIPRAP
BARRIER LAYER FINE GRADED SOIL	BITUMINOUS PAVING
SELECT AGGREGATE FILL	SELECT FOUNDRY BYPRODUCT
COMPACTED SELECT CLAY FILL	

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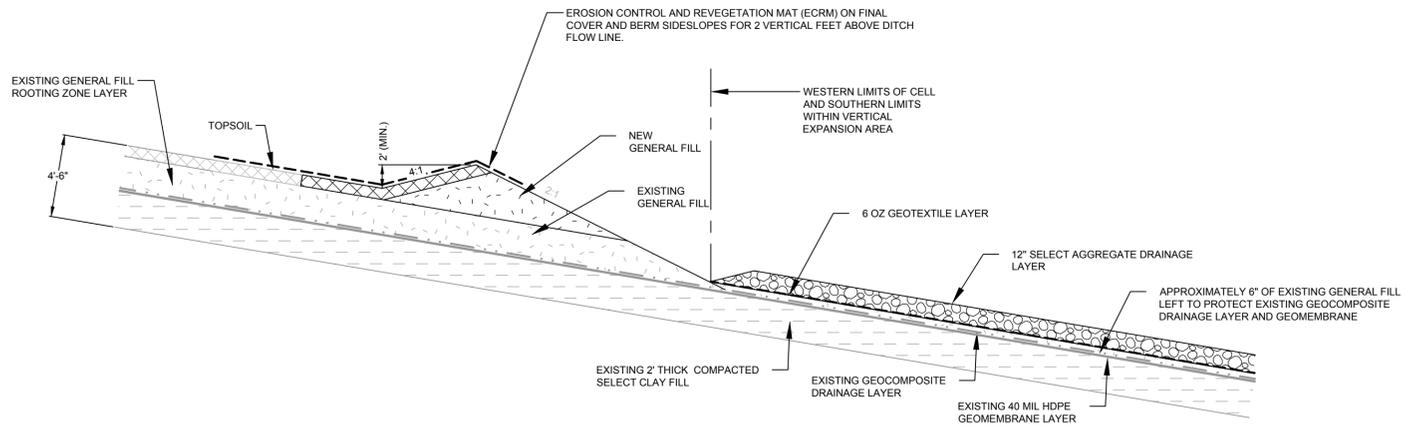
PROJECT: **DANE COUNTY NO. 2 (RODEFELD) LANDFILL
PHASE 10 - CELL 2
LINER CONSTRUCTION
DANE COUNTY, WISCONSIN**

TITLE: **DETAILS - CROSS SECTION AND MISCELLANEOUS**


DRAWN BY: RNOLDEN	PROJ. NO.: 250205.0000.0000.00002
CHECKED BY: DM	
APPROVED BY: DRG	SHEET 8 OF 11
DATE: JUNE 2016	

TRC 708 Heartland Trail Suite 3000 Madison, WI 53717 Phone: 608.826.3600


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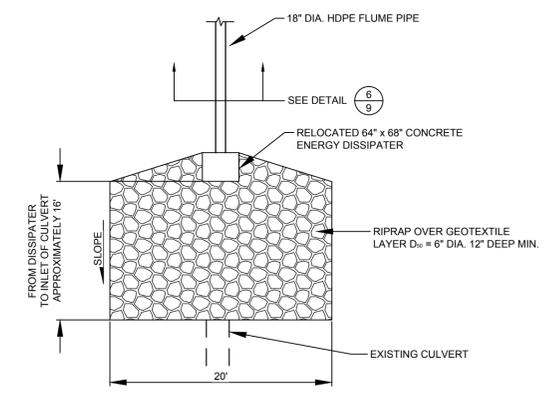
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9 **TEMPORARY PERIMETER BERM**
(AS SHOWN)




4
9 **GAS PIPE BOOT (TYPICAL)**
(NOT TO SCALE)

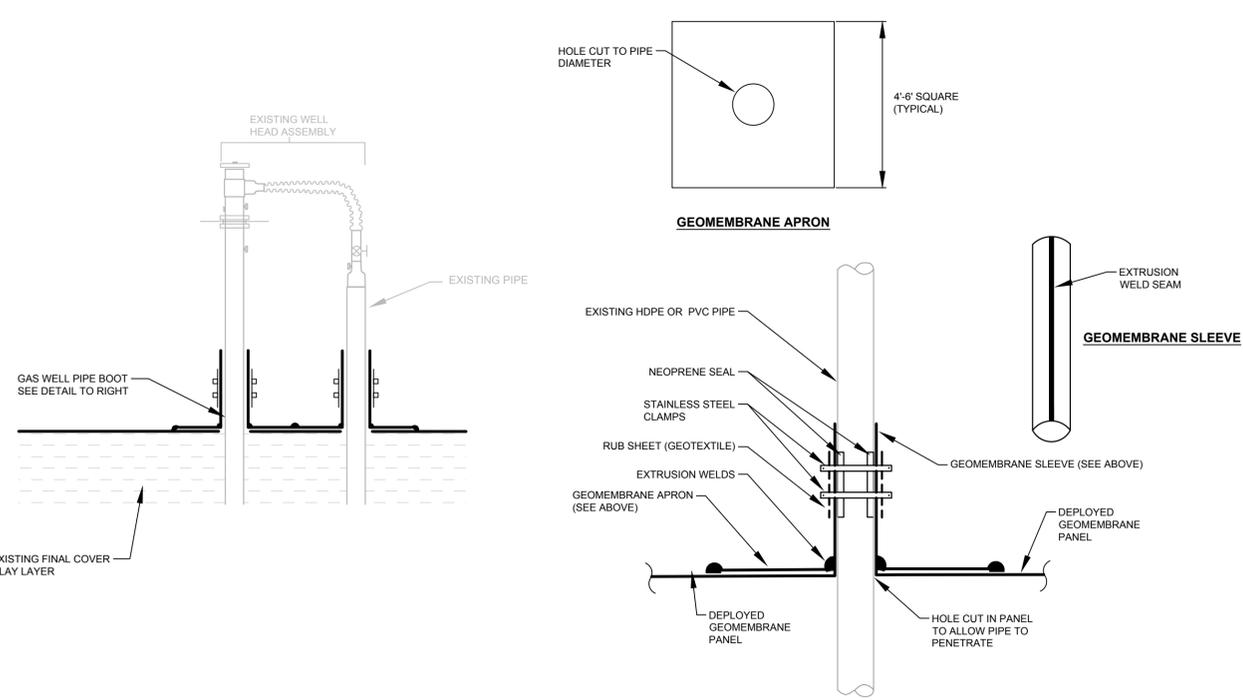


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9 **TEMPORARY DIVERSION BERM OVER EXISTING FINAL COVER**
(NOT TO SCALE)

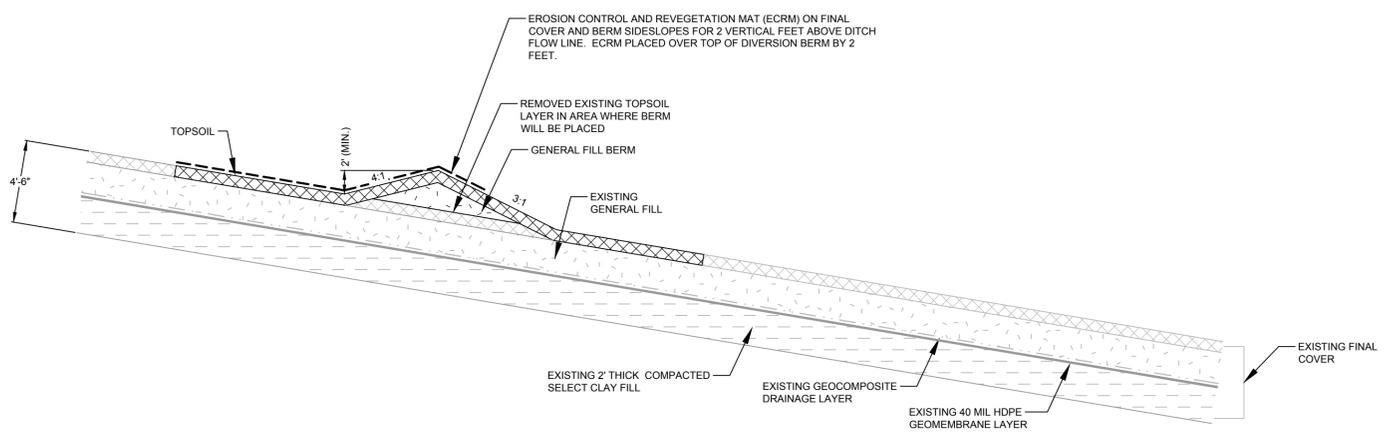

5
9 **DOWNSLOPE FLUME OUTLET (TYPICAL)**
(NOT TO SCALE)

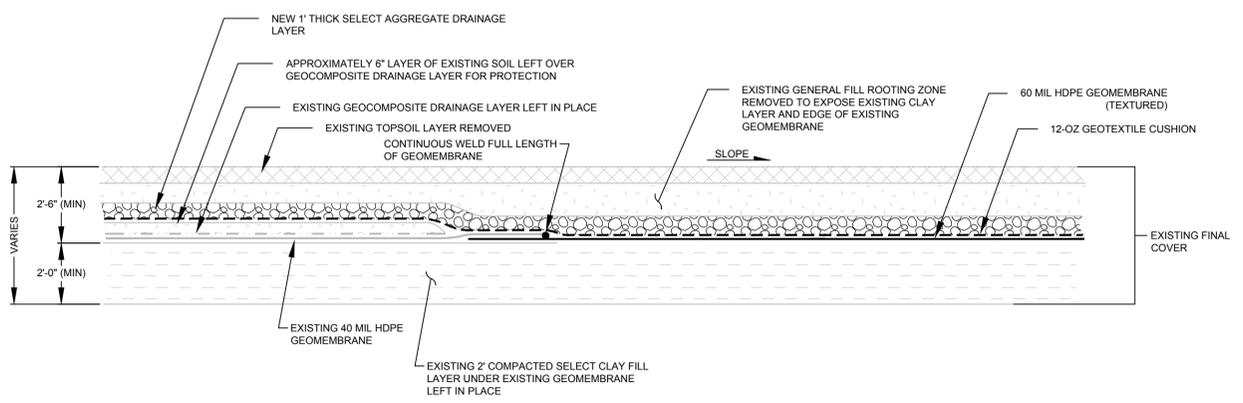

3
9 **LINER SPLICE IN EXISTING FINAL COVER AT JUNCTION OF NEW AND OLD GEOMEMBRANE**
NOT TO SCALE

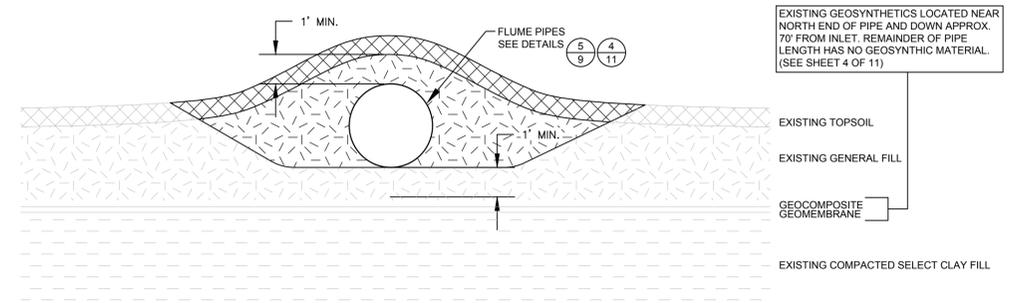

6
9 **DOWNSLOPE FLUME SECTION A-A' (TYPICAL)**
NOT TO SCALE

NOTES:
1. SCREENED INFORMATION REPRESENTS EXISTING FEATURES. BOLD INFORMATION REPRESENTS NEW FEATURES.

LINE AND SHADING LEGEND	
60 MIL HDPE GEOMEMBRANE	GEOCOMPOSITE DRAINAGE LAYER
GEOTEXTILE	
TOPSOIL	NATIVE SOIL
GENERAL FILL	CONCRETE
SELECT GRANULAR FILL	RIPRAP
BARRIER LAYER FINE GRADED SOIL	BITUMINOUS PAVING
SELECT AGGREGATE FILL	SELECT FOUNDRY BYPRODUCT
COMPACTED SELECT CLAY FILL	

NOTE: THE CONTRACTOR SHALL NOTIFY ALL AREA UTILITY COMPANIES PRIOR TO COMMENCING WORK ON THIS CONTRACT, IN ACCORDANCE WITH STATE AND LOCAL REQUIREMENTS.

NOTE: THESE PLANS ARE ACCOMPANIED BY A PROJECT MANUAL OF THE SAME TITLE. THESE DOCUMENTS ARE INTERRELATED AND ARE INTENDED TO BE USED TOGETHER.

NO.	BY	DATE	REVISION	APP'D.

PROJECT: **DANE COUNTY NO. 2 (RODEFELD) LANDFILL PHASE 10 - CELL 2 LINER CONSTRUCTION DANE COUNTY, WISCONSIN**

TITLE: **DETAILS - TIN-IN TO EXISTING FINAL COVER AND MISCELLANEOUS**

DRAWN BY: RNOLDEN	PROJ. NO.: 250205.0000.0000.00002
CHECKED BY: DM	
APPROVED BY: DRG	SHEET 9 OF 11
DATE: JUNE 2016	

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FILE: \\trc\projects\16051\16051.dwg - PLOT DATE: June 02, 2016 - 4:16:46 PM - LAYOUT: SHEET 9
 DRAWING NAME: J:\Dane County\16051\16051.dwg - PLOT DATE: June 02, 2016 - 4:16:46 PM - LAYOUT: SHEET 9