
COUNTY OF DANE CITY COUNTY BUILDING COOLING TOWER REPLACEMENT PROJECT MADISON, WISCONSIN

BID DOCUMENT PACKAGE

NOVEMBER 15, 2016

COUNTY OF DANE RFB NO 316047



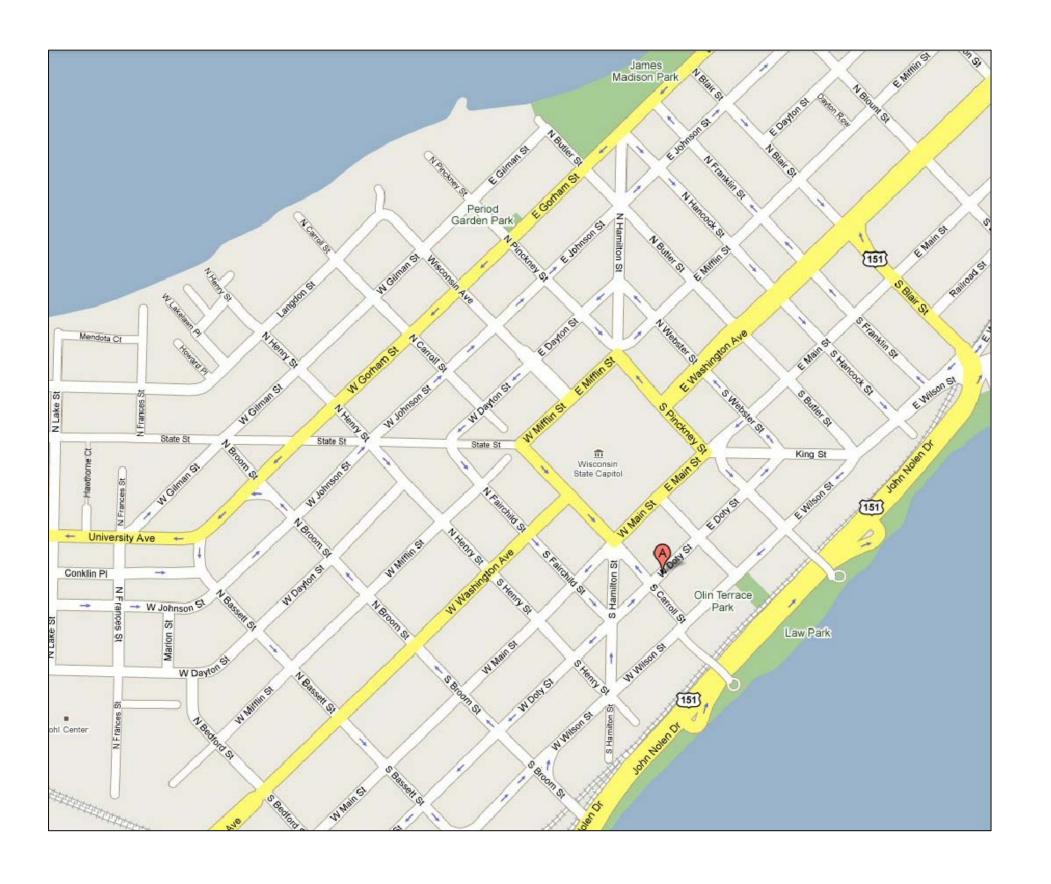

CITY COUNTY BUILDING 210 MARTIN LUTHER KING JR. BLVD MADISON, WISCONSIN 53703

T100 TITLESHEET

ME000 ABBREVIATIONS AND SYMBOLS

ME100 OVERALL EXISTING SITE PHOTOS

ME101 EXISTING COOLING TOWER PHOTOS

ME200 PENTHOUSE AND ROOF PLAN - DEMOLITION - HVAC & ELECTRICA

ME300 PENTHOUSE AND ROOF PLAN - NEW WORK - HVAC & ELECTRICA



CONSULTANTS

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	PROJECT	
CITY COUNTY		
BUILDING		

TITLE SHEET

REPLACEMENT PROJECT



CHECKED: TDM DATE: 11/15/2016												MADISON, PH: 608.277.1728 F	
Second	DID. 110 - 01/075140						40000 #4TIONIO						
Column	1		igotimes				A COMPRESSED AIR		HW HOT WATER	RF RETURN FAN			
March Marc	Г		⟨₩				ACCU AIR COOLED CONDENSING UNIT ACU AIR CONDITIONING UNIT	EAT ENTERING AIR TEMPERATURE EC ELECTRICAL CONTRACTOR	HWS HOT WATER SUPPLY HWY HIGHWAY	RH RELIEF HOOD RHG REFRIGERANT HOT GAS	THERMOSTAT OR TEMPERATURE SENSOR		
Second S	T						ADJ ADJUSTABLE A/E ARCHITECT/ENGINEER	EER ENERGY EFFICIENCY RATIO EFBP EXTERNAL FACE & BYPASS	HYD HYDRANT	RPM REVOLUTIONS PER MINUTE RS REFRIGERANT SUCTION		CONOLU TANTO	
	T		O				AFF ABOVE FINISHED FLOOR AFMS AIR FLOW MEASURING STATION	EJ EXPANSION JOINT EL ELEVATION	IFBP INTERNAL FACE & BYPASS	RTU ROOF TOP UNIT	HUMIDISTAT OR HUMIDITY SENSOR WITH SECURITY COVER	CONSULTANTS	
Part	ķ	GATE, ANGLE VALVE		PIPE ANCHOR	——————————————————————————————————————	BOILER BLOWDOWN	AL ALUMINUM AMP AMPERE	EQUIP EQUIPMENT ER EXHAUST REGISTER	INV INVERT	SA SUPPLY AIR SCR SILICONE CONTROLLED RECTIFIERS			
## 1		GLOBE VALVE	<u> </u>	BALL JOINT	—— PD ——	PUMP DISCHARGE CONDENSATE	APD AIR PRESSURE DROP ASC ABOVE SUSPENDED CEILING	ET EXPANSION TANK ETR EXISTING TO REMAIN	JWR JACKET WATER RETURN JWS JACKET WATER SUPPLY	SEER SEASONAL ENERGY EFFICIENCY RATIO SEG SECURITY EXHAUST GRILLE	S SPEED CONTROLLER		
March Marc	<u> </u>	GLOBE, ANGLE VALVE		EXPANSION JOINT	VAC	VACUUM PUMP CONDENSATE	ATS AIR TROFFER — SUPPLY	EWT ENTERING WATER TEMPERATURE EXH EXHAUST		SG SUPPLY GRILLE SM SHEET METAL	\$ START/STOP SWITCH		
California Cal				EXPANSION LOOP	CW	COLD WATER (DOMESTIC)	B BOILER	F FURNACE	LBS POUNDS LD LINEAR DIFFUSER	SR SUPPLY REGISTER SRG SECURITY RETURN GRILLE	EXISTING TO REMAIN (DUCTWORK, PIPING, & EQUIPMENT)		
	——————————————————————————————————————	SEE SPECIFICATIONS FOR TYPE		FLEXIBLE CONNECTOR	MU		BC BOOSTER COIL BDD BACK DRAFT DAMPER	°F DEGREES FAHRENHEIT F&B FACE & BYPASS	LPC LOW PRESSURE CONDENSATE LPS LOW PRESSURE STEAM	SRV SAFETY RELIEF VALVE SS STAINLESS STEEL			
Section Sect	' +	VALVE (FLOW MEASURING)	/	STEAM TRAP	·		BHP BRAKE HORSEPOWER BI BACKWARD INCLINED	FA FREE AREA FC FORWARD CURVED	LT LIGHT TROFFER	STG SECURITY TRANSFER GRILLE SWD SINGLE WALL DUCTWORK			
Column C	*						BOD BOTTOM OF DUCT BOP BOTTOM OF PIPE	FD FLOOR DRAIN OR FIRE DAMPER FFA FROM FLOOR ABOVE	MAT MIXED AIR TEMPERATURE	T THERMOSTAT/TEMPERATURE SENSOR	NEW DUCTWORK/PIPING		
Column C	П	2-WAY TEMPERATURE CONTROL VALVE	Φ		FOR	FUEL OIL RETURN	BR BRINE RETURN BRG BEARING	FILL FILL LINE FLA FULL LOAD AMPS	MAU MAKE-UP AIR UNIT MAX MAXIMUM	TCAC TEMPERATURE CONTROL AIR COMPRESSOR TCC TEMPERATURE CONTROL CONTRACTOR	NEW EQUIPMENT		
Market	兄.	(ELECTRIC) 3-WAY TEMPERATURE CONTROL VALVE	DN UP		· · ·		BSMT BASEMENT	FM FLOW METER FOO FUEL OIL OVERFLOW	MCA MINIMUM CIRCUIT AMPS MCC MOTOR CONTROL CENTER	TCV TEMPERATURE CONTROL VALVE TEMP TEMPORARY			
	-		P				CA COMBUSTION AIR	FOS FUEL OIL SUPPLY FOV FUEL OIL VENT	MEZZ MEZZANINE MFS MAXIMUM FUSE SIZE	TFA TO FLOOR ABOVE TFB TO FLOOR BELOW			
March Marc		DRAIN VALVE	PS				CCC COOLING COIL CONDENSATE CD CEILING DIFFUSER	FPM FEET PER MINUTE FS FLOW SENSOR	MIN MINIMUM MOCP MAXIMUM OVERCURRENT PROTECTION	TO TEST OPENINGS TS TIP SPEED			
Marked M	<u> </u>		— 				CDS CONDENSER WATER SUPPLY CFM CUBIC FEET PER MINUTE	G GAS	MUA MAKE-UP AIR UNIT	UH UNIT HEATER		ISSUED	
March Marc		NEEDLE VALVE	\Diamond	PUMP IN VERTICAL			CH CHILLER CWR CHILLED WATER RETURN CWS CHILLED WATER SUPPLY	GAL GALLON GALV GALVANIZED	NC NORMALLY CLOSED NIC NOT IN CONTRACT	UV UNIT VENTILATOR			
March	─ ₩	PRESSURE REDUCING VALVE		STRAINER			CL CENTERLINE CLG CEILING	GLYR GLYCOL RETURN GLYS GLYCOL SUPPLY	NPLV NOMINAL PART LOAD VALUE	VAC VACUUM			
March 1 March 2 Marc	\$	RELIEF (R) OR SAFETY (S) VALVE		STRAINER, W/ BLOW DOWN VALVE			COMB COMBINATION OR COMBUSTION	GPM GALLONS PER MINUTE	O OXYGEN	VAV VARIABLE AIR VOLUME VB VACUUM BREAKER			
Mark	——————————————————————————————————————	SOLENOID VALVE		THERMOMETER	— —RS— —	REFRIGERANT SUCTION	COND CONDENSATE CONTR CONTRACTOR	H HUMIDIFIER	OC ON CENTER	VEL VELOCITY			
Company Comp	 II	BLIND FLANGE	—— <u>L</u>	THERMOMETER WELL, ONLY		REFRIGERANT LIQUID	CP CONDENSATE PUMP CRU COMPUTER ROOM UNIT	HB HOSE BIBB HC HEATING CONTRACTOR	P PUMP	VFD VARIABLE FREQUENCY DRIVE			
1		CAP		PETES PLUG			CU COPPER CUH CABINET UNIT HEATER	HCS HOT/CHILLED WATER SUPPLY HD HUB DRAIN	PD PUMP DISCHARGE PLBG PLUMBING	WB WET BULB			
Cooling Cool	.l.						D DRAIN	HG MERCURY HGT HEIGHT	PRE POWER ROOF EXHAUST FAN PRELIM PRELIMINARY	WF WALL FIN WP WEATHER PROOF			
Secretary Secret					CR		DC DRY COOLER DCO DOOR CUTOFF BY GC	HPC HIGH PRESSURE CONDENSATE HPS HIGH PRESSURE STEAM	PRV PRESSURE REDUCING VALVE PS PRESSURE SWITCH				
1	6		.1.			CHILLED WATER SUPPLY	DEPT DEPARTMENT DG DOOR GRILLE BY GC	HPWR HEAT PUMP WATER RETURN HPWS HEAT PUMP WATER SUPPLY	PSI POUNDS PER SQUARE INCH PTAC PACKAGED TERMINAL AIR CONDITIONER				
THE PROPERTY OF THE PROPERTY O			T			CHILLED WATER RETURN	DN DOWN DSA DUCT SOUND ATTENUATOR	HRU HEAT RECOVERY UNIT HSR HEAT SINK RETURN	R REFRIGERANT				
## 1999 A	———		·				DWD DUAL WALL DUCTWORK	HTWR HIGH TEMPERATURE HOT WATER RETURN HTWS HIGH TEMPERATURE HOT WATER SUPPLY	RCP RADIANT CEILING PANEL RD ROOF DRAIN				
**************************************		REDUCER, ECCENTRIC - STRAIGHT CROWN		FLOW REGULATOR	U	DRAIN	DWG DRAWING	HVAC HEATING VENTILATING AND AIR CONDITIONING	REQD REQUIRED				

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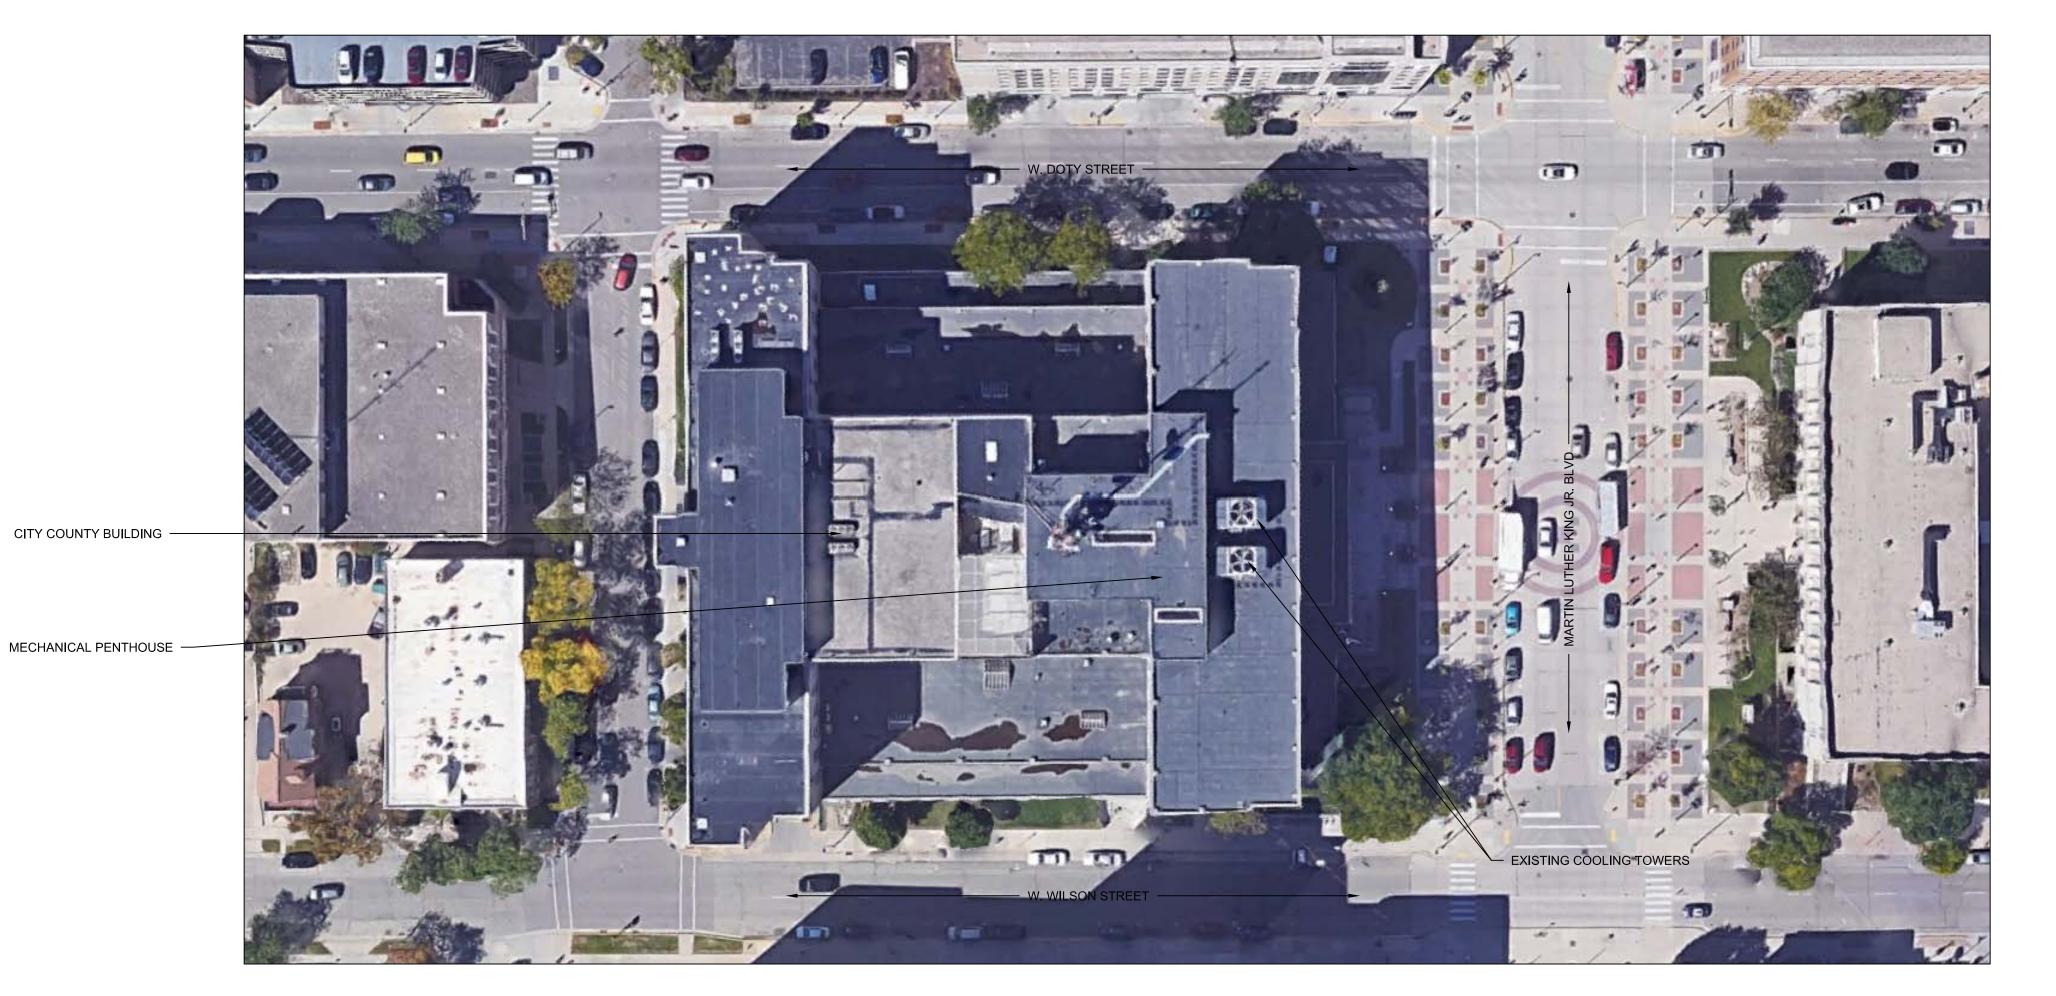
ME000

ABBREVIATIONS

AND SYMBOLS

GENERAL NOTES:

- CONTRACTOR RESPONSIBLE FOR ALL ASPECTS AND LOGISTICS OF REMOVAL OF EXISTING COOLING TOWERS FROM ROOF AND INSTALLATION OF NEW COOLING TOWERS AT SAME LOCATION INCLUDING CRANING, RIGGING, STREET CLOSURE, PERMITS, ETC.
- ALL ASPECTS OF COOLING TOWER REMOVAL AND INSTALLATION SHALL BE FULLY COORDINATED WITH CITY COUNTY BUILDING FACILITY ENGINEERING, DANE COUNTY PUBLIC WORKS AND CITY OF MADISON PUBLIC WORKS AND CITY OF MADISON POLICE DEPARTMENT.








EXISTING MECHANICAL PENTHOUSE

L EXISTING COOLING TOWERS

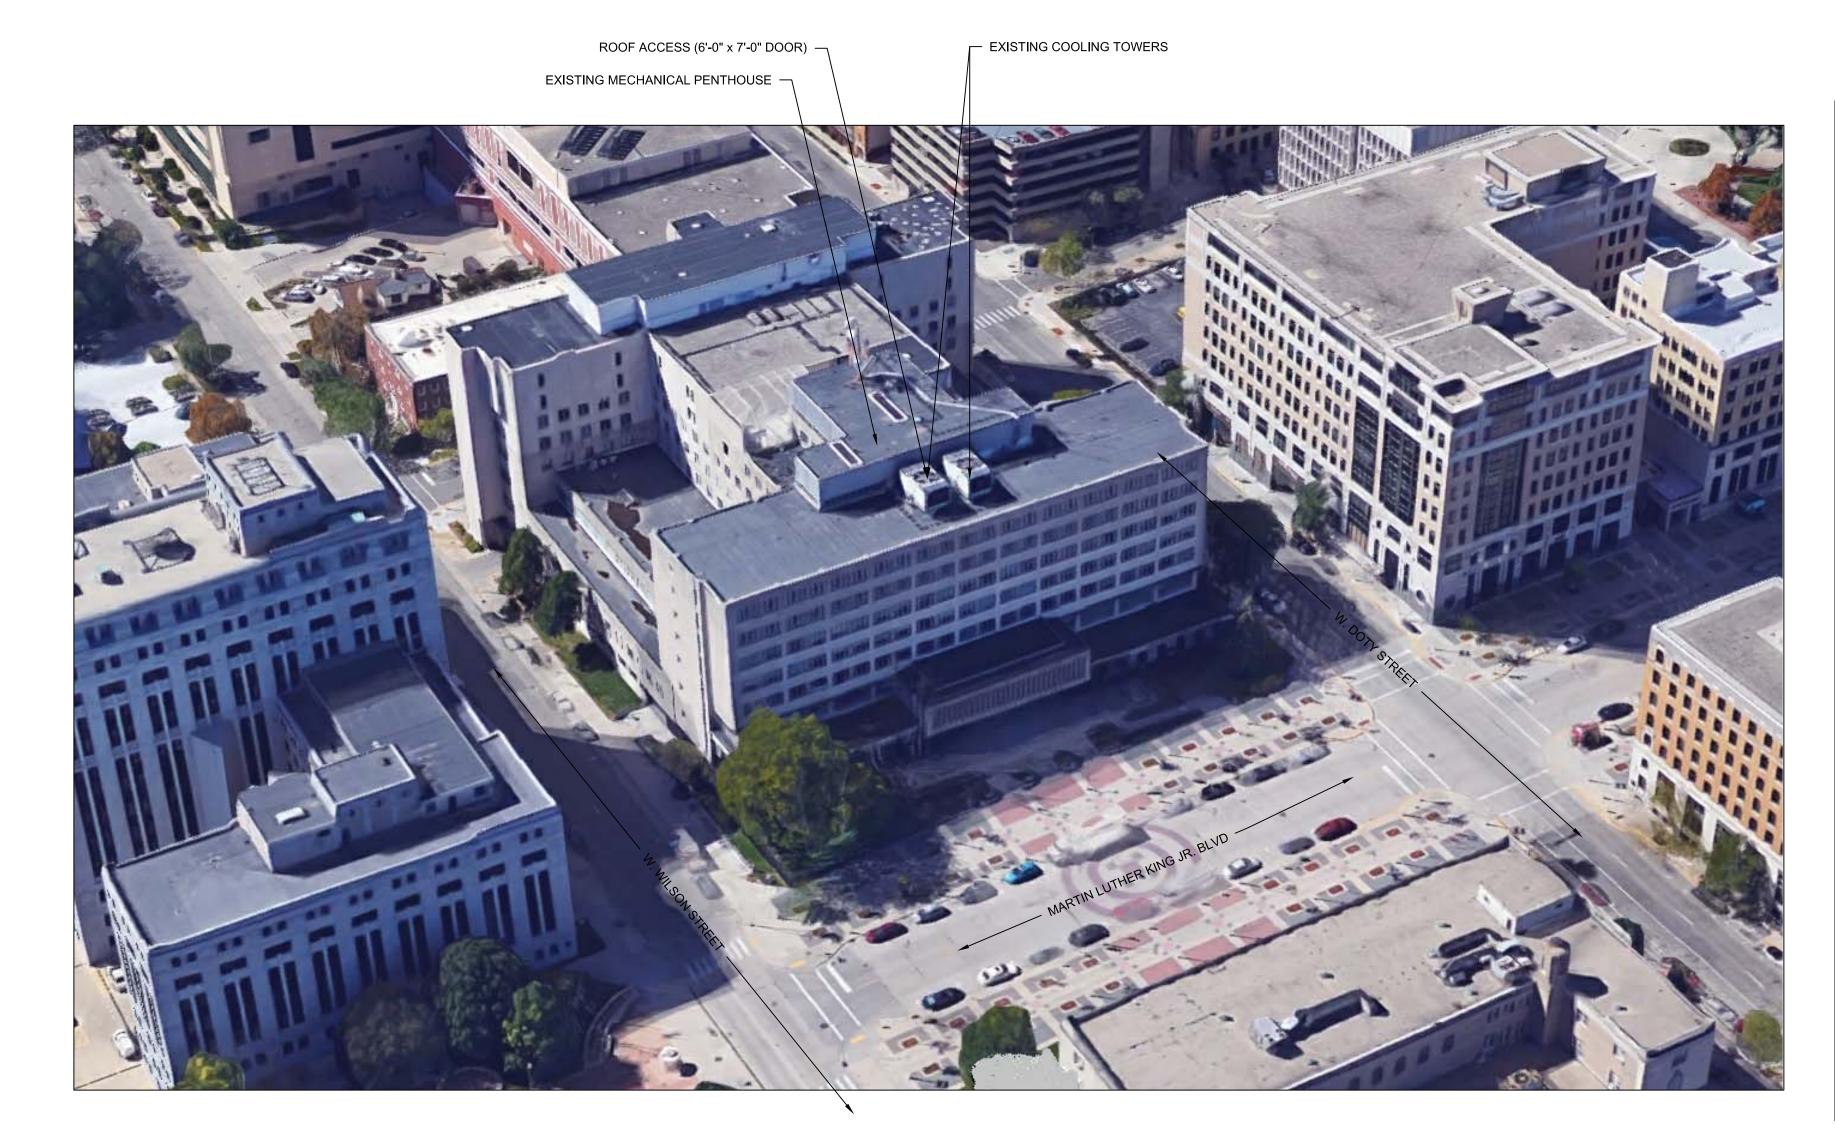



3 EXISTING OVERALL PERSPECTIVE PHOTO ME100 SCALE: N.T.S.

2 EXISTING OVERALL BUILDING PHOTO
ME100 SCALE: N.T.S.



ENGINEERING, INC.
5525 NOBEL DRIVE
SUITE 110
MADISON, WI 53711
PH: 608.277.1728 FAX: 608.271.7046

CONSULTANTS

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PHASE: BIDDING


PROJECT

DANE COUNTY
CITY COUNTY
BUILDING

COOLING TOWER
REPLACEMENT PROJECT

OVERALL EXISTING SITE PHOTOS

ME100

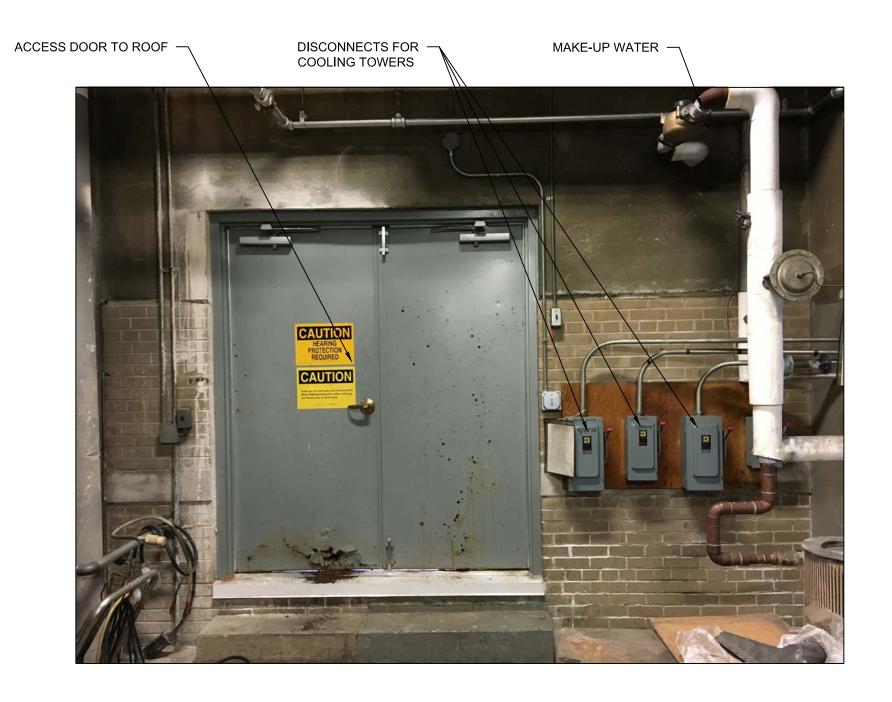



MECHANICAL PENTHOUSE ----

CONDENSER WATER RETURN -



PHOTO - WEST SIDE OF COOLING TOWER

ME101 SCALE: N.T.S.




1 PHOTO - COOLING TOWER - LOOKING WEST
ME101 SCALE: N.T.S.




5 PHOTO - CONDENSER WATER PIPING AT PENTHOUSE
ME101 SCALE: N.T.S.

PHOTO - COOLING TOWER - LOOKING WEST
ME101 SCALE: N.T.S.

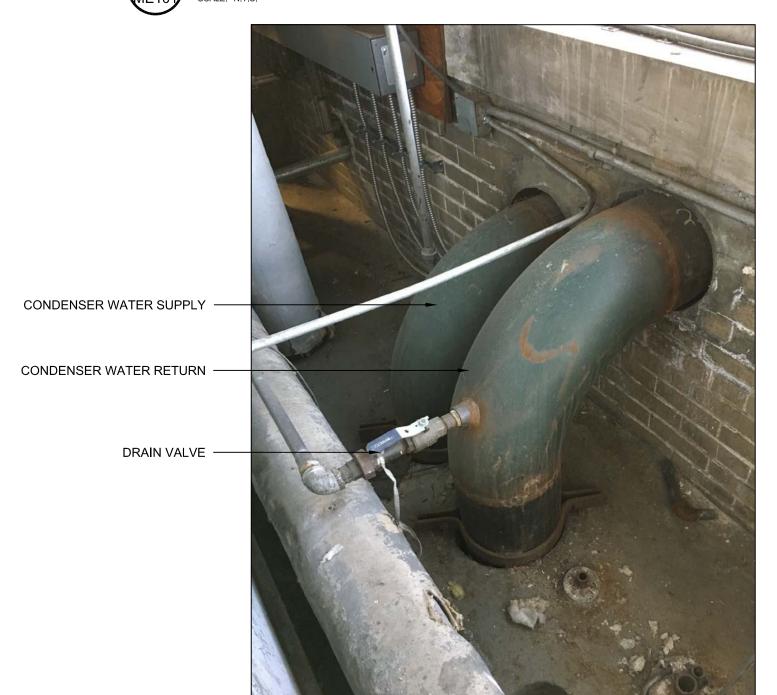

6 PHOTO - CONDENSER WATER PIPING INSIDE PENTHOUSE
ME101 SCALE: N.T.S.

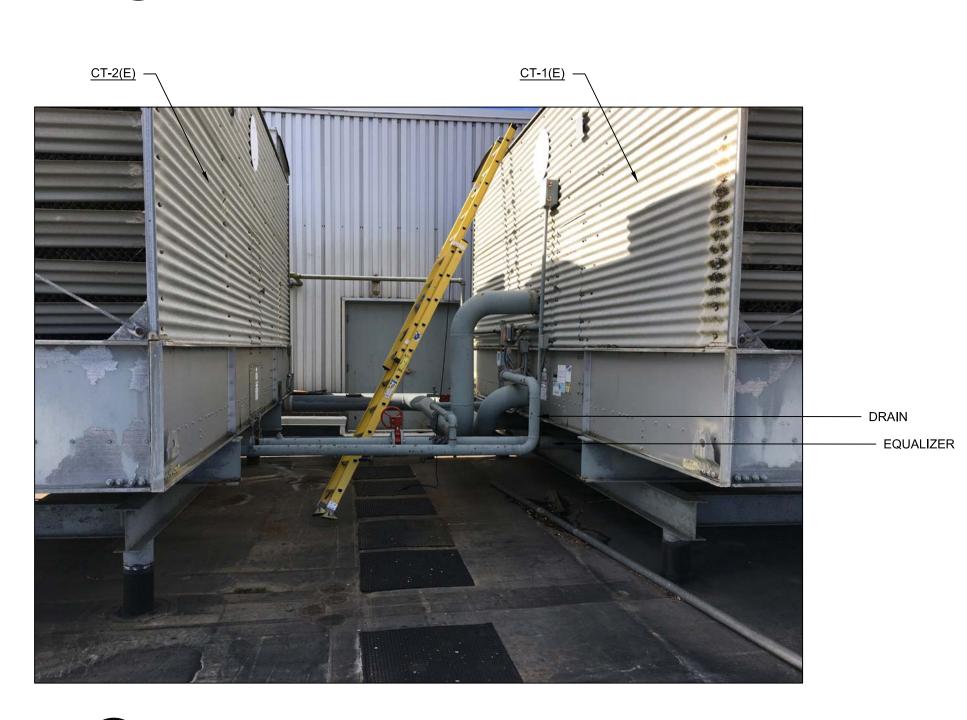

3 PHOTO - LOOKING BETWEEN COOLING TOWERS

ME101 SCALE: N.T.S.



CONSULTANTS


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PROJECT	
DANE COUNTY CITY COUNTY BUILDING	

COOLING TOWER

EXISTING COOLING

TOWER PHOTOS

REPLACEMENT PROJECT

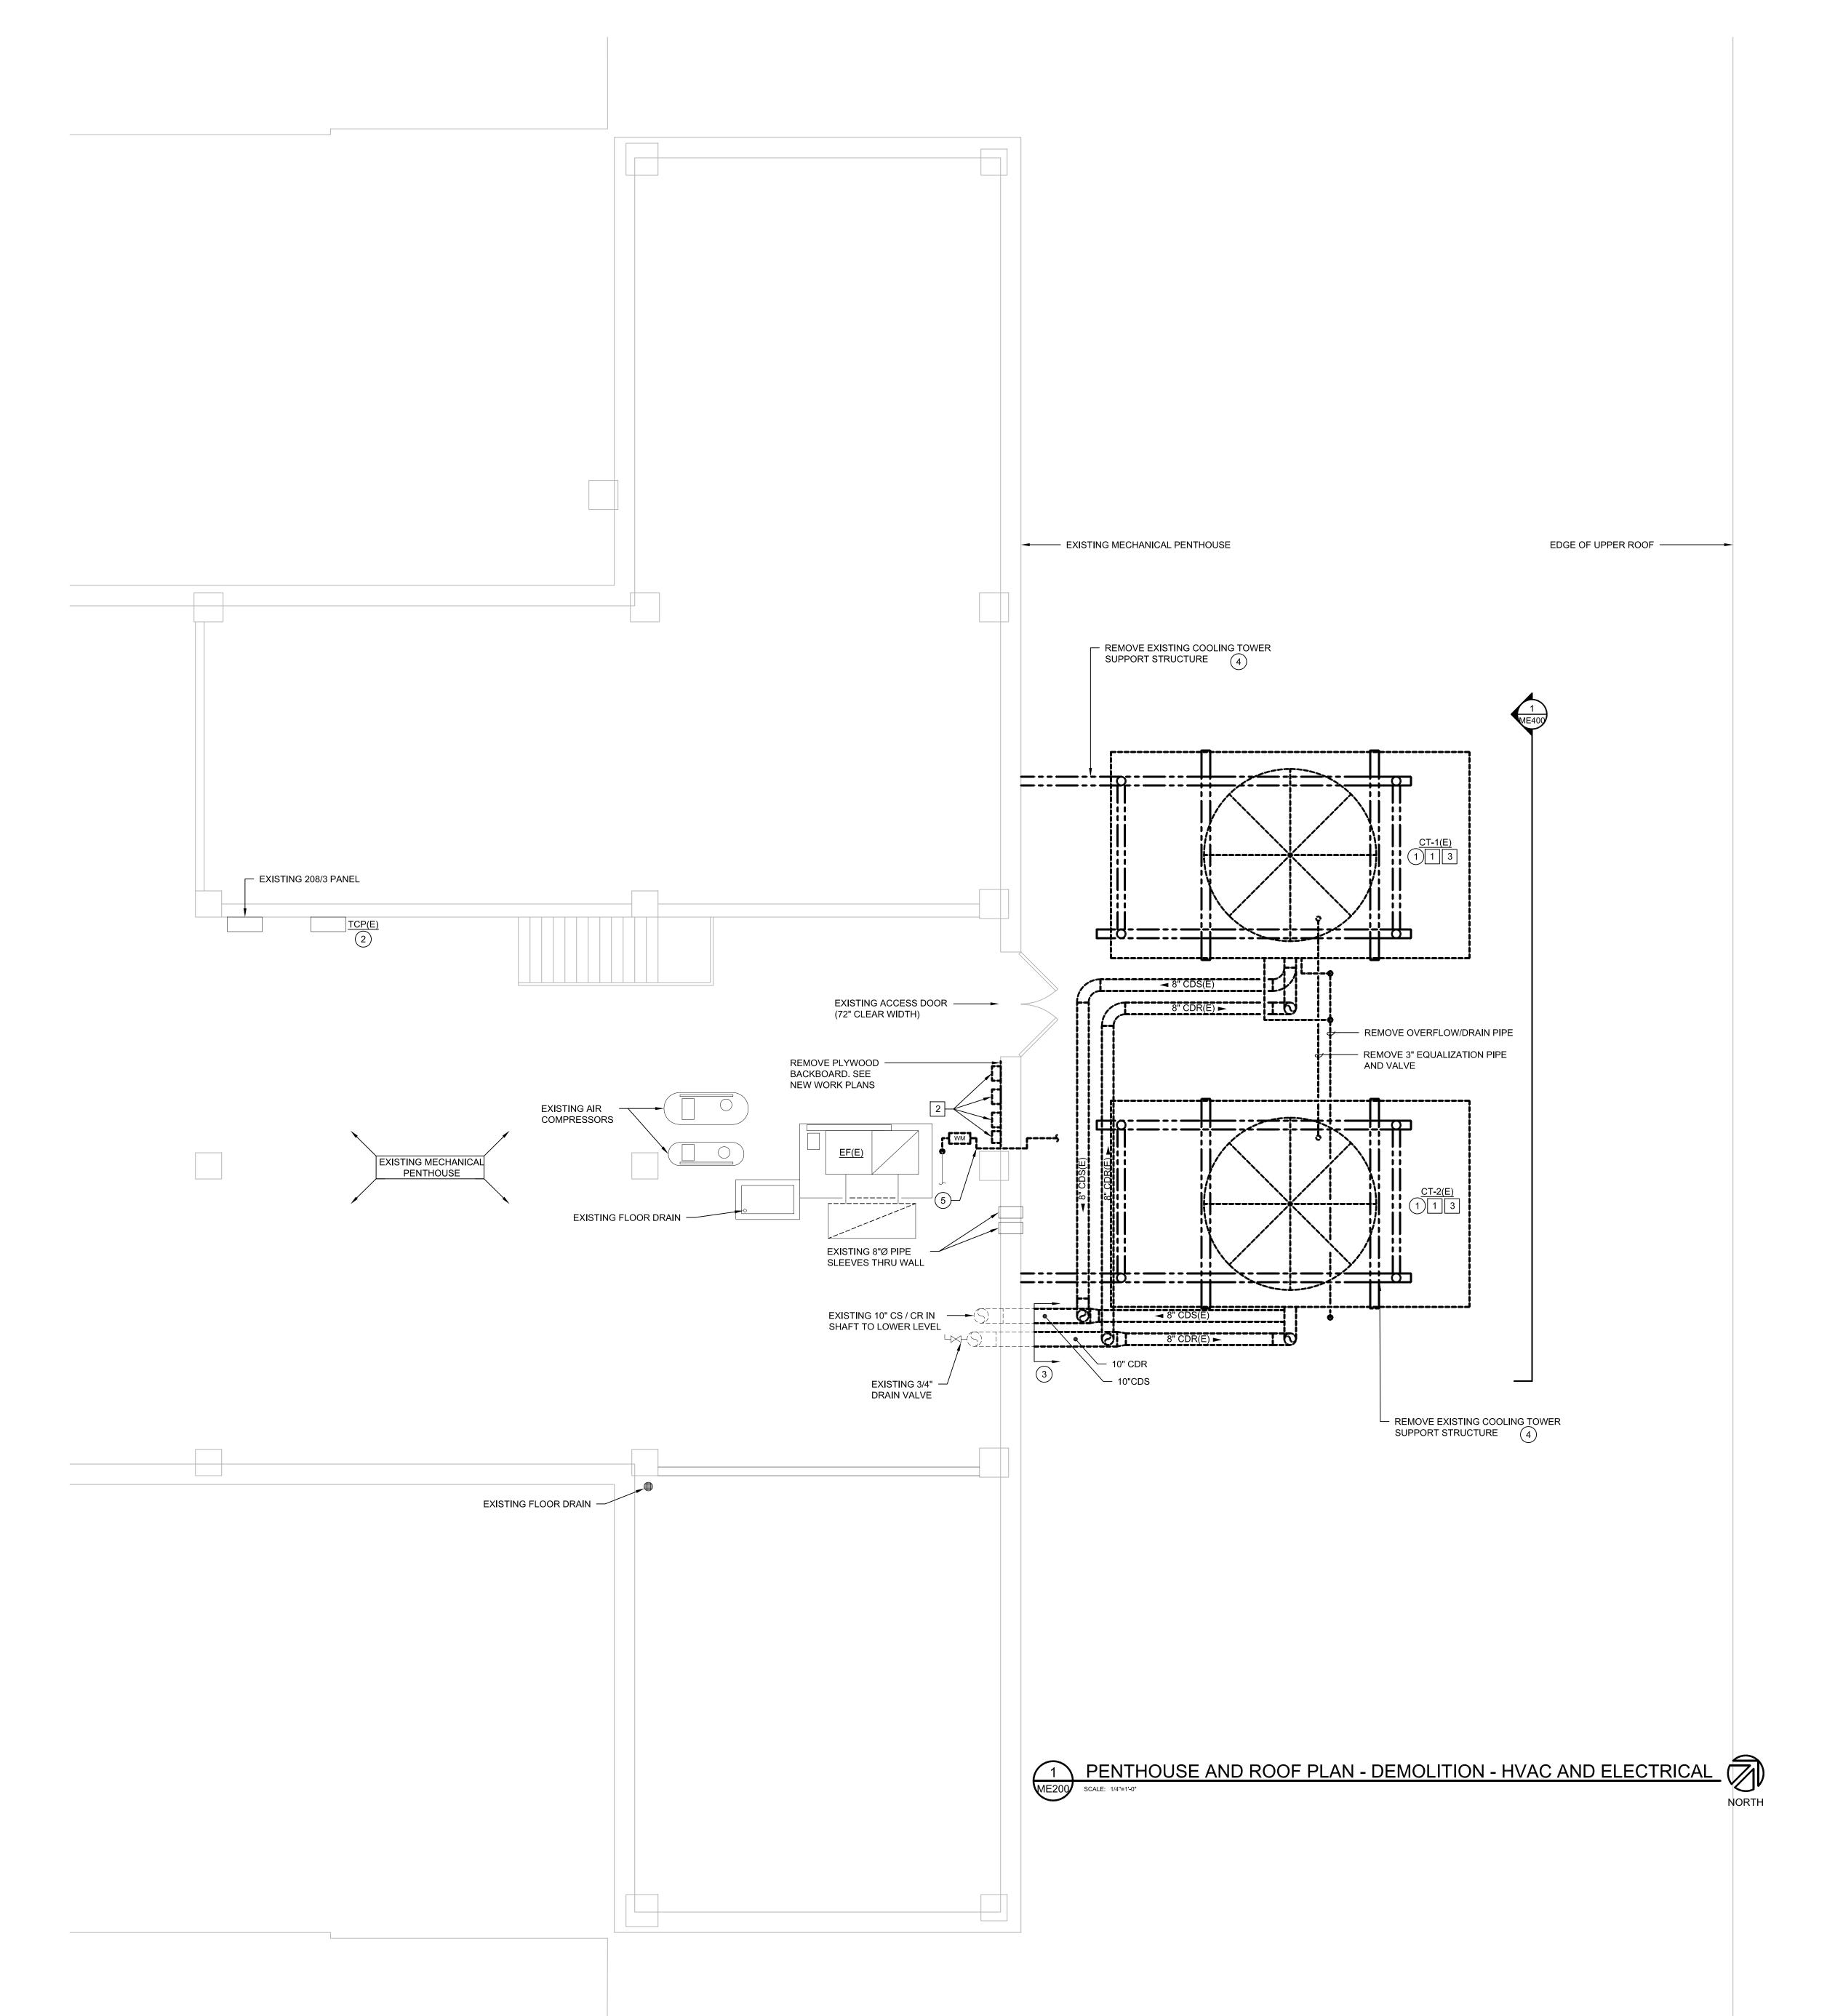

GENERAL NOTES:

- CONTRACTOR SHALL FIELD VERIFY ALL EXISTING CONDITIONS BEFORE COMMENCING WORK. REPORT ANY DISCREPANCIES TO THE A/E IMMEDIATELY.
- CONTRACTOR RESPONSIBLE FOR ALL ASPECTS AND LOGISTICS OF REMOVAL OF EXISTING COOLING TOWERS, STRUCTURE AND PIPING FROM ROOF AND INSTALLATION OF NEW STRUCTURE, COOLING TOWERS AND PIPING AT SAME LOCATION INCLUDING CRANING, RIGGING, STREET CLOSURE, PERMITS, ETC.
- ALL ASPECTS OF COOLING TOWER REMOVAL AND REINSTALLATION SHALL BE FULLY COORDINATED WITH CITY COUNTY BUILDING FACILITY ENGINEERING, DANE COUNTY PUBLIC WORKS, CITY OF MADISON PUBLIC WORKS AND CITY OF MADISON POLICE DEPARTMENT.
- 4. COORDINATE ALL INTERRUPTIONS WITH OWNERS AND FACILITY ENGINEERING PRIOR TO STARTING WORK.
- 5. ALL DUCTWORK, PIPING, CONDUIT, EQUIPMENT, ETC. NOTED FOR DEMOLITION SHALL BE REMOVED COMPLETE.

7. ALL ELECTRICAL WORK SHALL COMPLY WITH THE NATIONAL ELECTRICAL CODE AND ALL LOCAL AND STATE CODES.

- 6. ALL EXISTING ABANDONED CONDUIT, PIPING, EQUIPMENT, ETC. SHALL BE REMOVED COMPLETE.
- 8. ALL CONDUCTORS SHALL BE COPPER.
- 9. ALL WIRING SHALL BE ROUTED IN EMT CONDUIT AT A MINIMUM.
- 10. ALL EQUIPMENT SHALL BE LABELED TO MATCH THE BUILDING STANDARDS.
- 11. ALL ELECTRICAL BOXES SHALL BE LABELED WITH THE PANEL AND CIRCUIT NUMBER TO MATCH THE BUILDING STANDARDS.

 KEYED NOTES (HVAC):
- 1) REMOVE EXISTING COOLING TOWER COMPLETE. INCLUDING:
- REMOVE EXISTING COOLING TOWER.
 REMOVE ALL EXISTING CONDENSER WATER PIPING BACK TO POINT SHOWN. REMOVE ALL EXISTING VALVES. REMOVE ALL PIPING AND VALVES FROM ROOF.
- REMOVE ALL MAKE-UP WATER PIPING BACK TO POINT SHOWN.
- REMOVE ALL DRAIN PIPINGREMOVE ALL EQUALIZATION PIPING BETWEEN TOWERS.
- 2 LOCATION OF EXISTING DDC CONTROL PANEL TO REMAIN.
- REMOVE ALL EXISTING 8" AND 10" CONDENSER WATER SUPPLY AND RETURN PIPING ON ROOF FROM THIS POINT. SEE NEW WORK PLAN FOR CONNECTION OF NEW PIPING TO EXISTING PIPING.
- 4 REMOVE EXISTING COOLING TOWER SUPPORT STRUCTURE. STRUCTURE SHALL BE REPLACED. SEE DETAILS FOR ADDITIONAL INFORMATION.
- 5 REMOVE MAKE-UP WATER PIPING FROM THIS POINT TO EACH EXISTING COOLING TOWER. EXISTING MAKE-UP WATER BACKFLOW PREVENTER AND METER TO BE RELOCATED BY THE COUNTY.

 KEYED NOTES (ELECTRICAL):
- DISCONNECT POWER TO EXISTING COOLING TOWER (20HP, 460/3). REMOVE WIRE AND CONDUIT FROM COOLING TOWER BACK TO DISCONNECT IN PENTHOUSE. SEE NEW WORK PLAN FOR LOCATION OF NEW

VARIABLE FREQUENCY DRIVES ASSOCIATED WITH NEW COOLING TOWERS.

- 2 REMOVE EXISTING DISCONNECTS ASSOCIATED WITH EXISTING COOLING TOWERS BEING REMOVED. REMOVE CONDUIT AND FEEDERS AS REQUIRED. SEE NEW WORK PLAN FOR NEW CONNECTIONS.
- DISCONNECT 120V /1P POWER TO COOLING TOWER WATER LEVEL / WATER FILL CONTROLLER. SEE NEW PLAN FOR CONNECTION TO NEW COOLING TOWER WATER LEVEL / WATER FILL CONTROLLER.



CONSULTANTS

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ME200

PROJECT

DANE COUNTY

CITY COUNTY

COOLING TOWER


REPLACEMENT PROJECT

PENTHOUSE AND ROOF

PLAN - DEMOLITION -

HVAC & ELECTRICAL

BUILDING

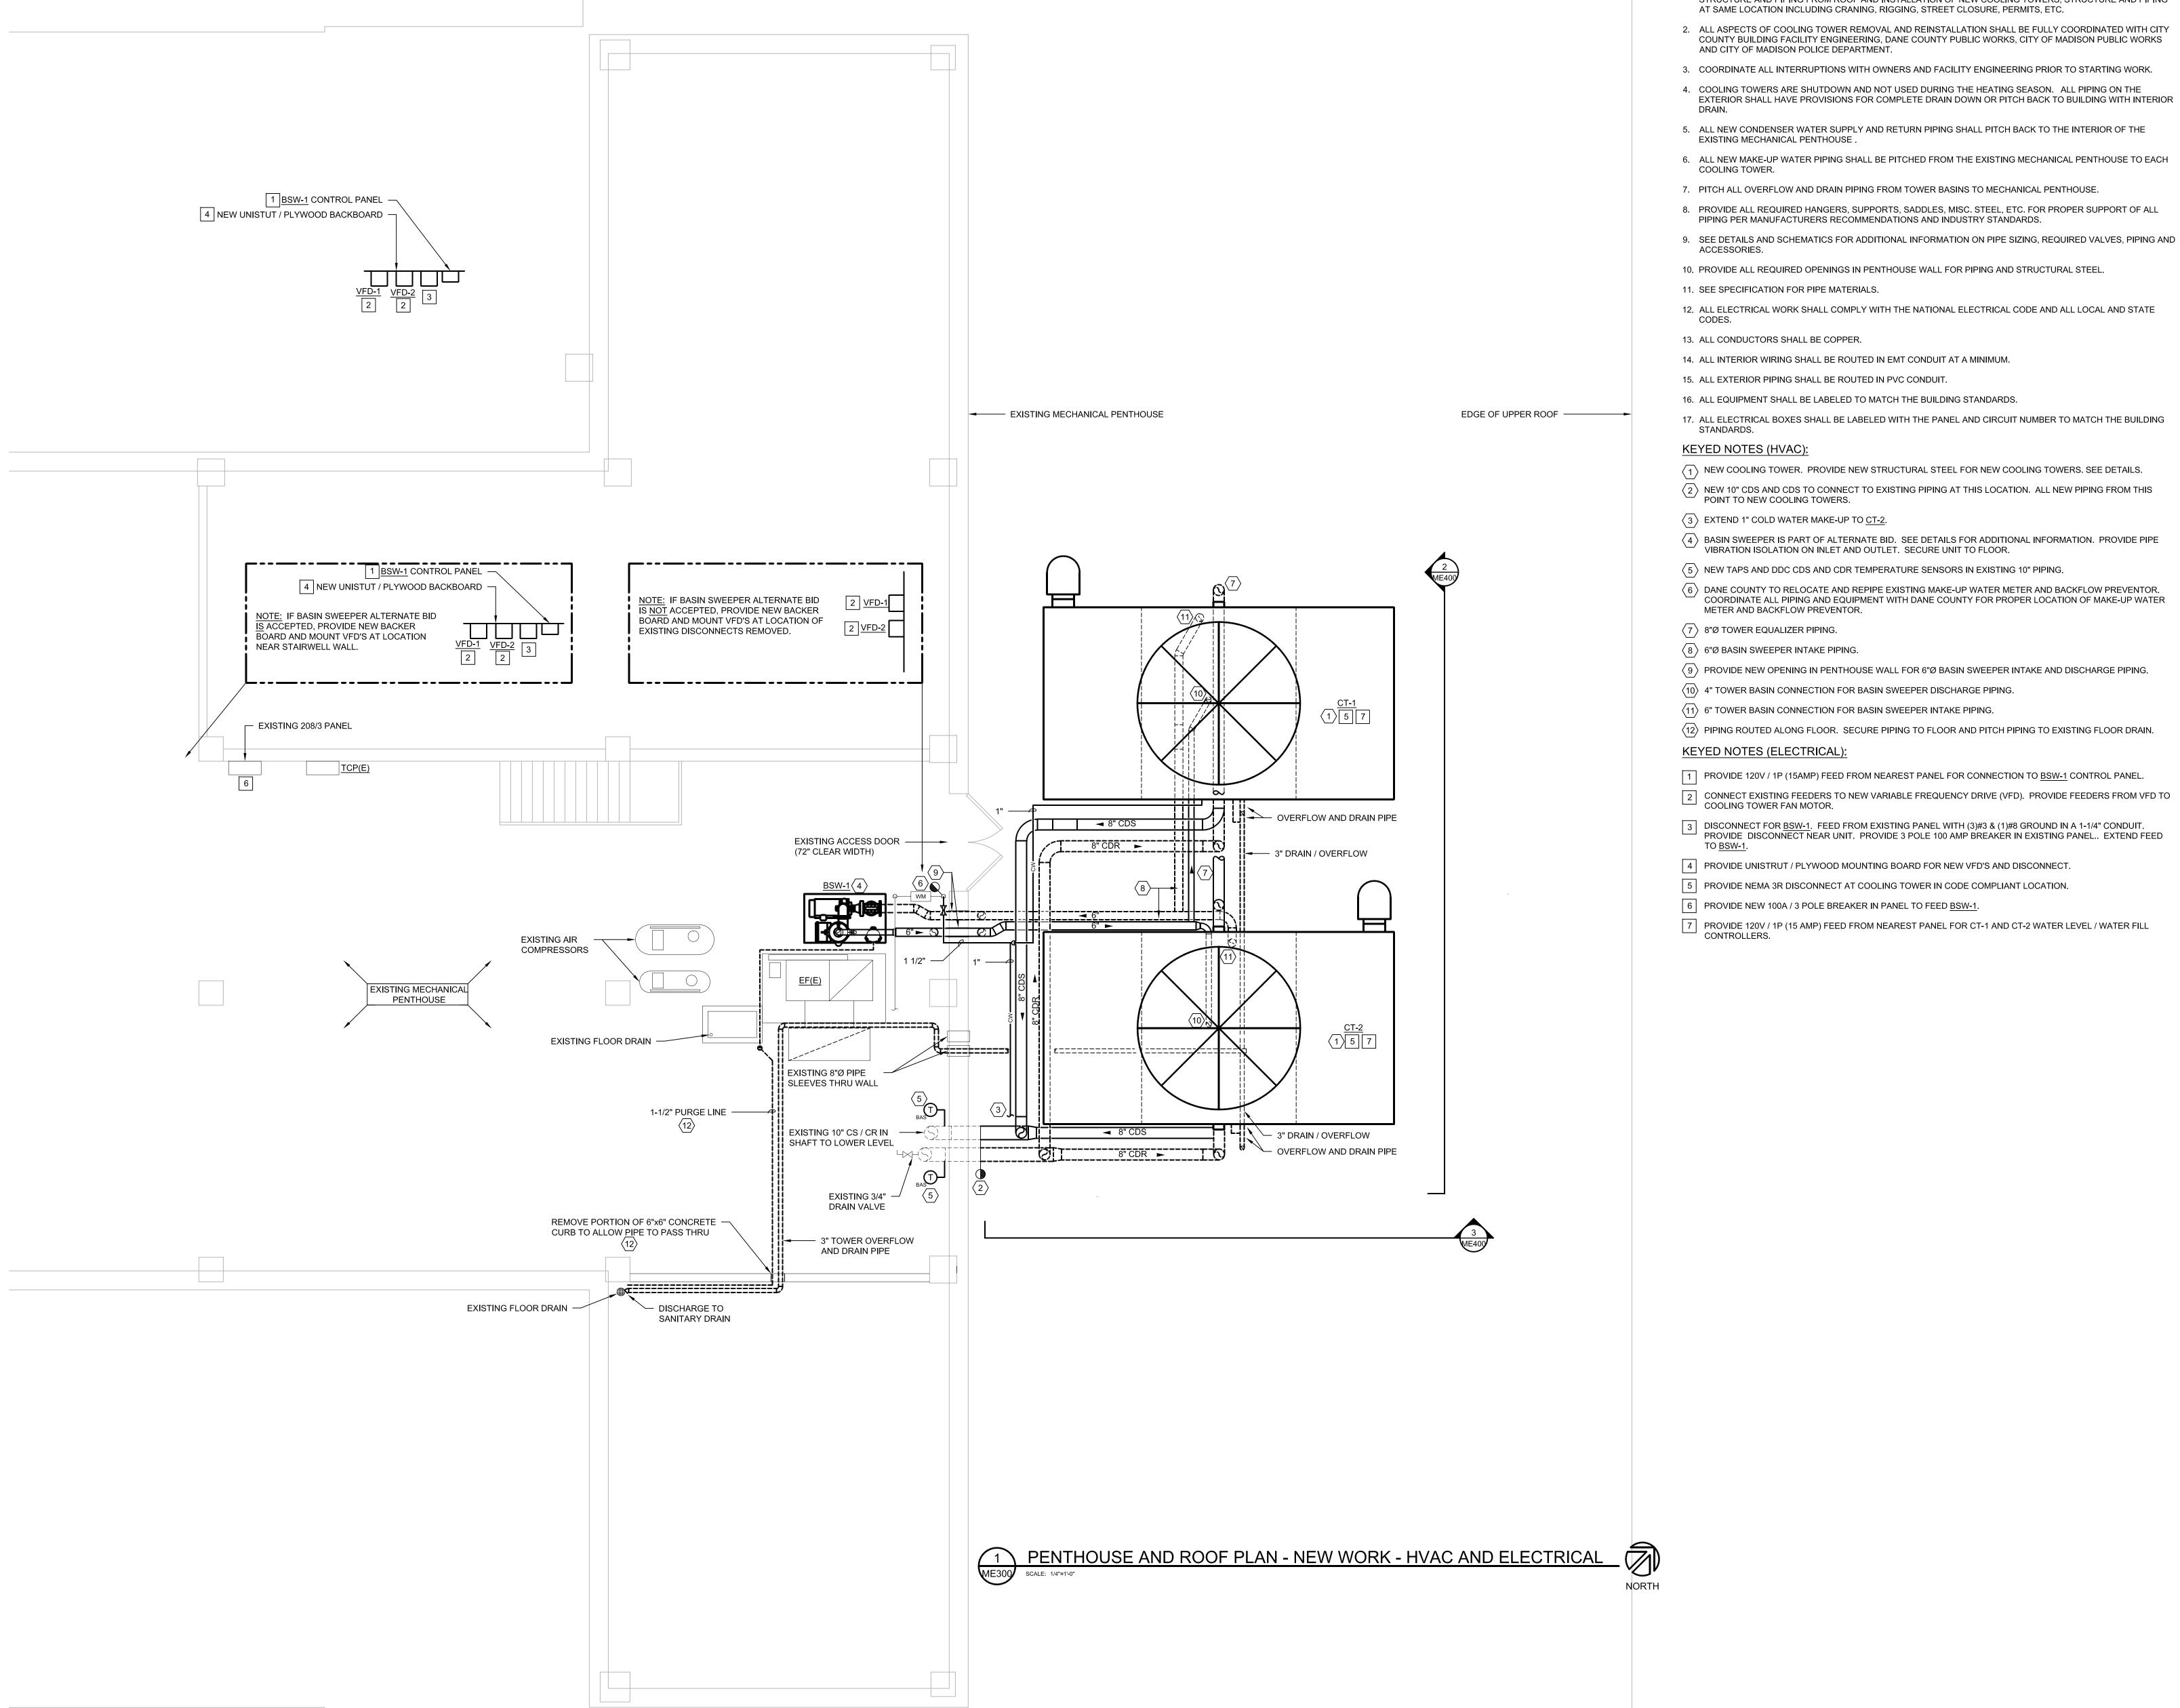

GENERAL NOTES:

- 1. CONTRACTOR RESPONSIBLE FOR ALL ASPECTS AND LOGISTICS OF REMOVAL OF EXISTING COOLING TOWERS, STRUCTURE AND PIPING FROM ROOF AND INSTALLATION OF NEW COOLING TOWERS, STRUCTURE AND PIPING AT SAME LOCATION INCLUDING CRANING, RIGGING, STREET CLOSURE, PERMITS, ETC.
- 2. ALL ASPECTS OF COOLING TOWER REMOVAL AND REINSTALLATION SHALL BE FULLY COORDINATED WITH CITY COUNTY BUILDING FACILITY ENGINEERING, DANE COUNTY PUBLIC WORKS, CITY OF MADISON PUBLIC WORKS AND CITY OF MADISON POLICE DEPARTMENT.
- 3. COORDINATE ALL INTERRUPTIONS WITH OWNERS AND FACILITY ENGINEERING PRIOR TO STARTING WORK.
- EXTERIOR SHALL HAVE PROVISIONS FOR COMPLETE DRAIN DOWN OR PITCH BACK TO BUILDING WITH INTERIOR
- 5. ALL NEW CONDENSER WATER SUPPLY AND RETURN PIPING SHALL PITCH BACK TO THE INTERIOR OF THE EXISTING MECHANICAL PENTHOUSE.
- 6. ALL NEW MAKE-UP WATER PIPING SHALL BE PITCHED FROM THE EXISTING MECHANICAL PENTHOUSE TO EACH COOLING TOWER.
- 7. PITCH ALL OVERFLOW AND DRAIN PIPING FROM TOWER BASINS TO MECHANICAL PENTHOUSE.
- 8. PROVIDE ALL REQUIRED HANGERS, SUPPORTS, SADDLES, MISC. STEEL, ETC. FOR PROPER SUPPORT OF ALL PIPING PER MANUFACTURERS RECOMMENDATIONS AND INDUSTRY STANDARDS.
- 10. PROVIDE ALL REQUIRED OPENINGS IN PENTHOUSE WALL FOR PIPING AND STRUCTURAL STEEL.
- 11. SEE SPECIFICATION FOR PIPE MATERIALS.
- 12. ALL ELECTRICAL WORK SHALL COMPLY WITH THE NATIONAL ELECTRICAL CODE AND ALL LOCAL AND STATE
- 13. ALL CONDUCTORS SHALL BE COPPER.
- 14. ALL INTERIOR WIRING SHALL BE ROUTED IN EMT CONDUIT AT A MINIMUM.
- 15. ALL EXTERIOR PIPING SHALL BE ROUTED IN PVC CONDUIT.
- 16. ALL EQUIPMENT SHALL BE LABELED TO MATCH THE BUILDING STANDARDS.
- 17. ALL ELECTRICAL BOXES SHALL BE LABELED WITH THE PANEL AND CIRCUIT NUMBER TO MATCH THE BUILDING STANDARDS.

KEYED NOTES (HVAC):

- $\langle 1 \rangle$ NEW COOLING TOWER. PROVIDE NEW STRUCTURAL STEEL FOR NEW COOLING TOWERS. SEE DETAILS.
- NEW 10" CDS AND CDS TO CONNECT TO EXISTING PIPING AT THIS LOCATION. ALL NEW PIPING FROM THIS POINT TO NEW COOLING TOWERS.
- $\langle 3 \rangle$ EXTEND 1" COLD WATER MAKE-UP TO CT-2.
- BASIN SWEEPER IS PART OF ALTERNATE BID. SEE DETAILS FOR ADDITIONAL INFORMATION. PROVIDE PIPE VIBRATION ISOLATION ON INLET AND OUTLET. SECURE UNIT TO FLOOR.
- $\langle 5 \rangle$ NEW TAPS AND DDC CDS AND CDR TEMPERATURE SENSORS IN EXISTING 10" PIPING.
- $\langle 6 \rangle$ DANE COUNTY TO RELOCATE AND REPIPE EXISTING MAKE-UP WATER METER AND BACKFLOW PREVENTOR. COORDINATE ALL PIPING AND EQUIPMENT WITH DANE COUNTY FOR PROPER LOCATION OF MAKE-UP WATER METER AND BACKFLOW PREVENTOR.
- $\langle 7 \rangle$ 8"Ø TOWER EQUALIZER PIPING.
- $\langle 8 \rangle$ 6"Ø BASIN SWEEPER INTAKE PIPING.
- $\langle 9 \rangle$ PROVIDE NEW OPENING IN PENTHOUSE WALL FOR 6"Ø BASIN SWEEPER INTAKE AND DISCHARGE PIPING.
- (10) 4" TOWER BASIN CONNECTION FOR BASIN SWEEPER DISCHARGE PIPING.
- (11) 6" TOWER BASIN CONNECTION FOR BASIN SWEEPER INTAKE PIPING.
- (12) PIPING ROUTED ALONG FLOOR. SECURE PIPING TO FLOOR AND PITCH PIPING TO EXISTING FLOOR DRAIN. KEYED NOTES (ELECTRICAL):

- 1 PROVIDE 120V / 1P (15AMP) FEED FROM NEAREST PANEL FOR CONNECTION TO <u>BSW-1</u> CONTROL PANEL.
- 2 CONNECT EXISTING FEEDERS TO NEW VARIABLE FREQUENCY DRIVE (VFD). PROVIDE FEEDERS FROM VFD TO COOLING TOWER FAN MOTOR.
- DISCONNECT FOR <u>BSW-1</u>. FEED FROM EXISTING PANEL WITH (3)#3 & (1)#8 GROUND IN A 1-1/4" CONDUIT. PROVIDE DISCONNECT NEAR UNIT. PROVIDE 3 POLE 100 AMP BREAKER IN EXISTING PANEL.. EXTEND FEED
- 4 PROVIDE UNISTRUT / PLYWOOD MOUNTING BOARD FOR NEW VFD'S AND DISCONNECT.
- 5 PROVIDE NEMA 3R DISCONNECT AT COOLING TOWER IN CODE COMPLIANT LOCATION.
- 6 PROVIDE NEW 100A / 3 POLE BREAKER IN PANEL TO FEED BSW-1.
- 7 PROVIDE 120V / 1P (15 AMP) FEED FROM NEAREST PANEL FOR CT-1 AND CT-2 WATER LEVEL / WATER FILL CONTROLLERS.

ENGINEERING, INC. 5525 NOBEL DRIVE SUITE 110 MADISON, WI 53711 PH: 608.277.1728 FAX: 608.271.7046

CONSULTANTS

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PROJECT#: DRAWN: CHECKED:

11/15/2016 DATE: PHASE: BIDDING

PROJECT

DANE COUNTY CITY COUNTY BUILDING

> COOLING TOWER REPLACEMENT PROJECT

PENTHOUSE AND ROOF PLAN - NEW WORK -**HVAC & ELECTRICAL**

ME300


CT-2 (E)


CT-1 (E)

EXISTING STRUCTURE TO BE REMOVED. SEE MA00 AND M800 FOR ADDITIONAL INFORMATION

ROOF

1 ELEVATION - DEMOLITION
ME400 SCALE: 1/4"=1'-0"

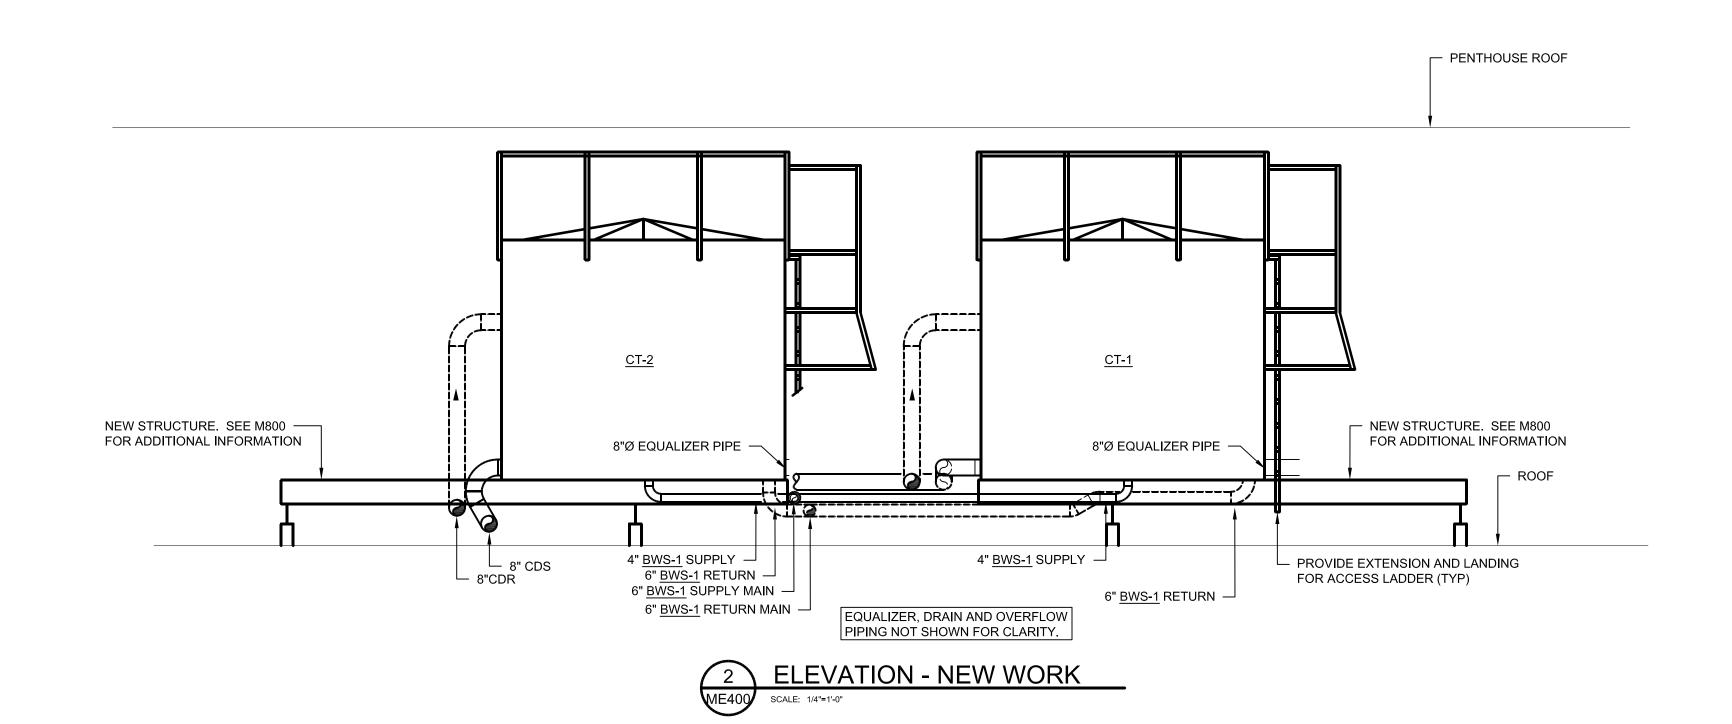

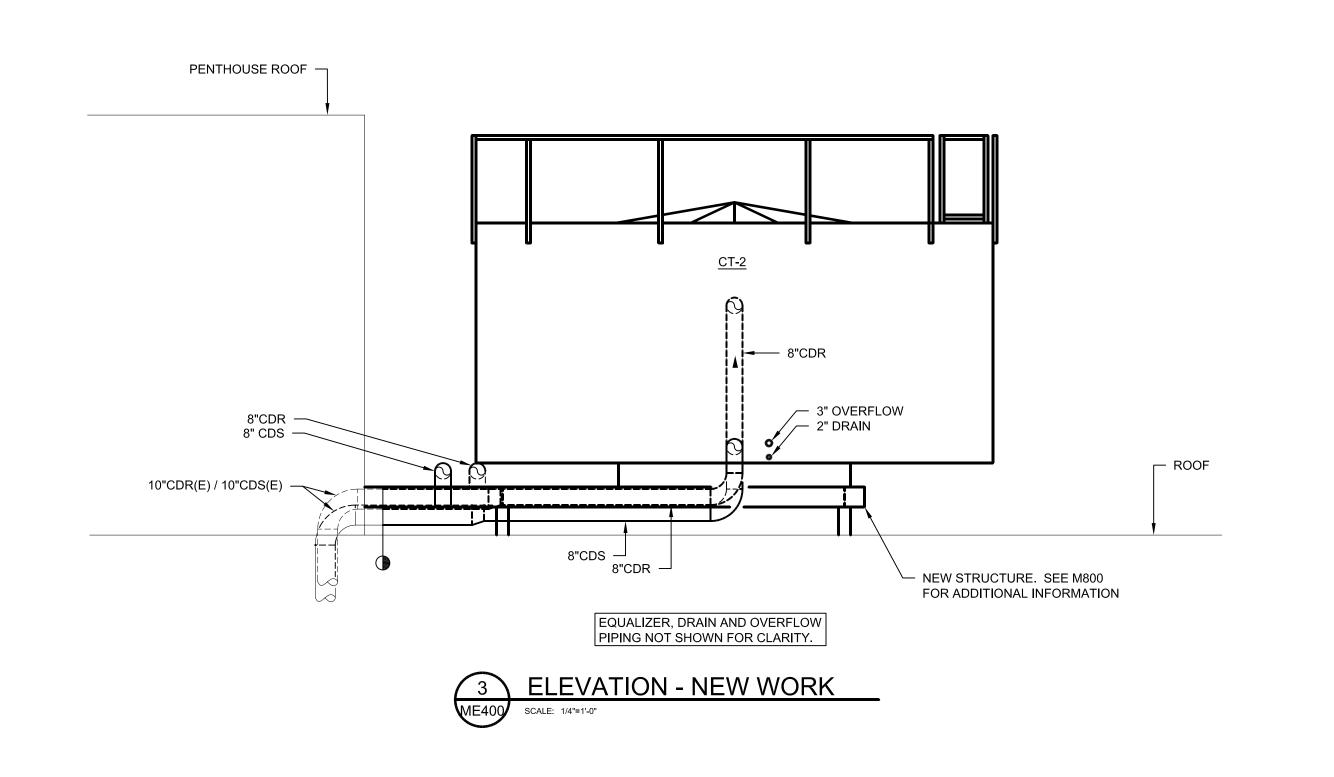



CONSULTANTS

PENTHOUSE ROOF

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REVISIONS / AD	DENDA
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PROJECT #:	16.0206
DRAWN :	AGM
CHECKED:	TDM
DATE:	11/15/2016
PHASE :	BIDDING
PROJECT	

ME400

DANE COUNTY

CITY COUNTY

COOLING TOWER

REPLACEMENT PROJECT

ELEVATIONS AND DETAILS

HVAC AND STRUCTURAL

BUILDING

BASIN S SCHE		
UNIT NO.	BSW-1	
SERVICE	CT-1 & CT-2	
MANUFACTURER	LAKOS	
MODEL NO.	TCX-0600-ABV	
LOCATION	ROOF	
FLOW (GPM)	600	
HP	20	
VOLTS	208	
PHASE	3	
SHIPPING WEIGHT (LBS)	1,600	
OPERATING WEIGHT (LBS)	-	
REMARKS	(1)(2)	

KEYED NOTES:


- SYSTEM SHALL HAVE CAPACITY FOR SWEEPING BOTH TOWERS SIMULTANEOUSLY.
- 2 BASIN SWEEPING SYSTEM BY ALTERNATE BID.


	ARIABLE FREQUENCY DRIVE SCHEDULE			
UNIT NO.	VFD-1	VFD-2		
SERVICE	CT-1	CT-2		
MANUFACTURER	ABB	ABB		
MODEL NO.	ACH550	ACH550		
LOCATION	PENTHOUSE	PENTHOUSE		
HP	15	15		
VOLTS	480	480		
PHASE	3	3		
REMARKS				

UNIT NO.	CT-1	CT-2	
SERVICE	EXISTING CHILLER	EXISTING CHILLER	
MANUFACTURER	BAC	BAC	
MODEL NO.	3000	3000	
TYPE	INDUCED DRAFT	INDUCED DRAFT	
AIRFLOW PATTERN	CROSS FLOW	CROSS FLOW	
TOTAL CAPACITY (MBH)	-	-	
AMBIENT TEMP. DB/WB	95 / 78	95 / 78	
CONDENSER WATER (EWT °F)	95.0	95.0	
CONDENSER WATER (LWT °F)	85.0	85.0	
CONDENSER WATER FLOW (GPM)	1,150	1,150	
CONNECTION SIZES			
CONDESER WATER INLET (IN)	8	8	
CONDESER WATER OUTLET (IN)	8	8	
EQUALIZER PIPE (IN)	8	8	
DRAIN PIPE (IN)	2	2	
OVERFLOW (IN)	3	3	
BASIN SWEEPER OUTLET (IN)	6	6	
BASIN SWEEPER INLET (IN)	4	4	
VIBRATION ISOLATOR TYPE	-	-	
VIBRATION TYPE DEFLECTION	-	-	
MOTOR HP	15.0	15.0	
MOTOR VFD	YES	YES	
VOLTAGE	480	480	
PHASE	3	3	
SHIPPING WEIGHT (LBS)	12,000	12,000	
OPERATING WEIGHT (LBS)	24,000	24,000	
REMARKS	$\langle 1 \rangle \langle 2 \rangle$	$\langle 1 \rangle \langle 2 \rangle$	

KEYED NOTE

- PROVIDE COOLING TOWER WITH THE FOLLOWING ACCESSORIES (ALSO SEE SPECIFICATION):
 STAINLESS STEEL ALL WELDED UPPER AND LOWER WATER BASINS.
 ACCESS LADDER (WITH SAFETY CAGE), PERIMETER HANDRAILS AND SAFETY GATE.
 INTERNAL WALKWAY
 BASIN TO INCLUDE FACTORY PROVISION FOR BASIN SWEEPING (ALTERNATE BID)
- (2) CONTRACTOR TO CONFIRM SHIPPING WEIGHT (AND HOIST WEIGHT) WITH COOLING TOWER MANUFACTURER PRIOR TO SECURING OR SCHEDULING CRANE / RIGGING OF UNIT.

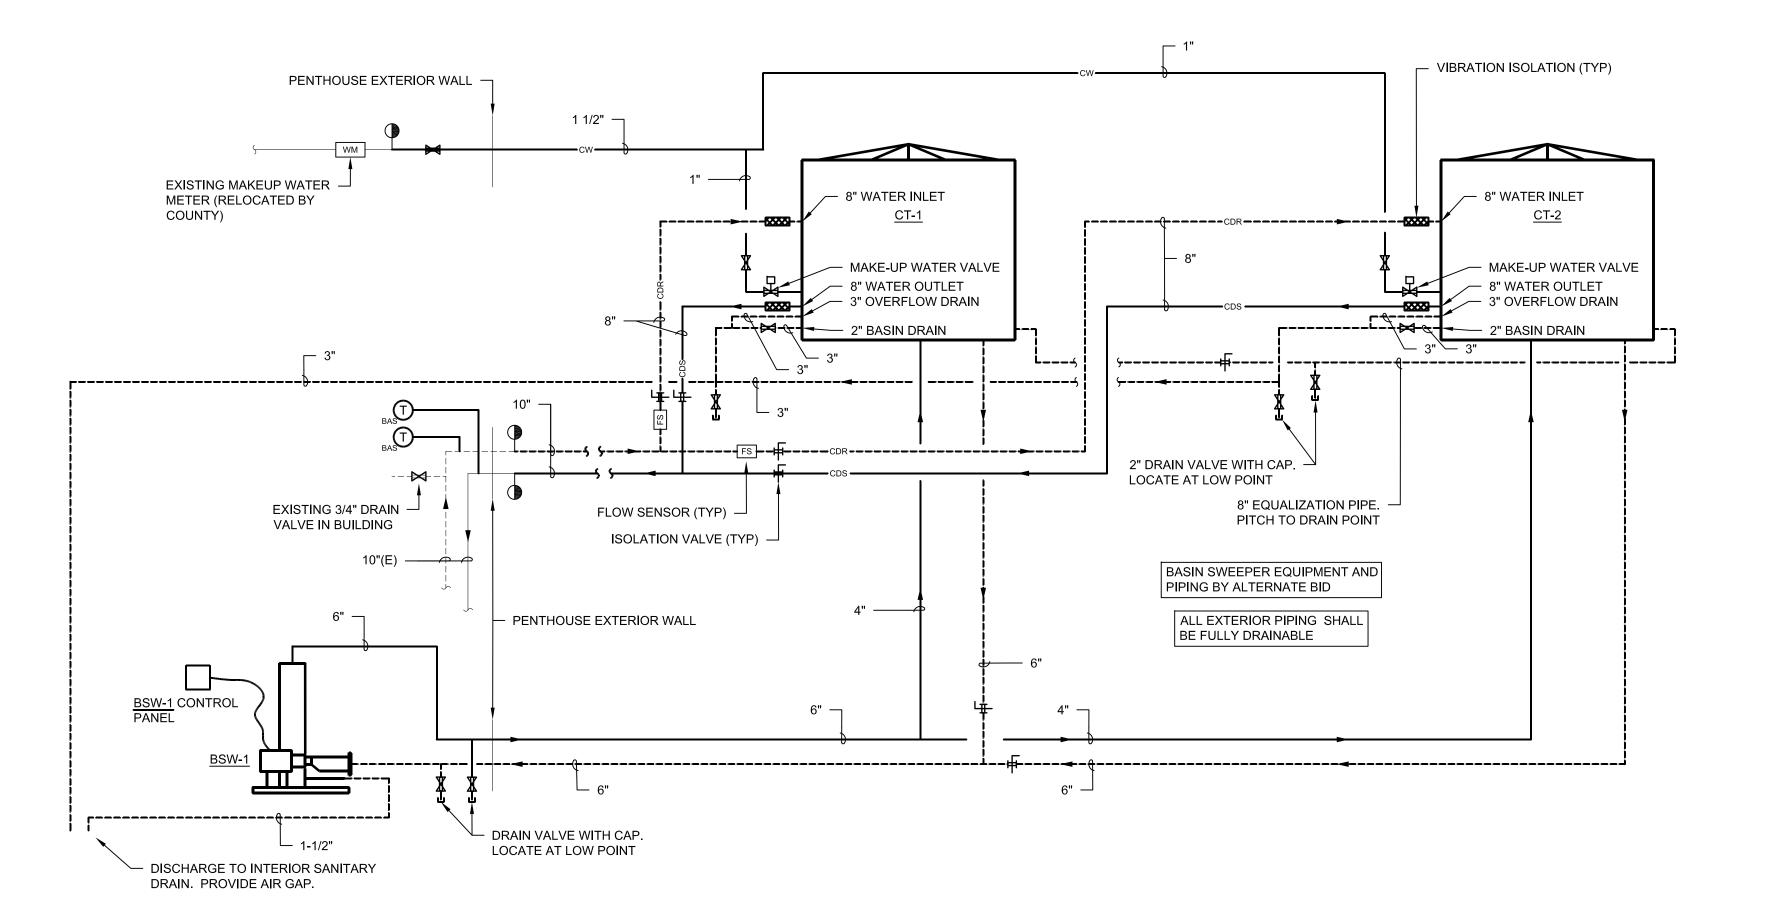

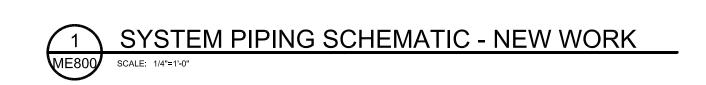



CONSULTANTS

SSUED					
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REVISIONS / ADDENDA

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- PROJECT #: 16.020

DRAWN: AGM

CHECKED: TDM

DATE: 11/15/2016

PHASE: BIDDING

DANE COUNTY
CITY COUNTY
BUILDING

PROJECT

COOLING TOWER
REPLACEMENT PROJECT

DETAILS AND SCHEDULES
- HVAC & ELECTRICAL

ME800