




DANE COUNTY NO. 2 (RODEFELD) LANDFILL

PHASE 10 - CELL 1 LINER CONSTRUCTION

PREPARED FOR: **DANE COUNTY DEPARTMENT OF PUBLIC WORKS
SOLID WASTE DIVISION
DANE COUNTY, WISCONSIN**

PREPARED BY: **TRC ENVIRONMENTAL CORPORATION
MADISON, WISCONSIN**

DATE: **JUNE 2015**

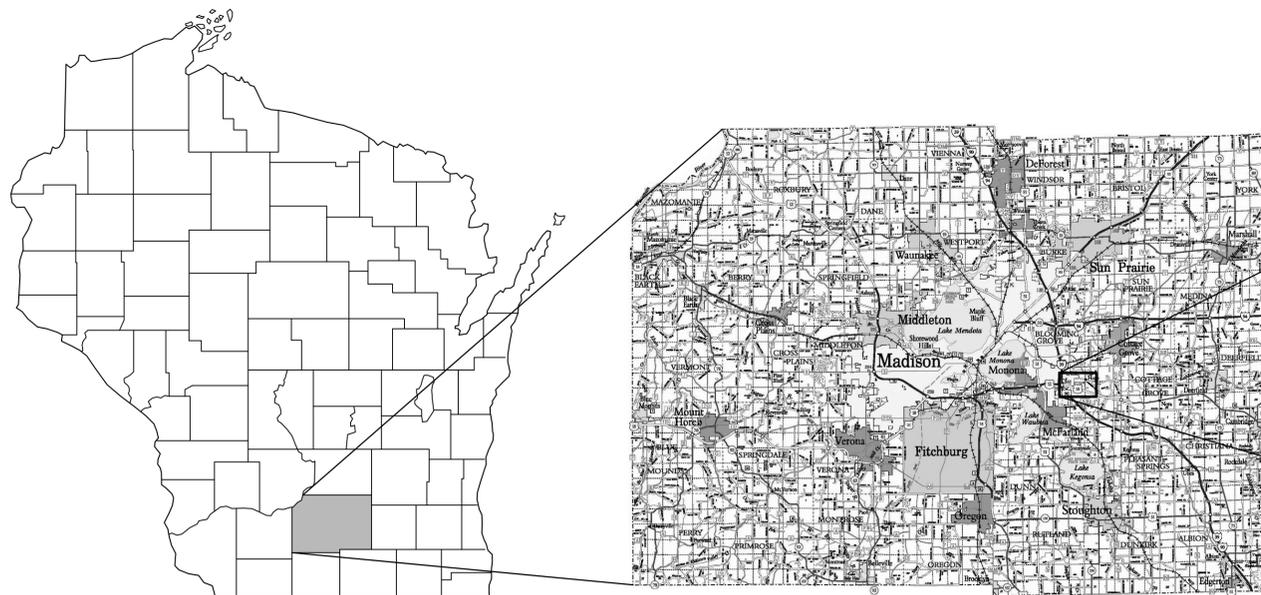

WISCONSIN

DANE COUNTY

SITE LOCATOR


SHEET INDEX	
SHEET NUMBER	SHEET TITLE
1	INDEX/TITLE SHEET
2	STANDARD LEGEND AND GENERAL NOTES
3	EXISTING CONDITIONS MAP
4	SUBBASE GRADES / GROUNDWATER GRADIENT CONTROL SYSTEM
5	BASE GRADES / LEACHATE COLLECTION SYSTEM
6	SOIL STOCKPILE AREAS
7	DETAILS - LINER AND LEACHATE COLLECTION
8	DETAILS - LEACHATE VAULT AND LEACHATE COLLECTION
9	DETAILS - LEACHATE COLLECTION SUMP
10	DETAILS - TIE-IN TO EXISTING LEACHATE TRANSFER SYSTEM
11	DETAILS - MISCELLANEOUS
12	DETAILS - MISCELLANEOUS
13	EROSION CONTROL / SITE RESTORATION PLAN
14	DETAILS - EROSION CONTROL

NOTE: THE CONTRACTOR SHALL NOTIFY ALL AREA UTILITY COMPANIES PRIOR TO COMMENCING WORK ON THIS CONTRACT, IN ACCORDANCE WITH STATE AND LOCAL REQUIREMENTS.

NOTE: THESE PLANS ARE ACCOMPANIED BY A PROJECT MANUAL OF THE SAME TITLE. THESE DOCUMENTS ARE INTERRELATED AND ARE INTENDED TO BE USED TOGETHER.




708 Heartland Trail
Suite 3000
Madison, WI 53717
Phone: 608.826.3600

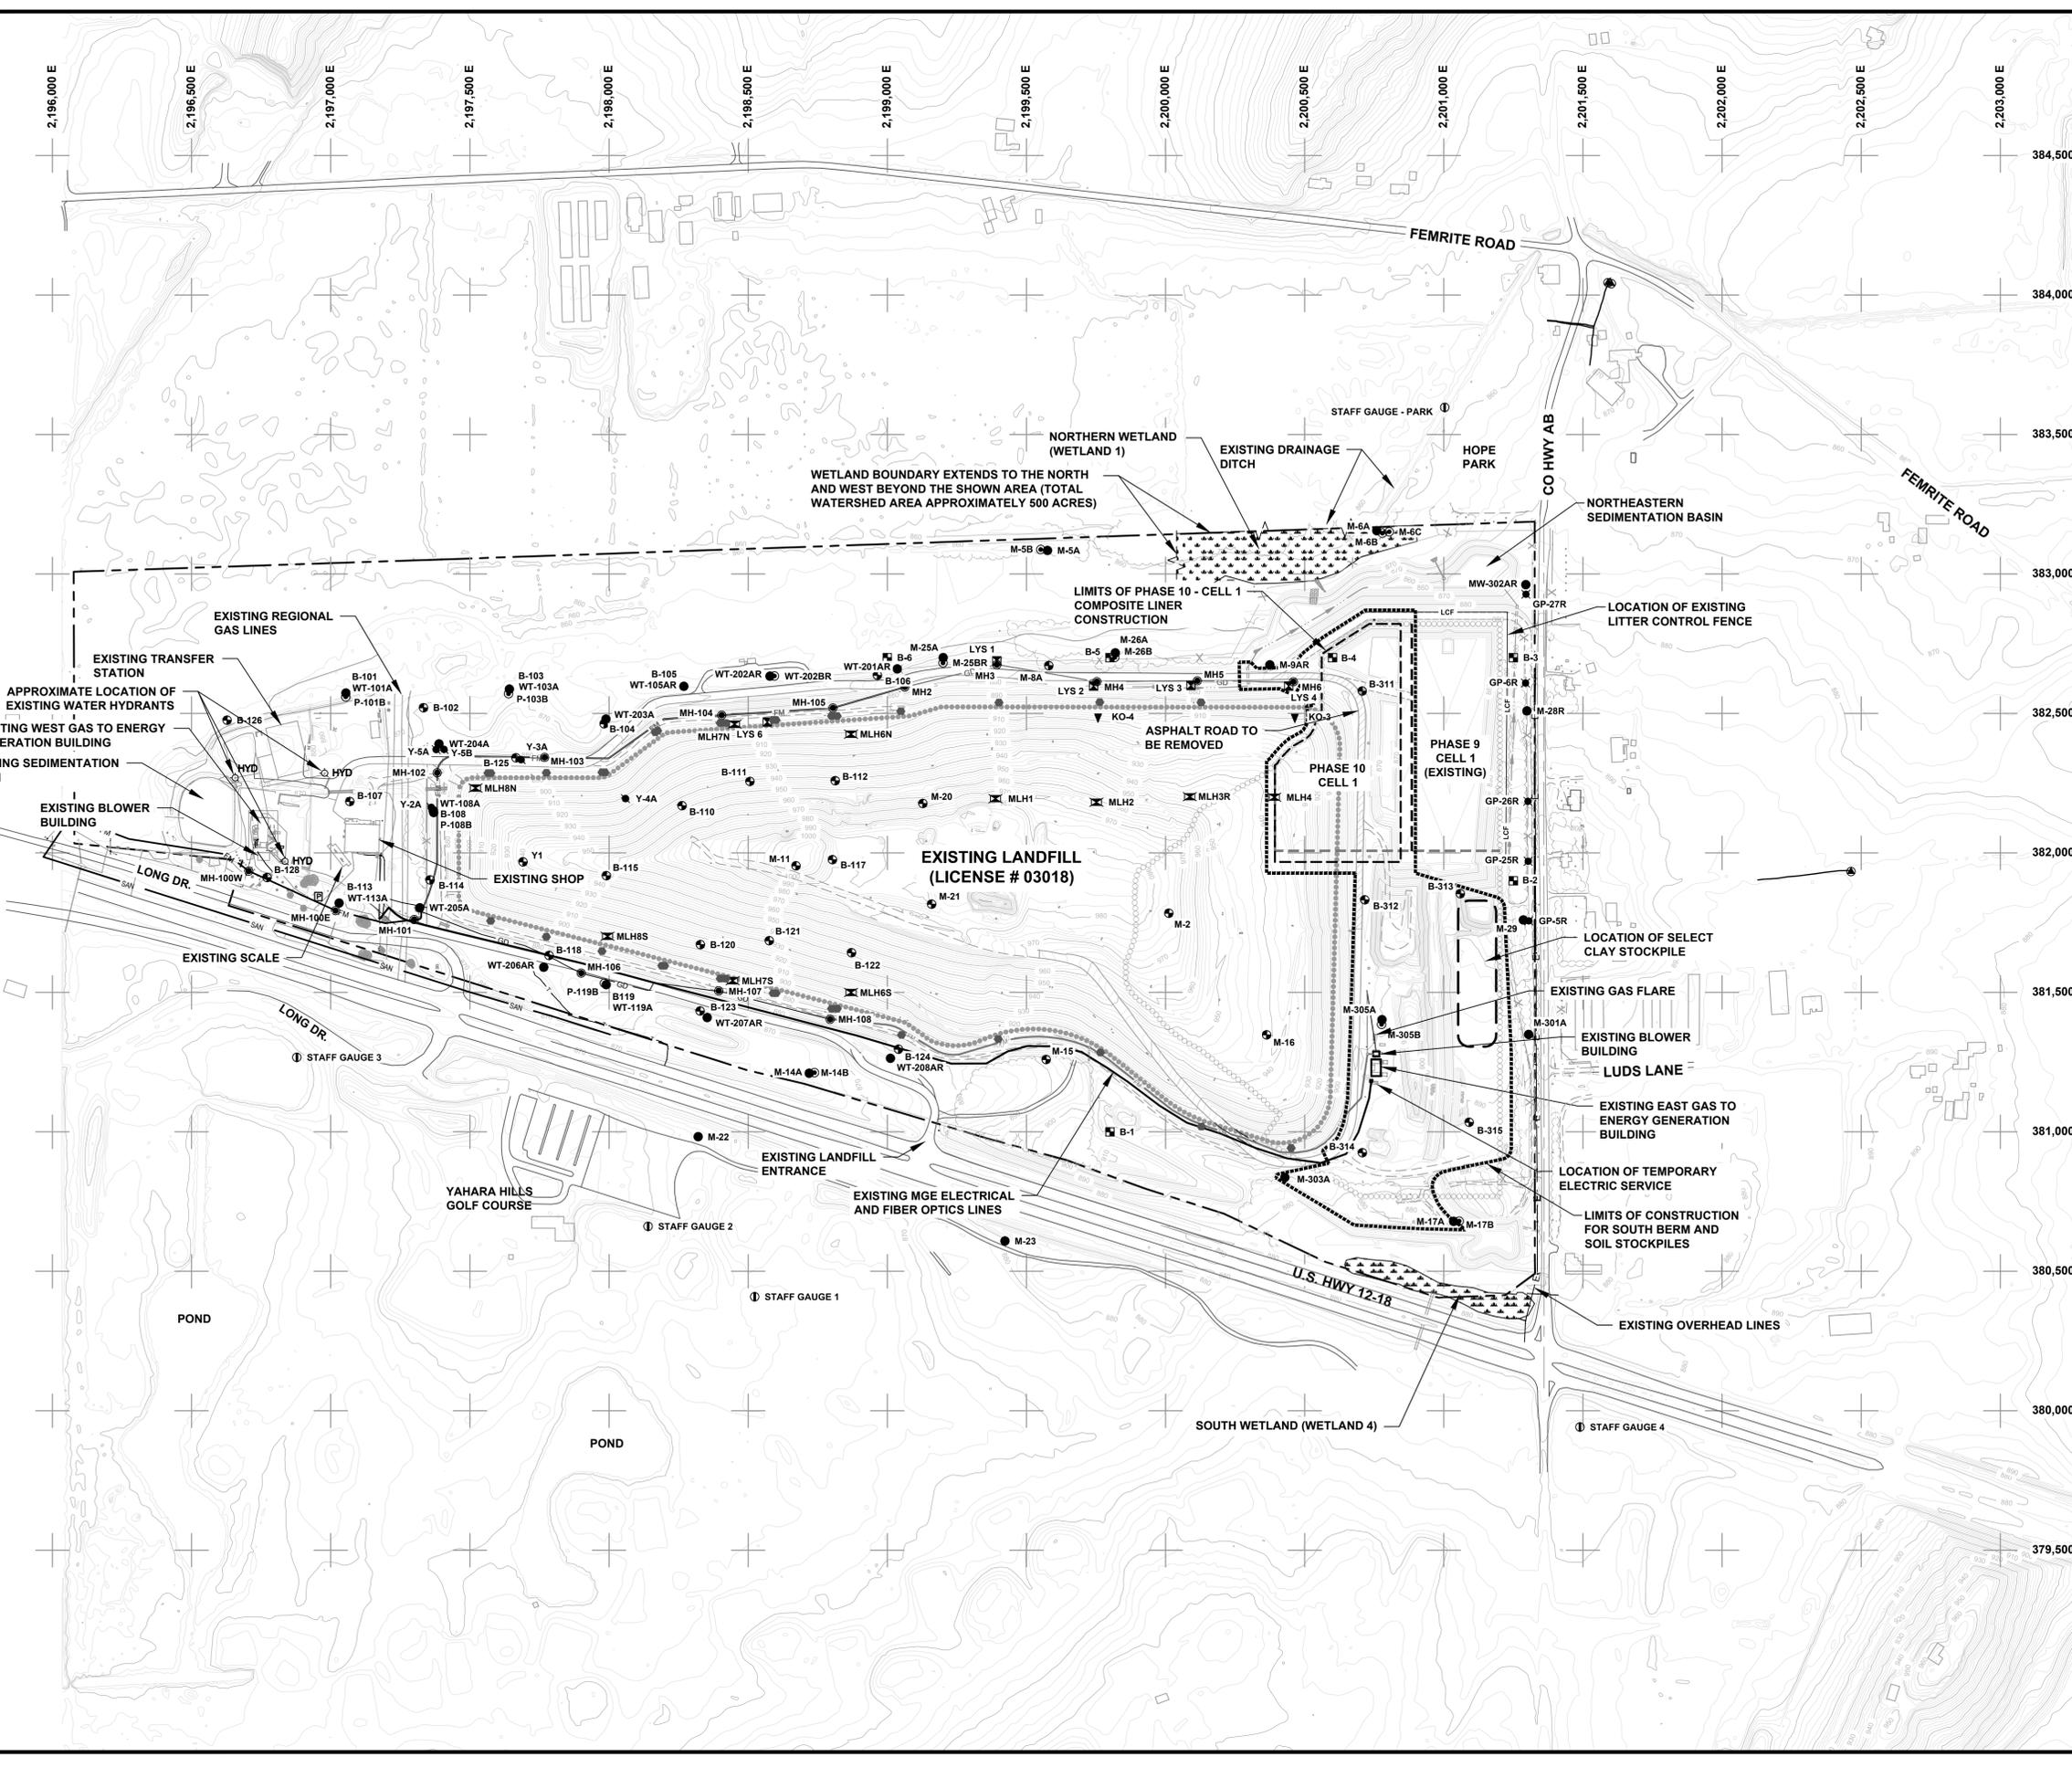

LEGEND

	APPROXIMATE PROPERTY BOUNDARY
	GRID LOCATION
	EXISTING PAVED ROAD
	EXISTING UNPAVED ROAD
	EXISTING FENCE
	EXISTING BUILDING
	EXISTING 10' CONTOUR
	EXISTING 2' CONTOUR
	EXISTING SPOT ELEVATION
	EXISTING TREES AND/OR BRUSH
	EXISTING WET AREA AND WETLAND LIMITS
	EXISTING EDGE OF WATER
	EXISTING OVERHEAD LINES
	DRAINAGE DITCH
	EXISTING APPROVED LIMITS OF WASTE
	APPROVED LIMITS OF WASTE
	CELL/PHASE DELINEATION LINE
	LIMITS OF COMPOSITE LINER CONSTRUCTION
	LIMITS OF CONSTRUCTION
	EXISTING LEACHATE FORCEMAIN LINE
	EXISTING LEACHATE GRAVITY DRAIN LINE
	EXISTING SANITARY SEWER LINE
	EXISTING SURVEY CONTROL MONUMENT
	EXISTING MONITORING WELL LOCATION
	EXISTING PIEZOMETER LOCATION
	EXISTING BORING LOCATION
	EXISTING GAS MONITORING PROBE LOCATION
	EXISTING GAS EXTRACTION WELL
	EXISTING LYSIMETER LOCATION
	EXISTING MANHOLE LOCATION
	EXISTING CLEANOUT LOCATION
	EXISTING LEACHATE HEAD WELL
	EXISTING STAFF GAUGE LOCATION
	EXISTING GRINDER PUMP
	EXISTING WATER HYDRANT
	EXISTING LITTER CONTROL FENCE
	EXISTING ASPHALT ROAD TO BE REMOVED

- NOTES**
- PROPERTY BOUNDARIES IN THE VICINITY OF THE EASTERN EXPANSION SURVEYED BY AECOM DATED: SEPTEMBER 19, 2012.
 - BUILDING INFORMATION PROVIDED BY DANE COUNTY LAND INFORMATION OFFICE MADISON, WI. BUILDING FOOTPRINTS DATED: 2005.
 - UTILITY LOCATIONS SHOWN WERE PROVIDED BY DANE COUNTY.
 - PRESERVE AND PROTECT MONITORING WELLS, GAS MONITORING PROBES, PIEZOMETERS AND BENCHMARKS. DAMAGED WELLS, PROBES AND BENCHMARKS SHALL BE REPAIRED BY THE OWNER AT THE CONTRACTOR'S EXPENSE.
 - PROJECT CONSTRUCTION INCLUDES PHASE 10 - CELL 1 COMPOSITE LINER, ASSOCIATED PIPING AND APPURTENANCES, ACCESS ROADS, STOCKPILES AND BERMS.
 - AREAS WITHIN CONSTRUCTION LIMITS DISTURBED BY CONTRACTOR SHALL BE REGRADED TO PROVIDE POSITIVE DRAINAGE AND RESTORED.
 - CONTRACTOR HAUL ROADS SHALL NOT IMPEDE SURFACE WATER FLOW. PROVIDE CULVERTS, DITCHING, ETC. TO MAINTAIN POSITIVE DRAINAGE.
 - CONTRACTOR TO FIELD VERIFY ALL EXISTING TOPOGRAPHY ELEVATIONS FOR CUT/FILL VOLUMES.

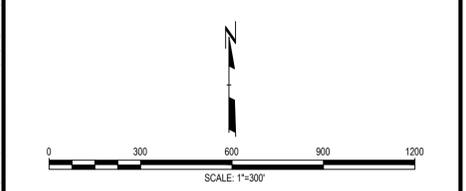

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NO.	BY	DATE	REVISION	APPD.


PROJECT: **DANE COUNTY NO. 2 (RODEFELD) LANDFILL
PHASE 10 - CELL 1 LINER CONSTRUCTION
DANE COUNTY, WISCONSIN**

SHEET TITLE: **EXISTING CONDITIONS MAP**


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CHECKED BY: DM	DATE PRINTED: JUNE 2015	FILE NO: 224310.SHT03-EX.dwg
APPROVED BY: CDM	DATE: JUNE 2015	SHEET 3 OF 14

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 Operator Name: NCLDEN, RANDY
 File Size: 632 kb
 Drawing Size: 15, 2015
 Plot Time: 10:30 AM
 SHEET 3

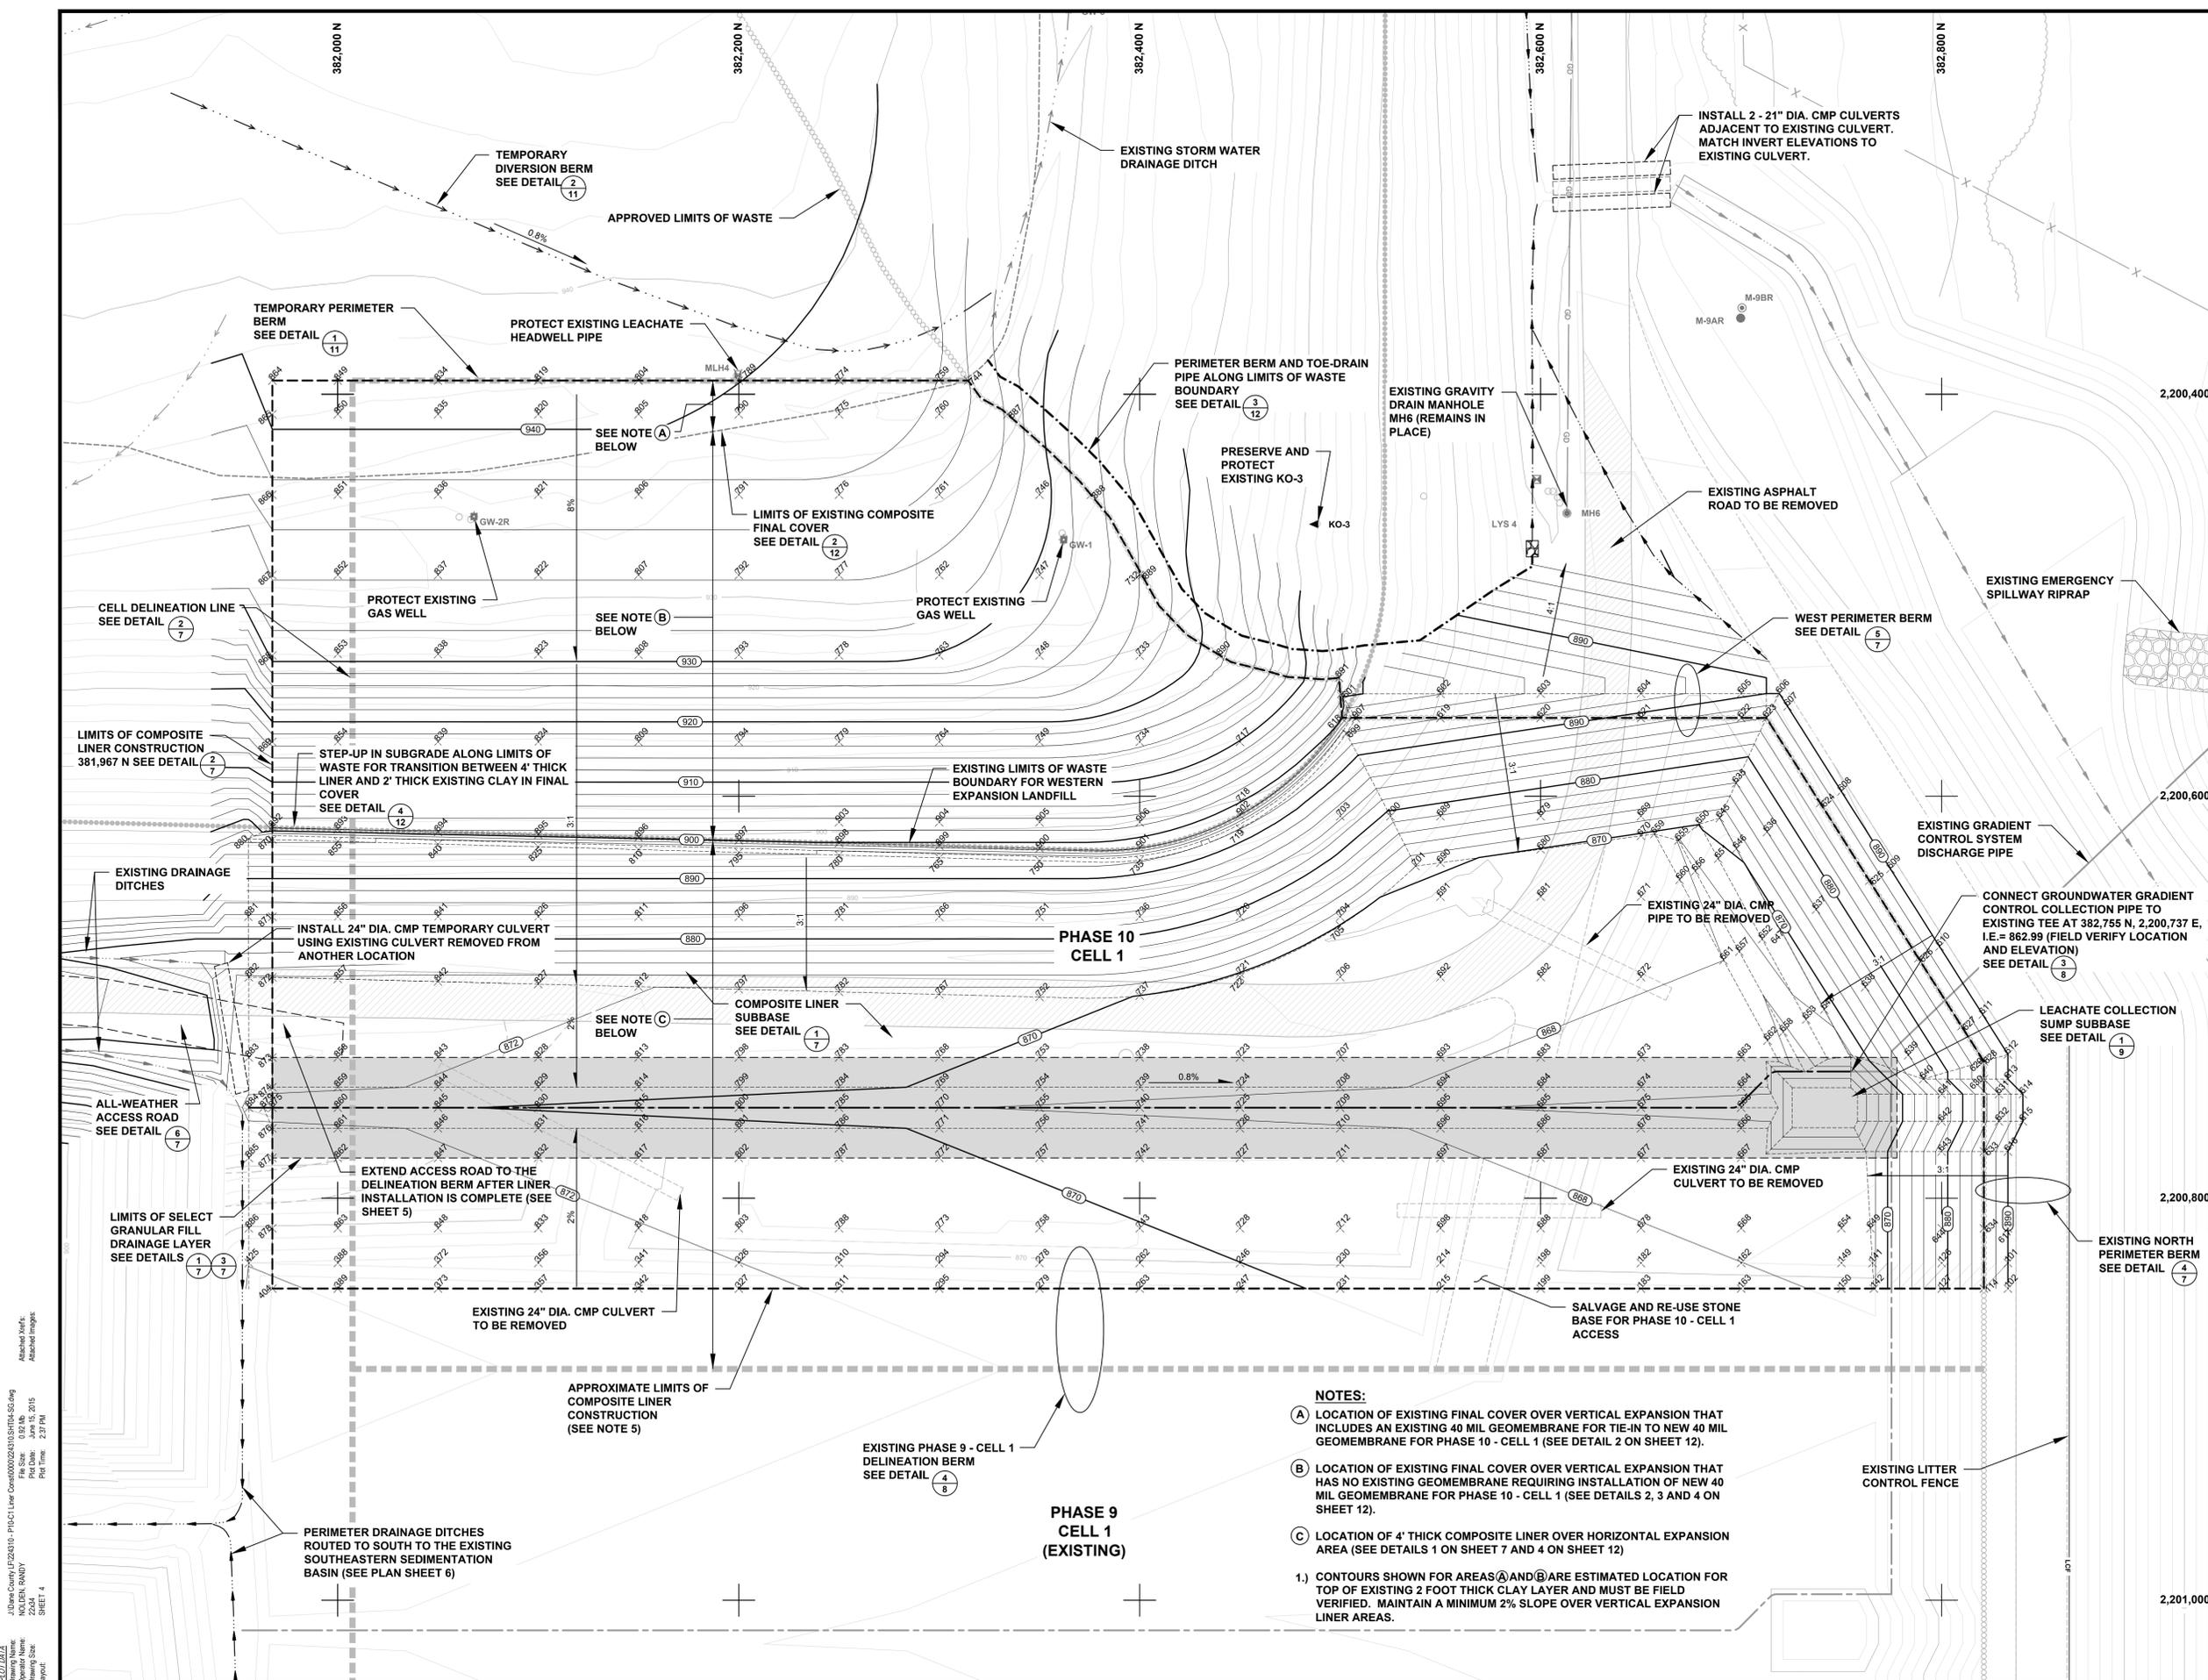

- NOTES**
- REFER TO SHEET 2 OF THIS PLAN SET FOR LEGEND SYMBOLS AND LIST OF NOTES.
 - FULL TONE CONTOURS WITHIN THE LIMITS OF PHASE 10 - CELL 1 COMPOSITE LINER CONSTRUCTION REPRESENT THE BOTTOM OF THE COMPACTED CLAY LINER (SUBBASE GRADES). REFER TO DETAIL 1 ON PLAN SHEET 7 FOR LEACHATE COLLECTION LINE EXCAVATION. REFER TO DETAIL 1 ON PLAN SHEET 9 FOR LEACHATE COLLECTION SUMP COORDINATES AND ELEVATIONS.
 - FULL TONE CONTOURS OUTSIDE THE LIMITS OF PHASE 10 - CELL 1 COMPOSITE LINER CONSTRUCTION REPRESENT FINISHED GRADING (e.g. TOP OF TOPSOIL, TOP OF GRAVEL ROAD, ETC.)
 - REFER TO TABLES 1 & 2 FOR CONSTRUCTION COORDINATE LOCATIONS AND ELEVATIONS.
 - TIE-IN TO EXISTING LINER IN PHASE 9 - CELL 1 BASED ON TRC ENVIRONMENTAL CORP. PHASE 9 - CELL 1 LINER CONSTRUCTION DOCUMENTATION PLANS, DECEMBER 2014. CONTRACTOR TO FIELD VERIFY EXISTING LINER LOCATIONS AND ELEVATIONS PRIOR TO CONSTRUCTING LINER SPLICE.
 - NO TREES TO BE REMOVED OUTSIDE LIMITS OF CONSTRUCTION LINE.
 - CONTRACTOR IS RESPONSIBLE FOR REMOVAL OF SURFACE WATER IN PUMPOUT BASIN AND ALL OTHER LOCATIONS WHERE WATER MAY INTERFERE WITH CONSTRUCTION ACTIVITIES.
 - TYPE A EROSION CONTROL AND VEGETATION MAT (ECRM) ON ALL 3:1 SLOPES AND STEEPER EXCEPT IN CLAY LINER AREA. REFER TO PLAN SHEET 13.

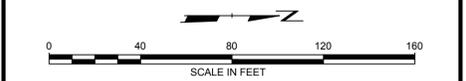


NOTE: THE CONTRACTOR SHALL NOTIFY ALL AREA UTILITY COMPANIES PRIOR TO COMMENCING WORK ON THIS CONTRACT. IN ACCORDANCE WITH STATE AND LOCAL REQUIREMENTS.

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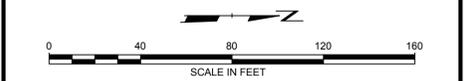
NO.	BY	DATE	REVISION	APPD.
PROJECT: DANE COUNTY NO. 2 (RODEFELD) LANDFILL PHASE 10 - CELL 1 LINER CONSTRUCTION DANE COUNTY, WISCONSIN				
SHEET TITLE: SUBBASE GRADES / GROUNDWATER GRADIENT CONTROL SYSTEM				
DRAWN BY: RNOLDEN		SCALE: AS SHOWN		PROJ. NO. 224310.0000.0000
CHECKED BY: DM		DATE PRINTED:		FILE NO. 224310.SHT04-SG.dwg
APPROVED BY: CDM		DATE: JUNE 2015		SHEET 4 OF 14

- NOTES:**
- LOCATION OF EXISTING FINAL COVER OVER VERTICAL EXPANSION THAT INCLUDES AN EXISTING 40 MIL GEOMEMBRANE FOR TIE-IN TO NEW 40 MIL GEOMEMBRANE FOR PHASE 10 - CELL 1 (SEE DETAIL 2 ON SHEET 12).
 - LOCATION OF EXISTING FINAL COVER OVER VERTICAL EXPANSION THAT HAS NO EXISTING GEOMEMBRANE REQUIRING INSTALLATION OF NEW 40 MIL GEOMEMBRANE FOR PHASE 10 - CELL 1 (SEE DETAILS 2, 3 AND 4 ON SHEET 12).
 - LOCATION OF 4" THICK COMPOSITE LINER OVER HORIZONTAL EXPANSION AREA (SEE DETAILS 1 ON SHEET 7 AND 4 ON SHEET 12)
- CONTOURS SHOWN FOR AREAS (A) AND (B) ARE ESTIMATED LOCATION FOR TOP OF EXISTING 2 FOOT THICK CLAY LAYER AND MUST BE FIELD VERIFIED. MAINTAIN A MINIMUM 2% SLOPE OVER VERTICAL EXPANSION LINER AREAS.

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 File Size: 532 Mb
 Drawing Date: JUN 15, 2015
 Plot Time: 1:25 PM
 SHEET 4
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- NOTES**
- REFER TO SHEET 2 OF THIS PLAN SET FOR LEGEND SYMBOLS AND LIST OF NOTES.
 - FULL TONE CONTOURS WITHIN THE LIMITS OF PHASE 10 - CELL 1 COMPOSITE LINER CONSTRUCTION REPRESENT THE TOP OF THE COMPACTED CLAY LINER (BASE GRADES). REFER TO DETAIL 1 ON PLAN SHEET 7 FOR LEACHATE COLLECTION LINE EXCAVATION. REFER TO DETAIL 1 ON PLAN SHEET 9 FOR LEACHATE COLLECTION SUMP COORDINATES AND ELEVATIONS.
 - FULL TONE CONTOURS OUTSIDE THE LIMITS OF PHASE 10 - CELL 1 COMPOSITE LINER CONSTRUCTION REPRESENT FINISHED GRADING (e.g. TOP OF TOPSOIL, TOP OF GRAVEL ROAD, ETC.)
 - REFER TO TABLES 2 THROUGH 5 FOR CONSTRUCTION COORDINATE LOCATIONS AND ELEVATIONS.
 - TIE-IN TO EXISTING LINER IN PHASE 9 - CELL 1 BASED ON TRC ENVIRONMENTAL CORP. PHASE 9 - CELL 1 LINER CONSTRUCTION DOCUMENTATION PLANS, DECEMBER 2014. CONTRACTOR TO FIELD VERIFY EXISTING LINER LOCATIONS AND ELEVATIONS PRIOR TO CONSTRUCTING LINER SPLICE.
 - CONTRACTOR TO REPAIR ASPHALT IN LOCATIONS WHERE DISTURBED OR REMOVED FOR CONSTRUCTION.
 - INSTALL WISDOT CLASS I TYPE A EROSION CONTROL AND VEGETATION MAT (ECRM) ON ALL 3:1 SLOPES AND STEEPER EXCEPT IN CLAY LINER AREA. REFER TO PLAN SHEET 13.
 - CONNECT EXISTING 2' LONG FORCEMAIN PIPE STUB TO PHASE 10 - CELL 1 VAULT FORCEMAIN PIPE. EXISTING TEE LOCATED AT 2,200,760 E. (FIELD VERIFY LOCATION AND ELEVATION.)

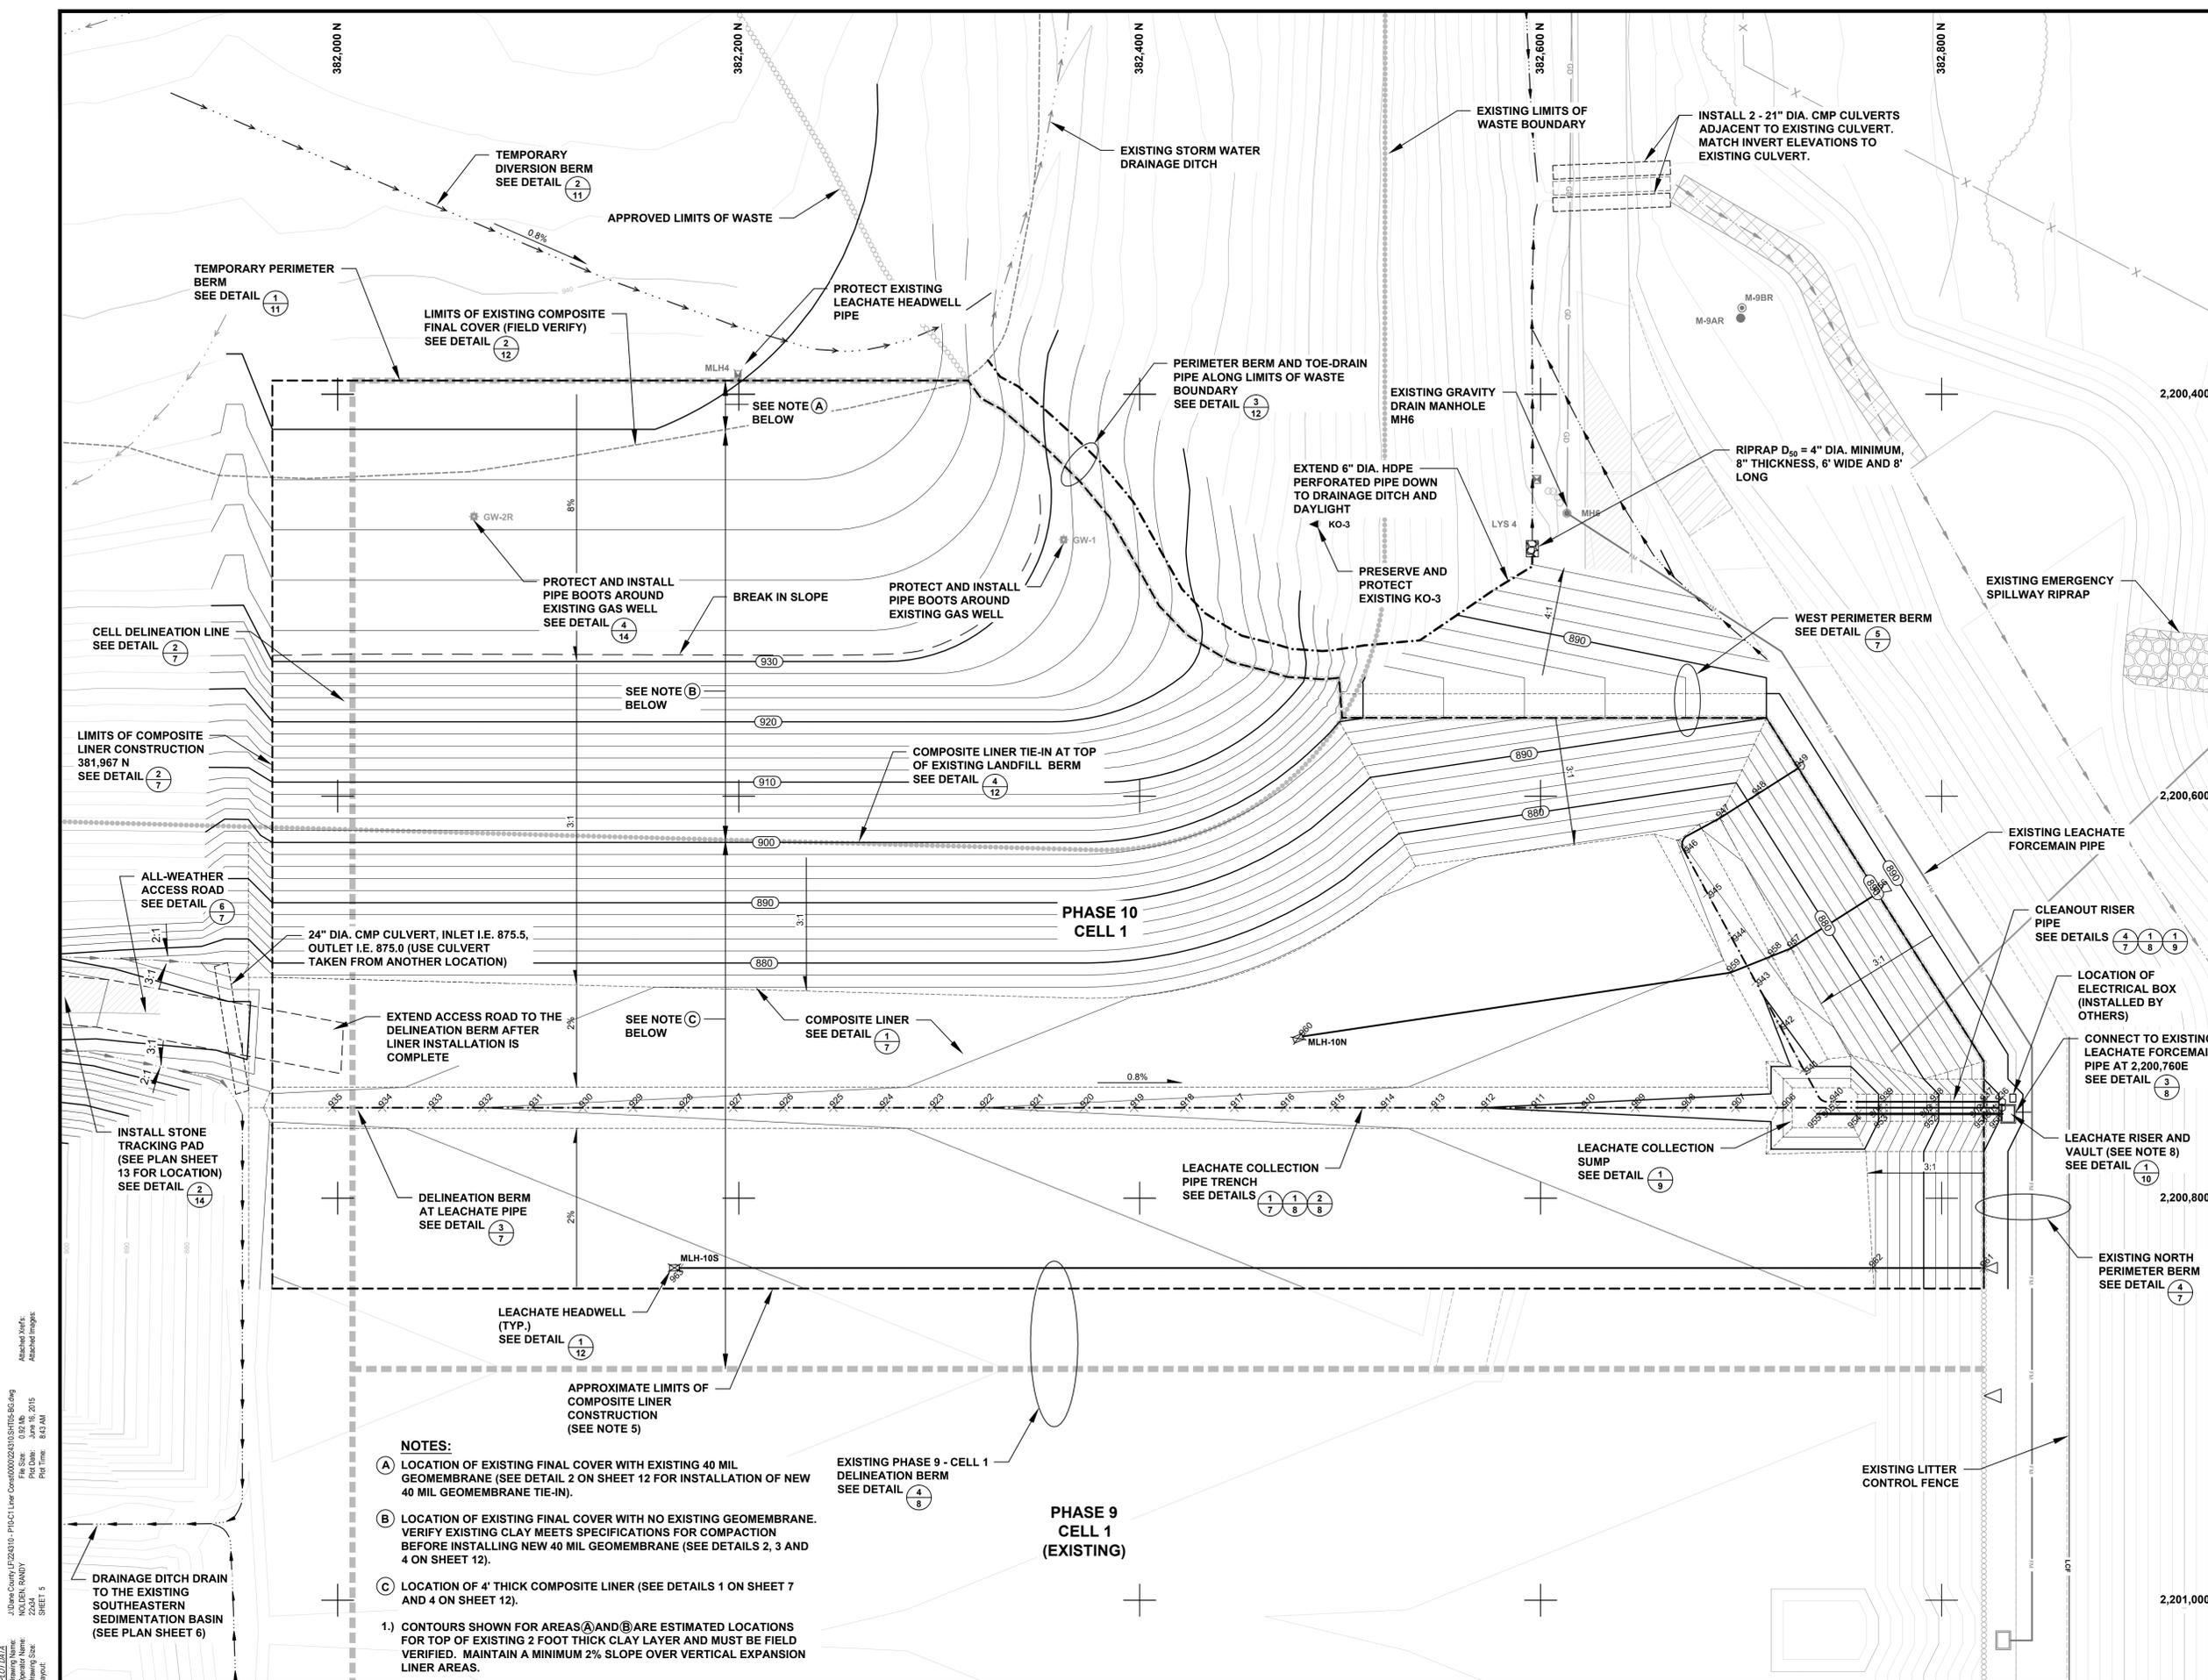

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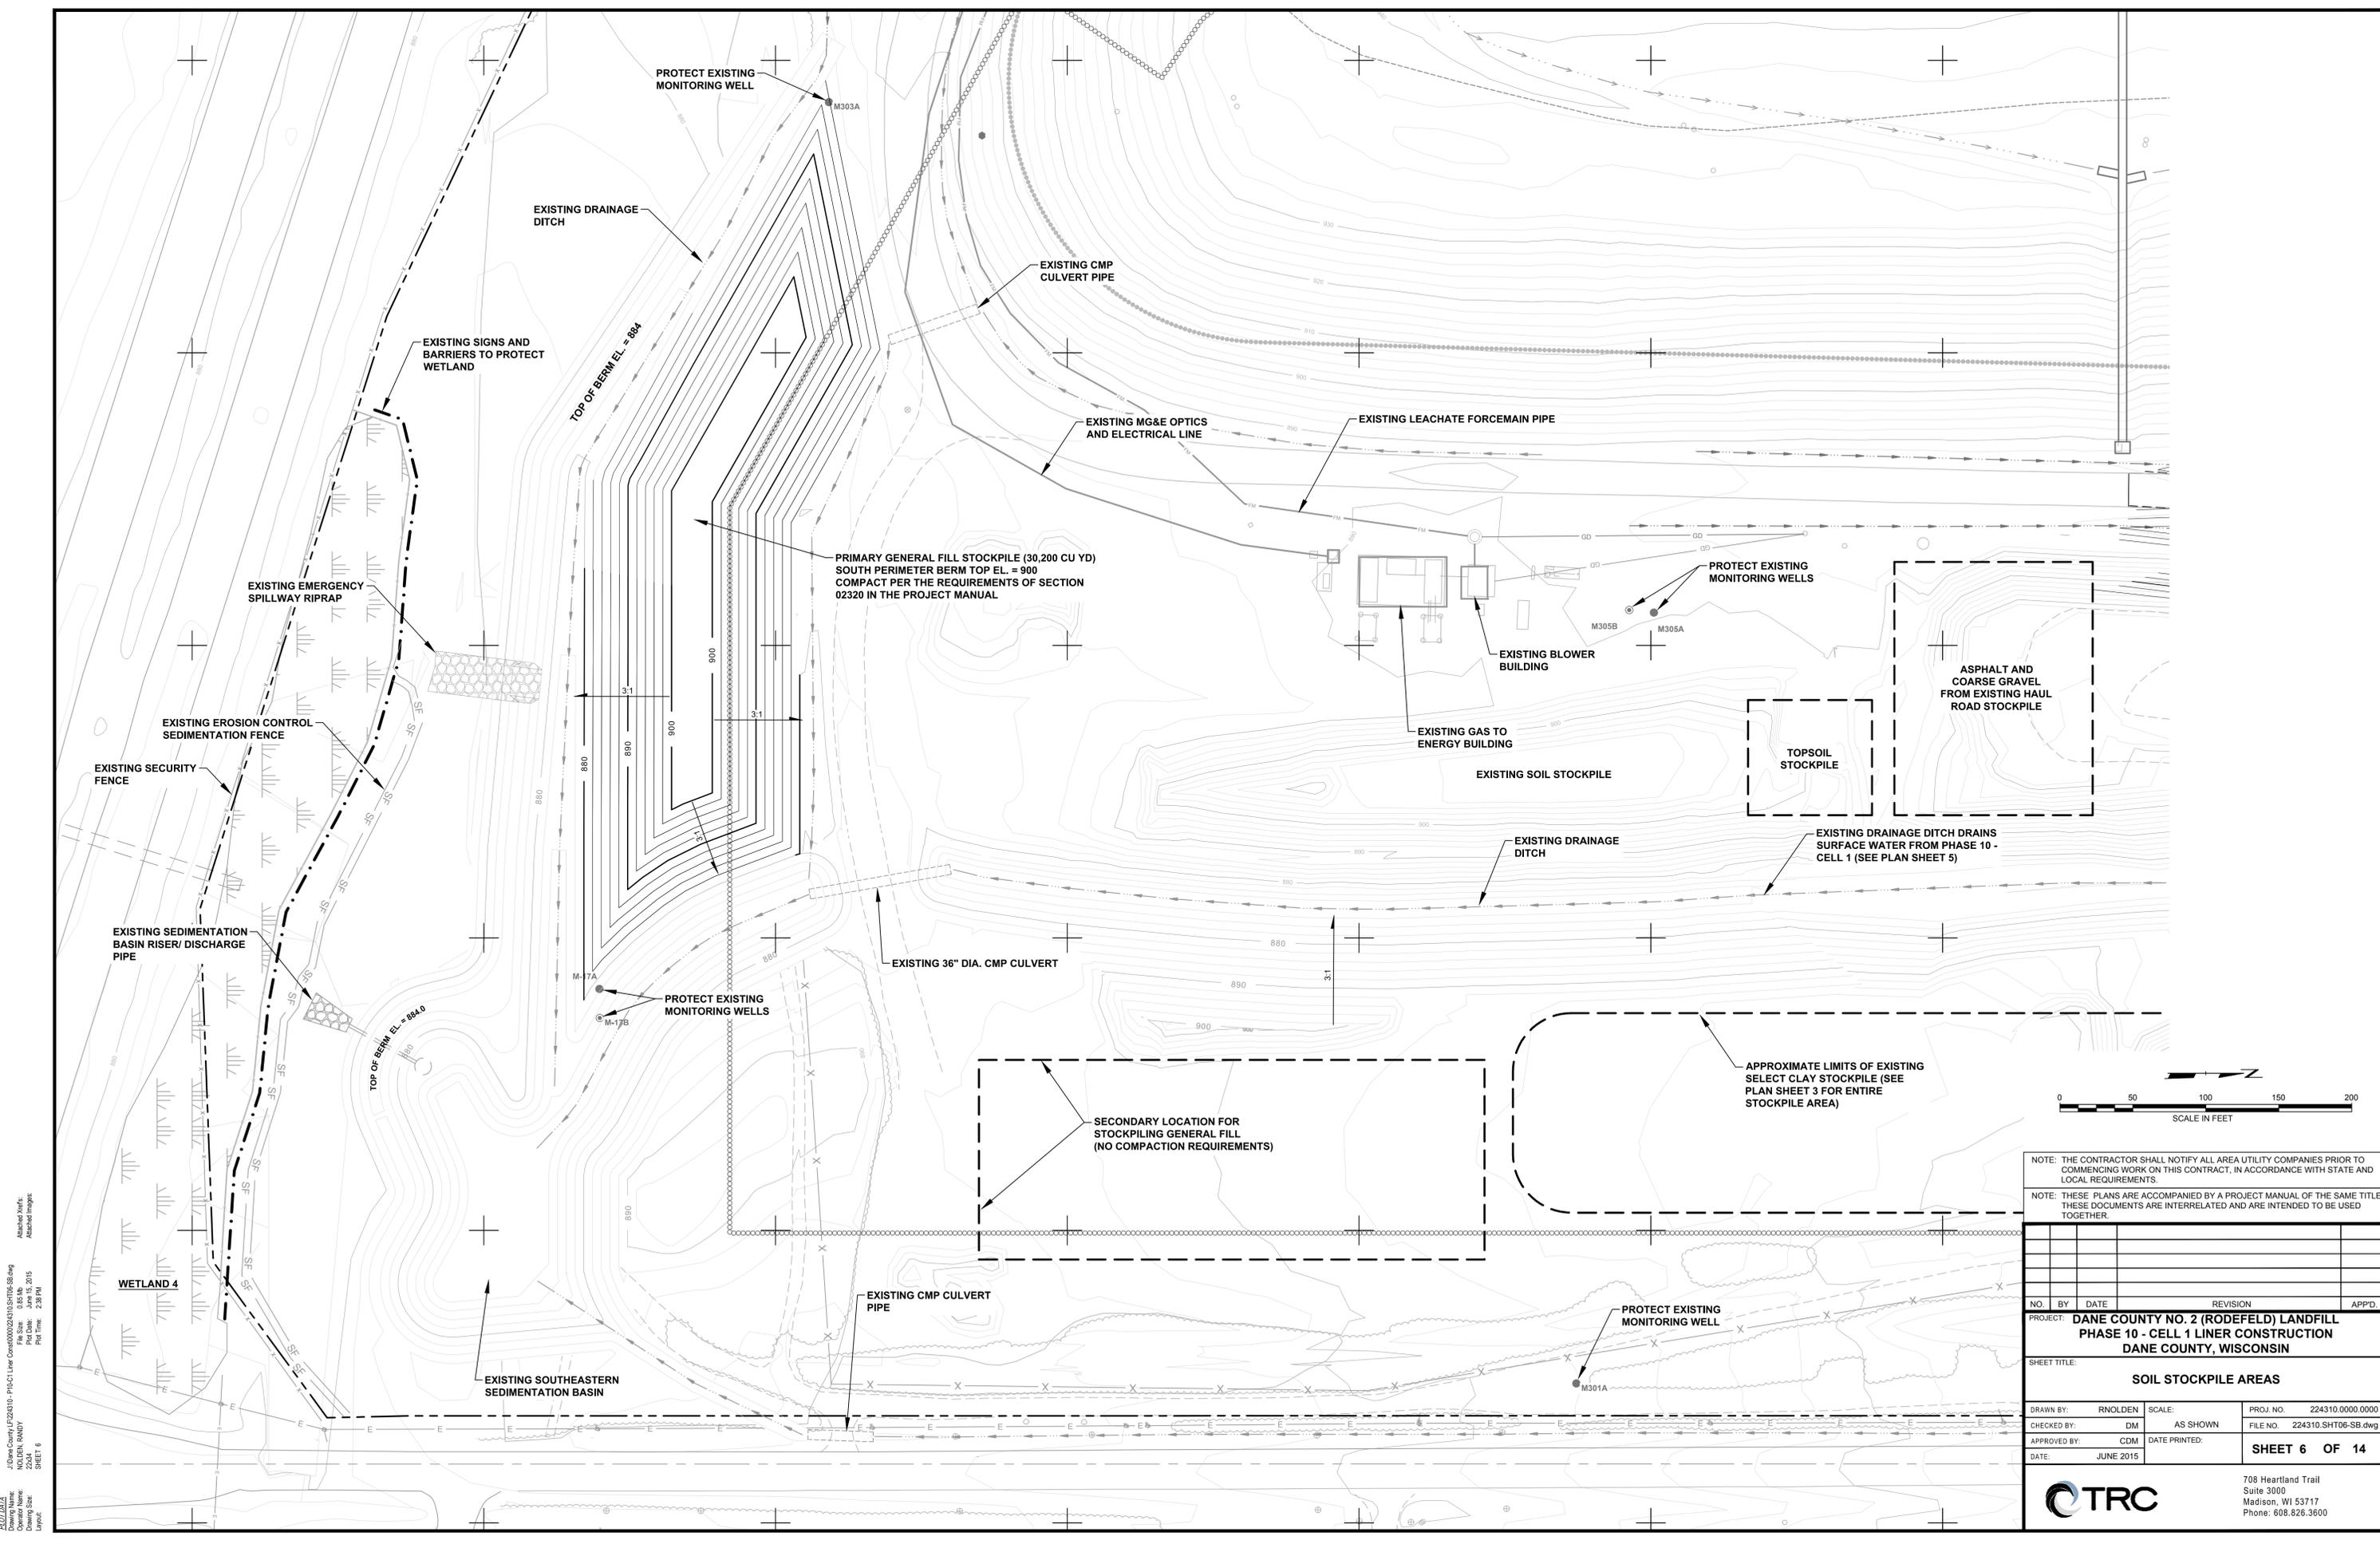
PROJECT: **DANE COUNTY NO. 2 (RODEFILD) LANDFILL
PHASE 10 - CELL 1 LINER CONSTRUCTION
DANE COUNTY, WISCONSIN**

SHEET TITLE: **BASE GRADES / LEACHATE
COLLECTION SYSTEM**

DRAWN BY: RNOLDEN	SCALE: AS SHOWN	PROJ. NO. 224310.0000.0000
CHECKED BY: DM	DATE PRINTED: JUNE 2015	FILE NO. 224310.SHT05-BG.dwg
APPROVED BY: CDM	DATE: JUNE 2015	SHEET 5 OF 14

- NOTES:**
- LOCATION OF EXISTING FINAL COVER WITH EXISTING 40 MIL GEOMEMBRANE (SEE DETAIL 2 ON SHEET 12 FOR INSTALLATION OF NEW 40 MIL GEOMEMBRANE TIE-IN).
 - LOCATION OF EXISTING FINAL COVER WITH NO EXISTING GEOMEMBRANE. VERIFY EXISTING CLAY MEETS SPECIFICATIONS FOR COMPACTION BEFORE INSTALLING NEW 40 MIL GEOMEMBRANE (SEE DETAILS 2, 3 AND 4 ON SHEET 12).
 - LOCATION OF 4' THICK COMPOSITE LINER (SEE DETAILS 1 ON SHEET 7 AND 4 ON SHEET 12).
- 1.) CONTOURS SHOWN FOR AREAS (A) AND (B) ARE ESTIMATED LOCATIONS FOR TOP OF EXISTING 2 FOOT THICK CLAY LAYER AND MUST BE FIELD VERIFIED. MAINTAIN A MINIMUM 2% SLOPE OVER VERTICAL EXPANSION LINER AREAS.

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 SHEET 5




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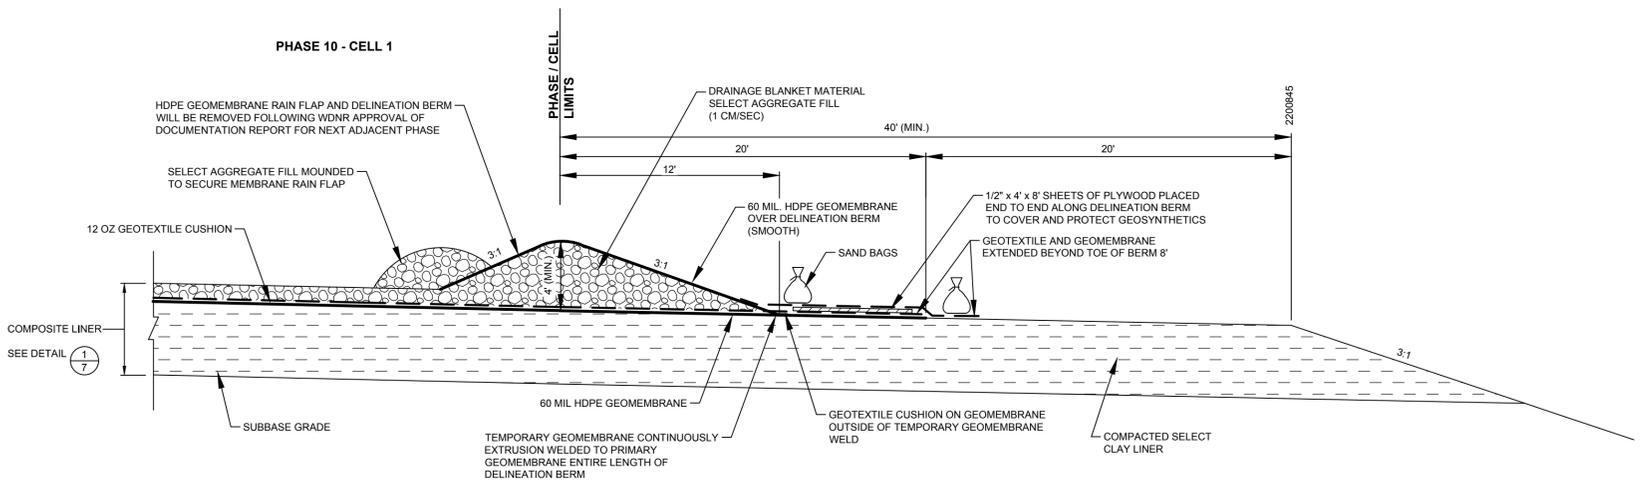
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PROJECT: DANE COUNTY NO. 2 (RODEFELD) LANDFILL				
PHASE 10 - CELL 1 LINER CONSTRUCTION				
DANE COUNTY, WISCONSIN				
SHEET TITLE: SOIL STOCKPILE AREAS				
DRAWN BY:	RNOLDEN	SCALE:	AS SHOWN	PROJ. NO. 224310.0000.0000
CHECKED BY:	DM	DATE PRINTED:		FILE NO. 224310.SHT06-SB.dwg
APPROVED BY:	CDM			SHEET 6 OF 14
DATE:	JUNE 2015			



 708 Heartland Trail
 Suite 3000
 Madison, WI 53717
 Phone: 608.828.3600




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7 LEACHATE COLLECTION PIPE TRENCH
(NOT TO SCALE)

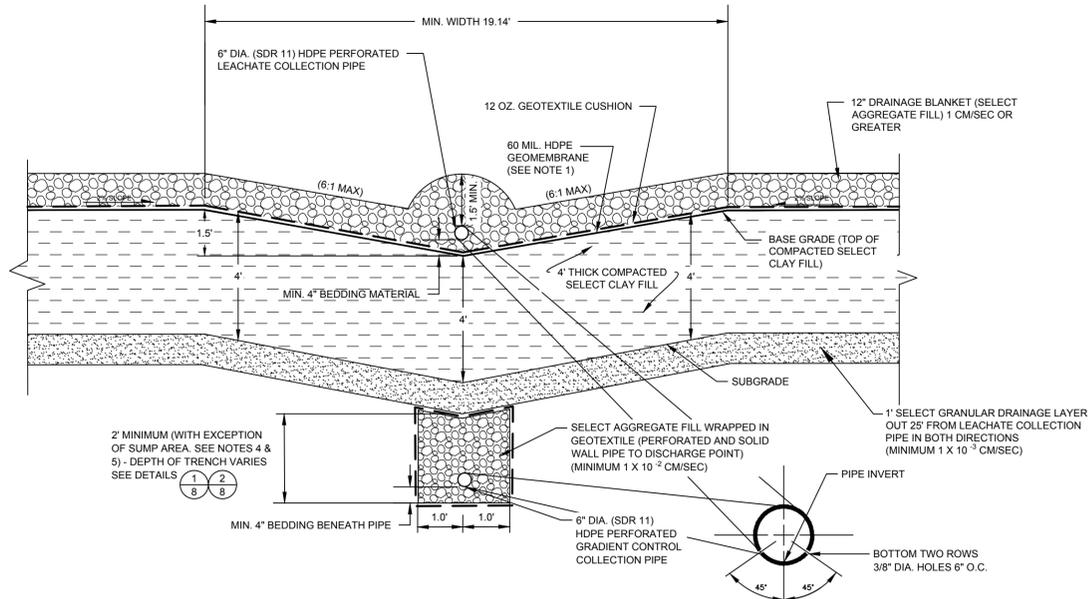


2
7 SOUTH DELINEATION BERM (TYPICAL)
(SCALE 1"=5')

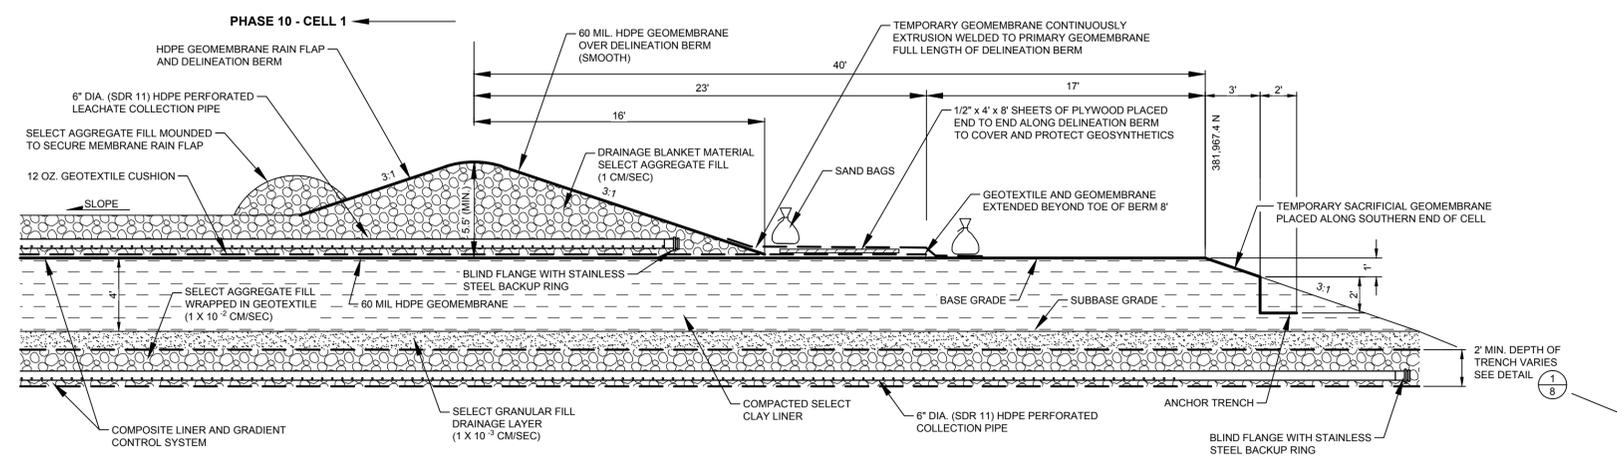


3
7 SOUTH DELINEATION BERM AT LEACHATE COLLECTION PIPES (RUNS EAST TO WEST)
(SCALE 1"=5')

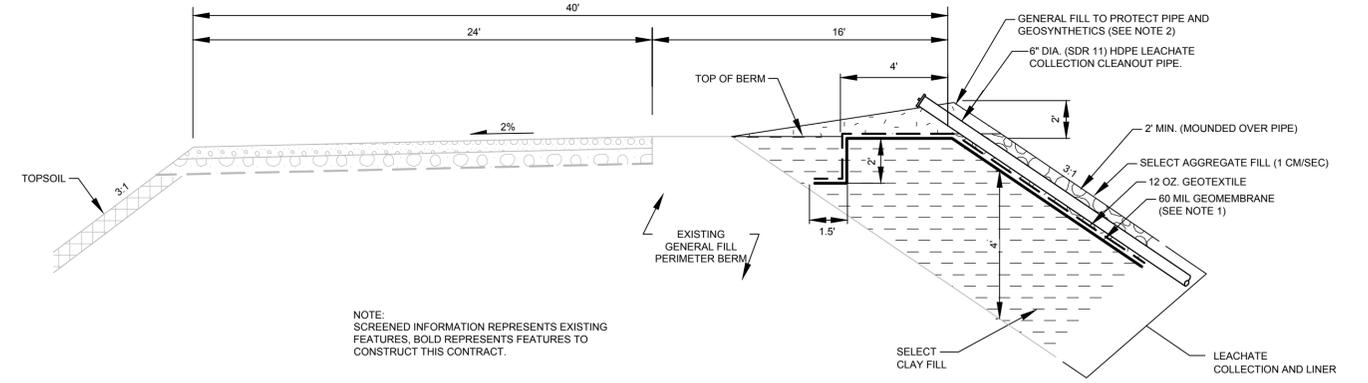

4
7 NORTH PERIMETER BERM COLLECTION/CLEANOUT PIPE (TYP.)
(NOT TO SCALE)

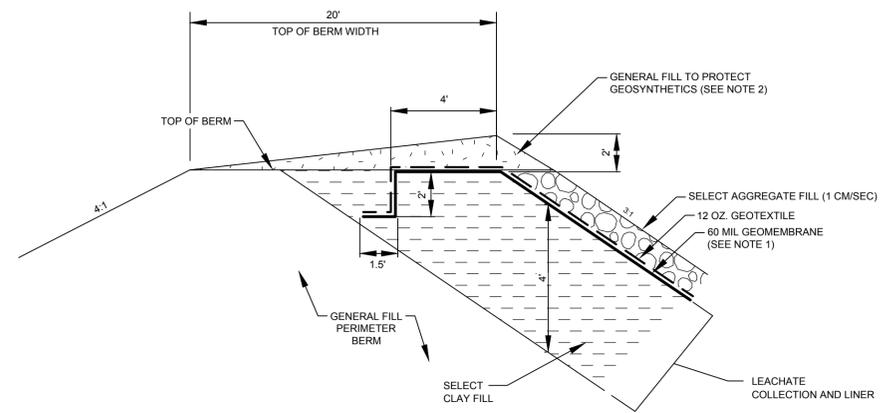

5
7 WEST PERIMETER BERM EAST OF MANHOLE MH6
(NOT TO SCALE)

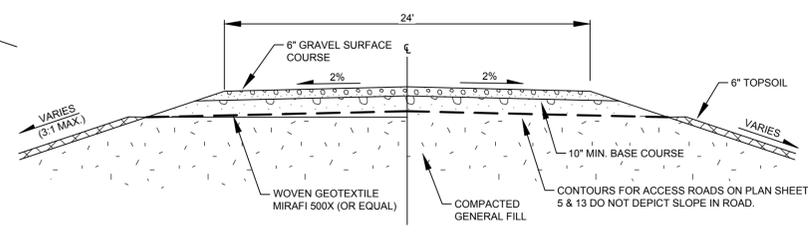

6
7 ALL-WEATHER ACCESS ROAD (TYP.)
(NOT TO SCALE)

- NOTES:**
- 60 MIL HDPE GEOMEMBRANE TEXTURED ON PERIMETER BERM SIDESLOPE AND 5' OUT OVER BASE - SMOOTH GEOMEMBRANE OVER REMAINDER OF BASE GRADES.
 - DO NOT INSTALL GENERAL FILL BERMS AT TOP OF LANDFILL PERIMETER BERM TO PROTECT GEOMEMBRANE UNTIL COMPLETION OF GEOMEMBRANE ELECTRICAL RESISTIVITY TESTING.
 - SEE PLAN SHEET 4 AND DETAILS 1 AND 3 ON PLAN SHEET 8 FOR LOCATION OF GRADIENT CONTROL SYSTEM.
 - MINIMUM DEPTH OF PIPE TRENCH AT SUMP IS 1.2 FEET.
 - MINIMUM DEPTH OF PIPE TRENCH WHERE GRADIENT CONTROL PIPE PASSES UNDER THE LATERAL LEACHATE COLLECTION PIPE IS 1.4 FEET (SEE POINT 113 ON DETAIL 1 OF PLAN SHEET 9).

LINE AND SHADING LEGEND


60 MIL HDPE GEOMEMBRANE	GEOCOMPOSITE
GEOTEXTILE	
TOPSOIL	NATIVE SOIL
GENERAL FILL	CONCRETE
SELECT GRANULAR FILL	RIPRAP
BARRIER LAYER FINE GRADED SOIL	BITUMINOUS PAVING
SELECT AGGREGATE FILL	SELECT FOUNDRY BYPRODUCT
COMPACTED SELECT CLAY FILL	

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PROJECT: DANE COUNTY NO. 2 (RODEFELD) LANDFILL				
PHASE 10 - CELL 1 LINER CONSTRUCTION				
DANE COUNTY, WISCONSIN				
SHEET TITLE: DETAILS - LINER AND LEACHATE COLLECTION				
DRAWN BY:	RNOLDEN	SCALE:	AS SHOWN	PROJ. NO. 224310.0000.0000
CHECKED BY:	DM	FILE NO.:	224310.SHT07-DT.dwg	
APPROVED BY:	CDM	DATE PRINTED:		
DATE:	JUNE 2015			SHEET 7 OF 14


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Drawing Name: NOLDER, RANDY
Drawing Date: 06/15/2015
Drawing Size: 10.00 x 10.00
SHEET: 7



CROSS SECTION 2,200,755E ALONG LEACHATE / GRADIENT CONTROL PIPES

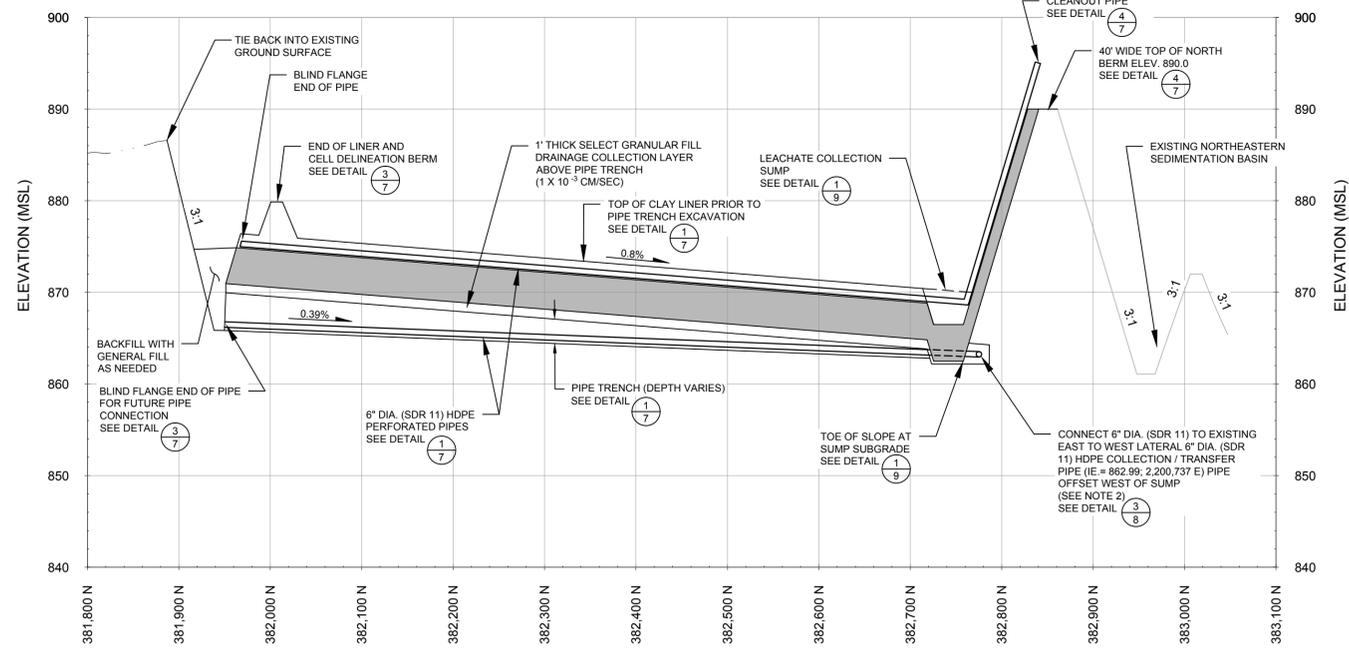1
8



(AS SHOWN)

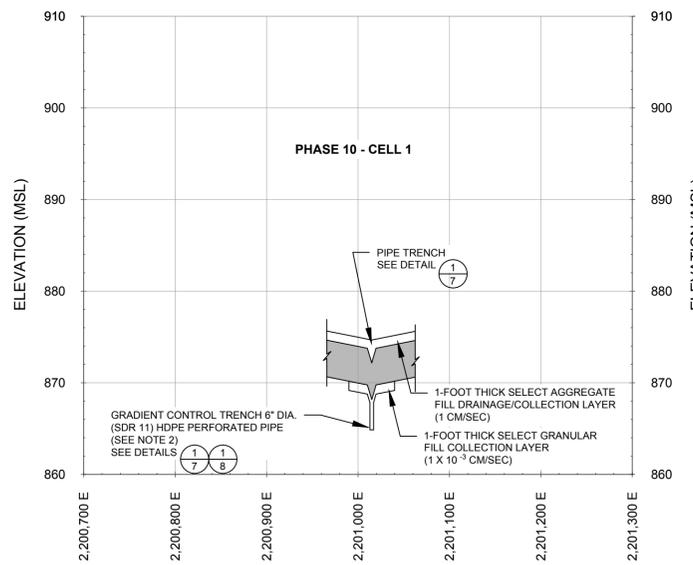

CROSS SECTION 382,300 N - LOOKING NORTH

2
8

(AS SHOWN)

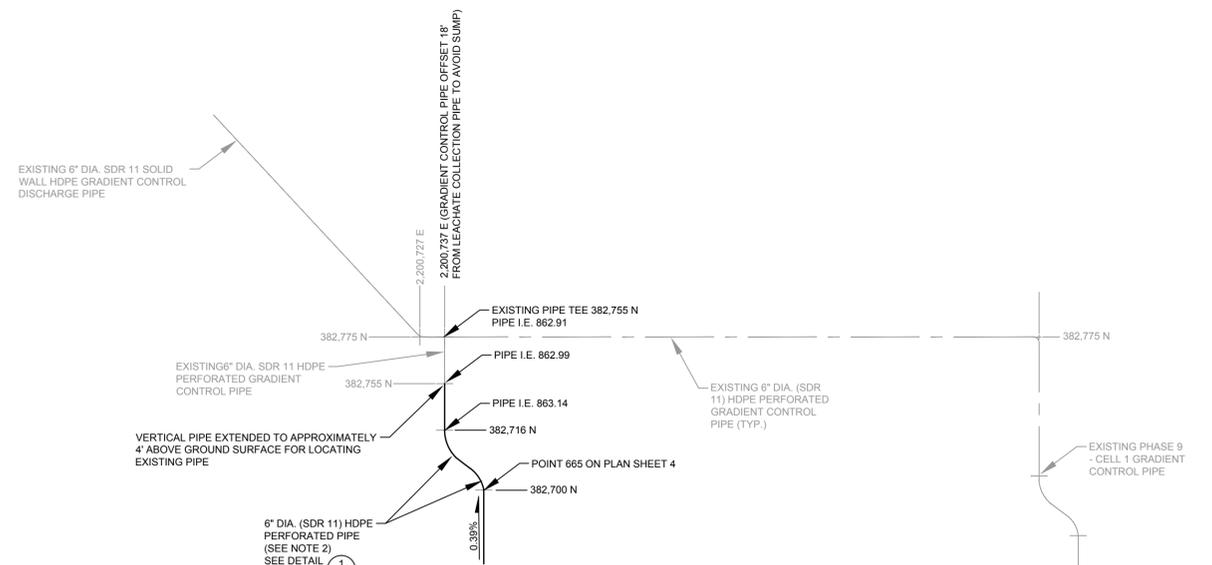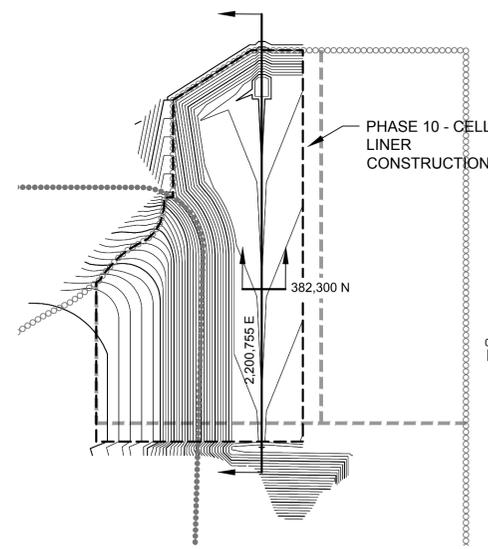

NOTES:
1. 6" DIA. GRADIENT CONTROL PIPE IS LOCATED DIRECTLY UNDER THE LEACHATE COLLECTION PIPE UNTIL PIPE REACHES SUMP AREA WHERE IT JOGS TO THE WEST 18' TO AVOID SUMP.


PLAN VIEW

NOTE: INFORMATION SHOWN AS SCREENED ARE EXISTING FEATURES. INFORMATION IN BOLD ARE FEATURES INSTALLED THIS CONTRACT.

EXISTING GRADIENT CONTROL PIPE LOCATION AT LANDFILL NORTH PERIMETER BERM

3
8

(AS SHOWN)

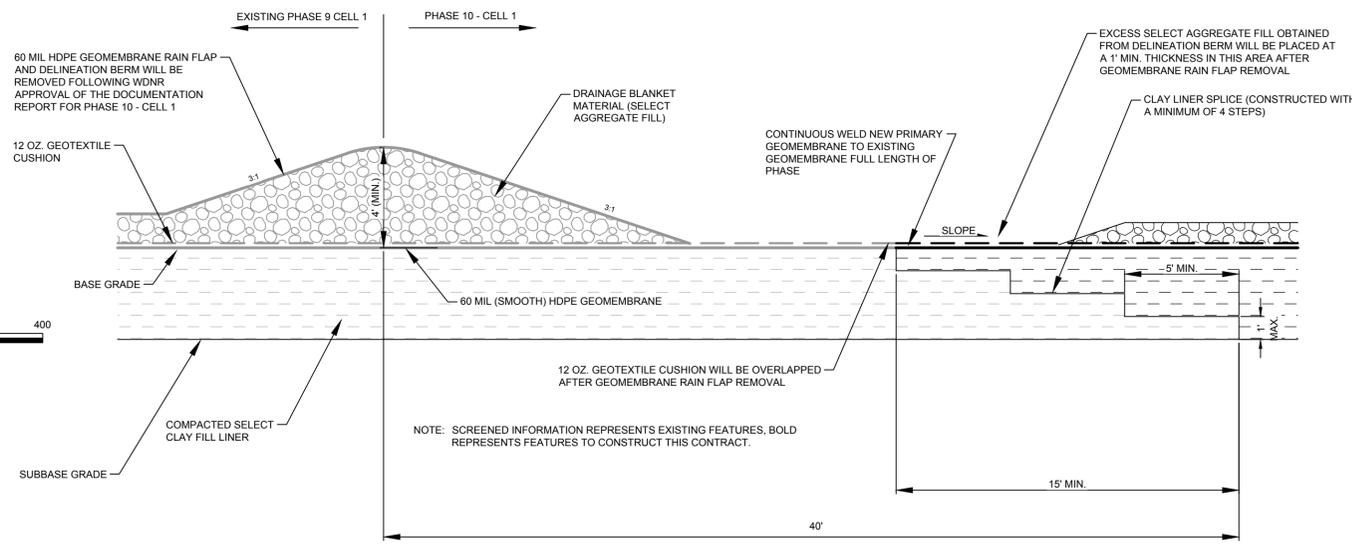

LINER SPlice BETWEEN PHASE 10 - CELL 1 AND PHASE 9 - CELL 1

4
8

(AS SHOWN)

LINE AND SHADING LEGEND

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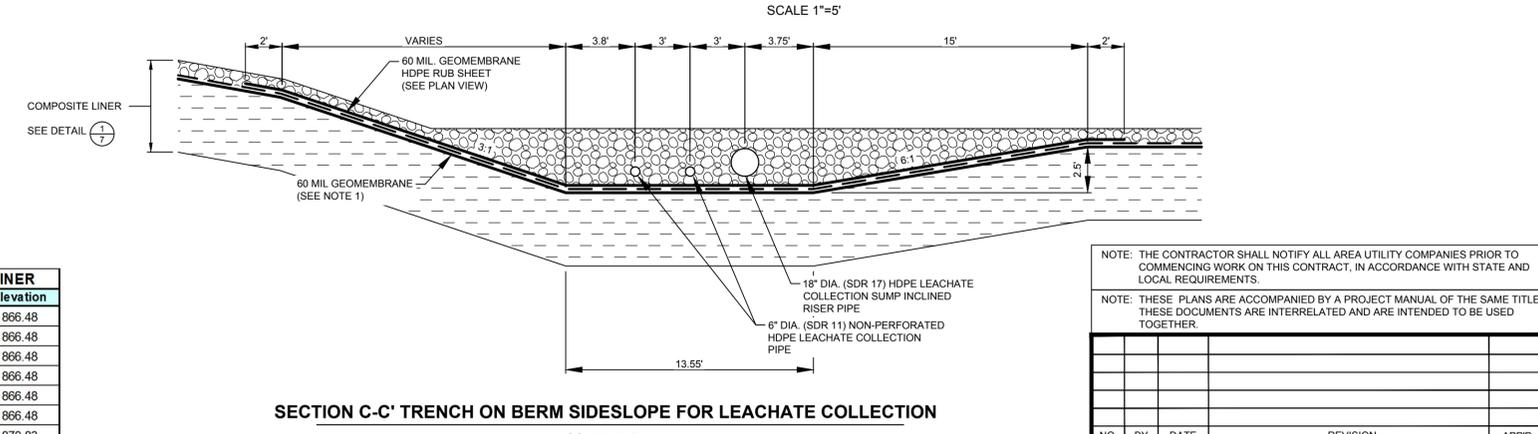
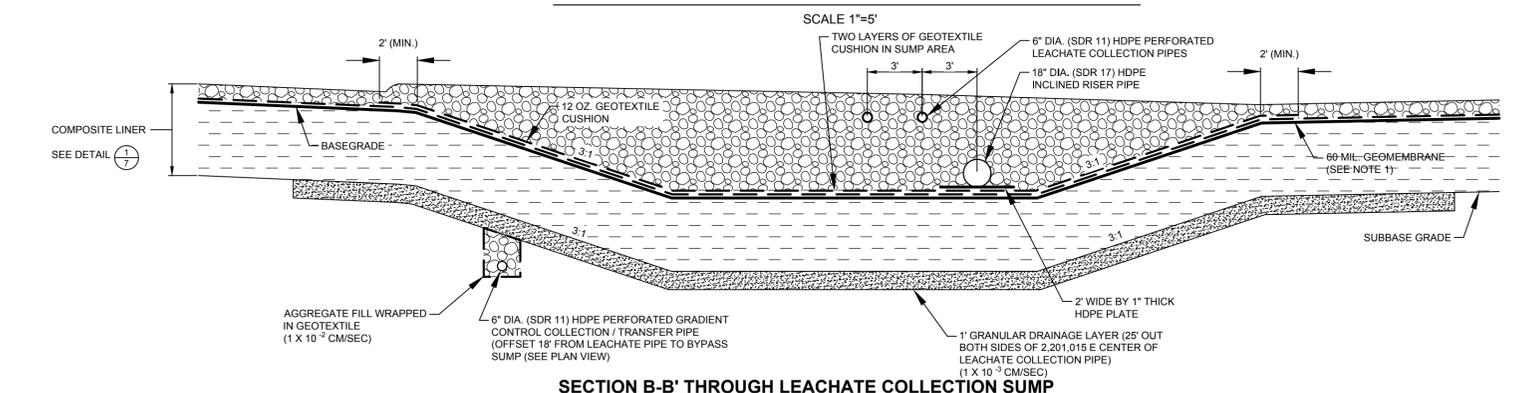
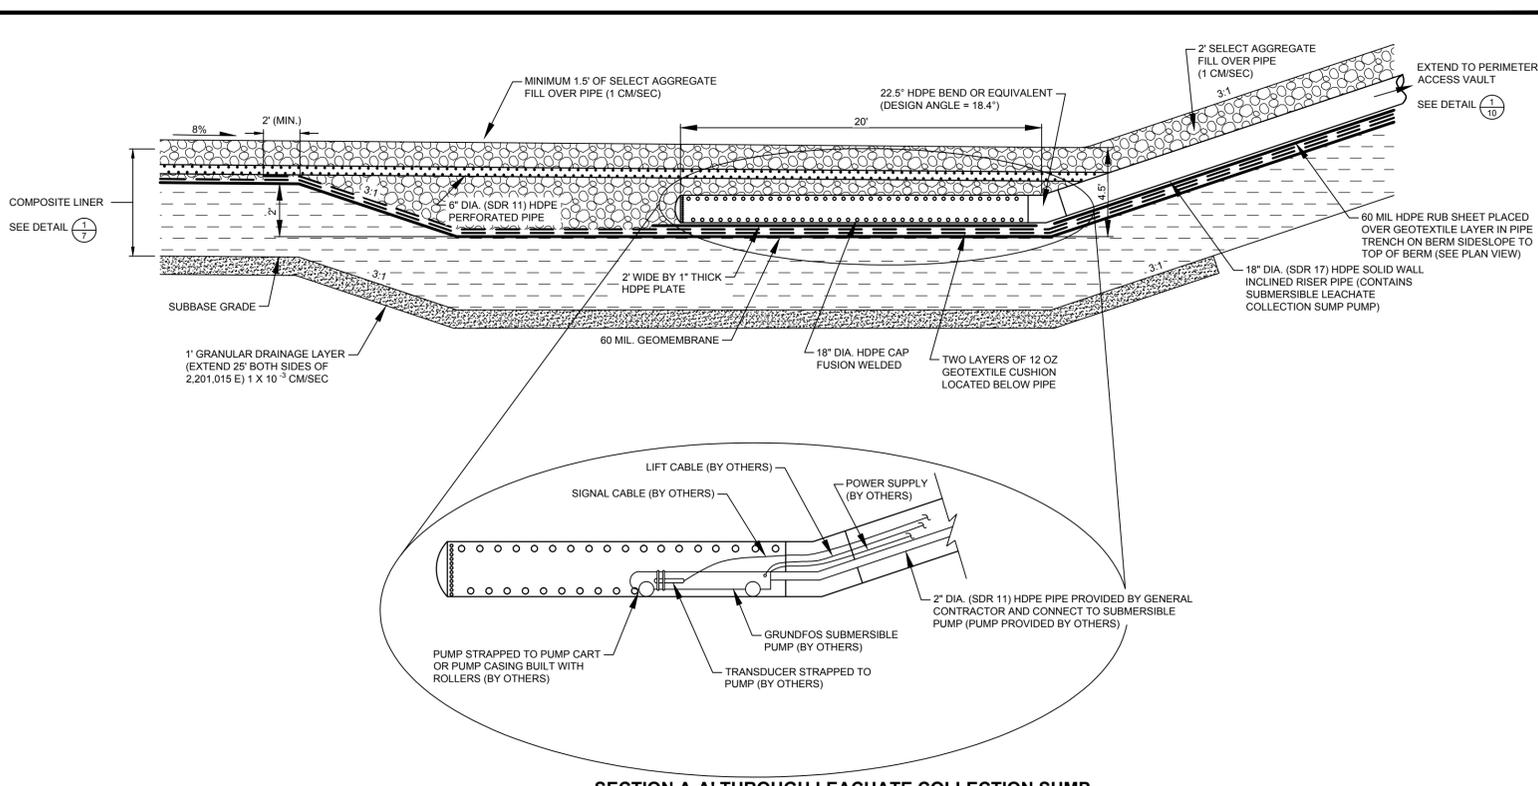
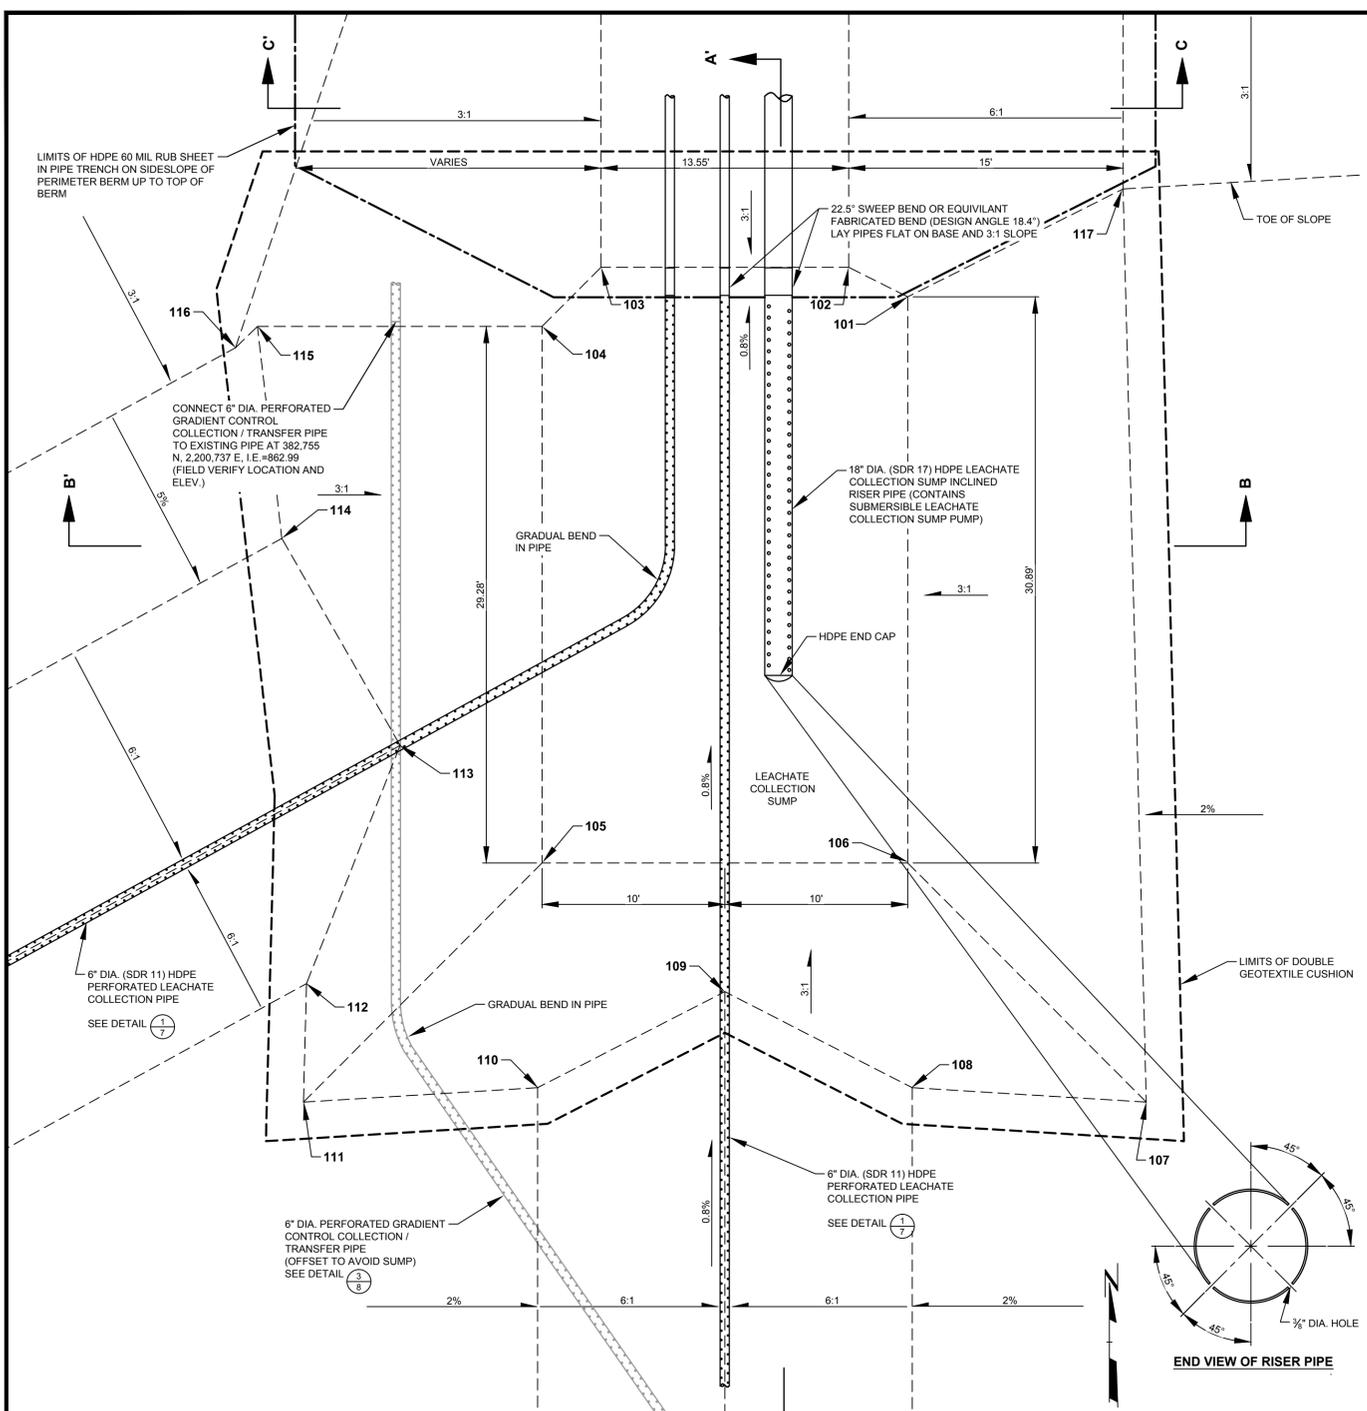
PROJECT: **DANE COUNTY NO. 2 (RODEFELD) LANDFILL PHASE 10 - CELL 1 LINER CONSTRUCTION DANE COUNTY, WISCONSIN**

SHEET TITLE: **DETAILS - LEACHATE VAULT AND LEACHATE COLLECTION**

DRAWN BY: RNOLDEN	SCALE: AS SHOWN	PROJ. NO.: 224310.0000.0000
CHECKED BY: DM	DATE PRINTED: JUNE 2015	FILE NO.: 224310.SHT08-DT.dwg
APPROVED BY: CDM	DATE: JUNE 2015	SHEET 8 OF 14

TRC 708 Heartland Trail Suite 3000 Madison, WI 53717 Phone: 608.828.3600

J:\Dane County\1224310 - P10\CT Liner\Cont\00002310.SHT08-DT.dwg
 Drawing Name: NCLDEN_RANDY
 File Size: 154 Mb
 Drawing Date: Jun 15, 2015
 Plot Date: Jun 15, 2015
 Plot Time: 10:10 AM
 SHEET 8



LINE AND SHADING LEGEND

60 MIL. HDPE GEOMEMBRANE	GEOCOMPOSITE
GEOTEXTILE	60 MIL. HDPE GEOMEMBRANE RUB SHEET
LIMITS OF DOUBLE GEOTEXTILE CUSHION IN SUMP AREA	
TOPSOIL	NATIVE SOIL
GENERAL FILL	CONCRETE
SELECT GRANULAR FILL	RIPRAP
BARRIER LAYER FINE GRADED SOIL	BITUMINOUS PAVING
SELECT AGGREGATE FILL	SELECT FOUNDRY BYPRODUCT
COMPACTED SELECT CLAY FILL	

PHASE 10 - CELL 1 SUMP COORDINATES

PHASE 10 - CELL 1 BOTTOM OF CLAY LINER				PHASE 10 - CELL 1 TOP OF CLAY LINER			
Point No.	Northing	Eastng	Elevation	Point No.	Northing	Eastng	Elevation
101	382,756.4	2,200,765.0	862.48	101	382,756.4	2,200,765.0	866.48
102	382,758.0	2,200,761.8	862.48	102	382,758.0	2,200,761.8	866.48
103	382,758.0	2,200,748.2	862.48	103	382,758.0	2,200,748.2	866.48
104	382,754.7	2,200,745.0	862.48	104	382,754.7	2,200,745.0	866.48
105	382,725.5	2,200,745.0	862.48	105	382,725.5	2,200,745.0	866.48
106	382,725.5	2,200,765.0	862.48	106	382,725.5	2,200,765.0	866.48
107	382,712.4	2,200,778.0	866.83	107	382,712.4	2,200,778.0	870.83
108	382,713.2	2,200,765.2	866.56	108	382,713.2	2,200,765.2	870.56
109	382,718.4	2,200,755.0	864.82	109	382,718.4	2,200,755.0	868.82
110	382,713.2	2,200,744.8	866.56	110	382,713.2	2,200,744.8	870.56
111	382,712.4	2,200,732.0	866.83	111	382,712.4	2,200,732.0	870.83
112	382,718.9	2,200,732.1	866.77	112	382,718.9	2,200,732.1	870.77
113	382,731.9	2,200,737.2	865.06	113	382,731.9	2,200,737.2	869.06
114	382,743.2	2,200,730.8	867.22	114	382,743.2	2,200,730.8	871.22
115	382,754.7	2,200,729.4	867.67	115	382,754.7	2,200,729.4	871.67
116	382,753.6	2,200,728.2	867.68	116	382,753.6	2,200,728.2	871.68
117	382,762.2	2,200,776.8	866.40	117	382,762.2	2,200,776.8	870.40




LEACHATE COLLECTION SUMP FOR PHASE 10 - CELL 1
SCALE 1"=5'

NOTE: THE CONTRACTOR SHALL NOTIFY ALL AREA UTILITY COMPANIES PRIOR TO COMMENCING WORK ON THIS CONTRACT, IN ACCORDANCE WITH STATE AND LOCAL REQUIREMENTS.

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NO.	BY	DATE	REVISION	APP'D.
PROJECT: DANE COUNTY NO. 2 (RODEFELD) LANDFILL				
PHASE 10 - CELL 1 LINER CONSTRUCTION				
DANE COUNTY, WISCONSIN				
SHEET TITLE: DETAILS - LEACHATE COLLECTION SUMP				
DRAWN BY: RNOLDEN	SCALE: AS SHOWN	PROJ. NO. 224310.0000.0000		
CHECKED BY: DM	DATE PRINTED: JUNE 2015	FILE NO. 224310.SHT09-DT.dwg		
APPROVED BY: CDM	SHEET 9 OF 14			
DATE: JUNE 2015				

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 NOLDER, RANDY
 Drawing Size: 101.15 x 2015
 Sheet: 9
 Date: 06/15/2015
 PLOT DATE: 06/15/2015

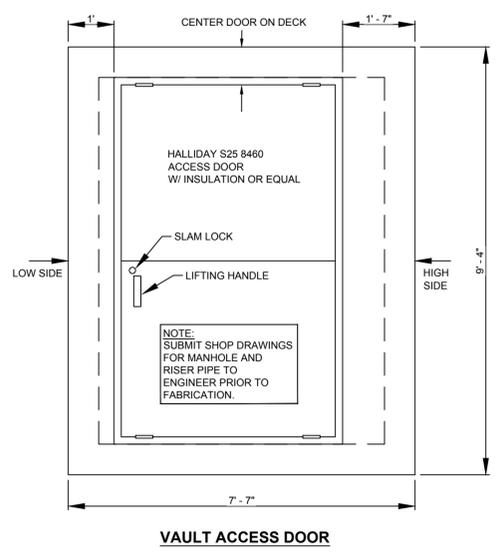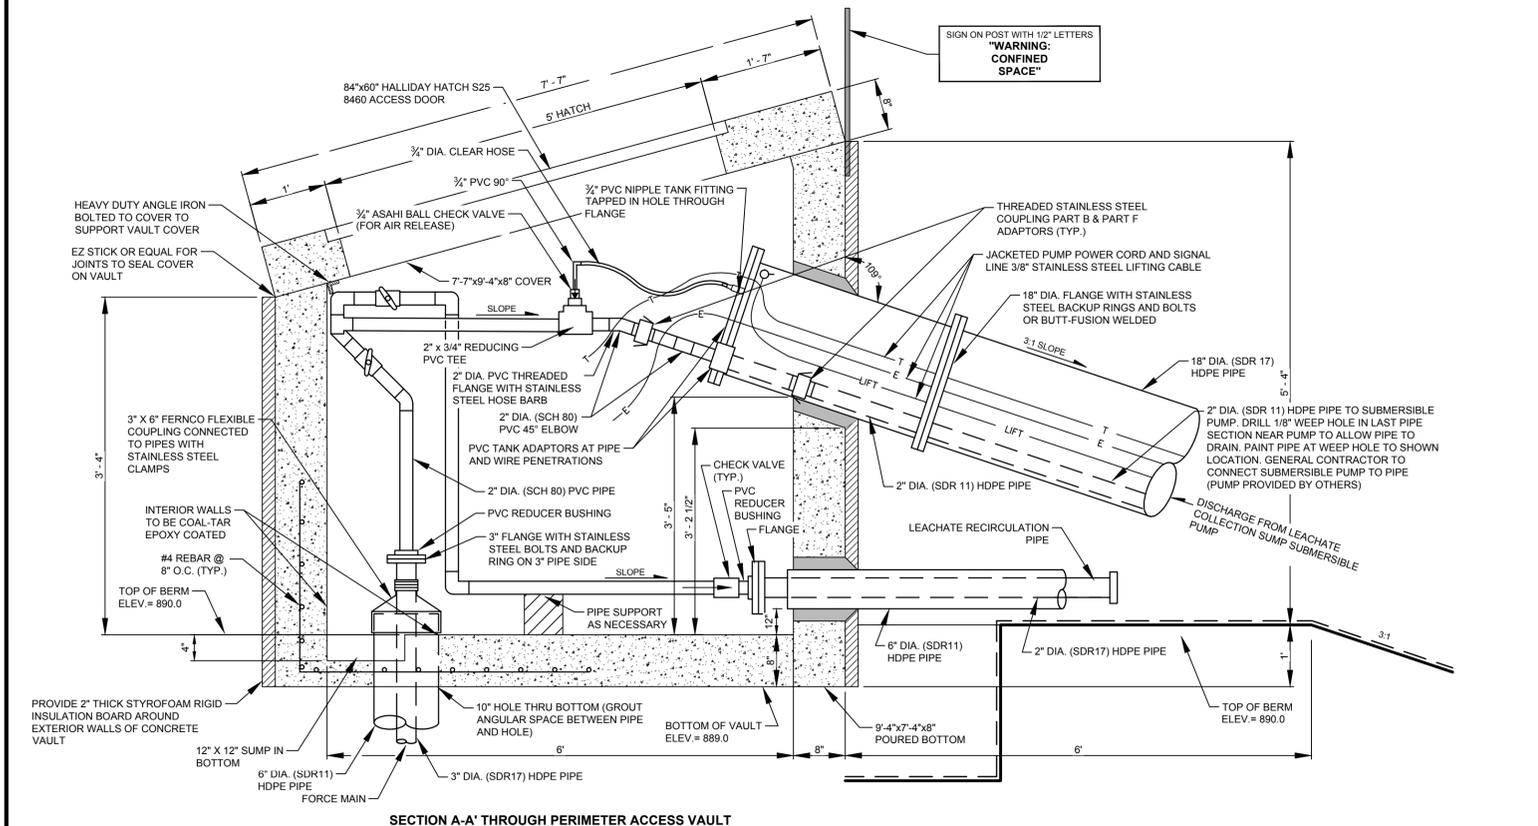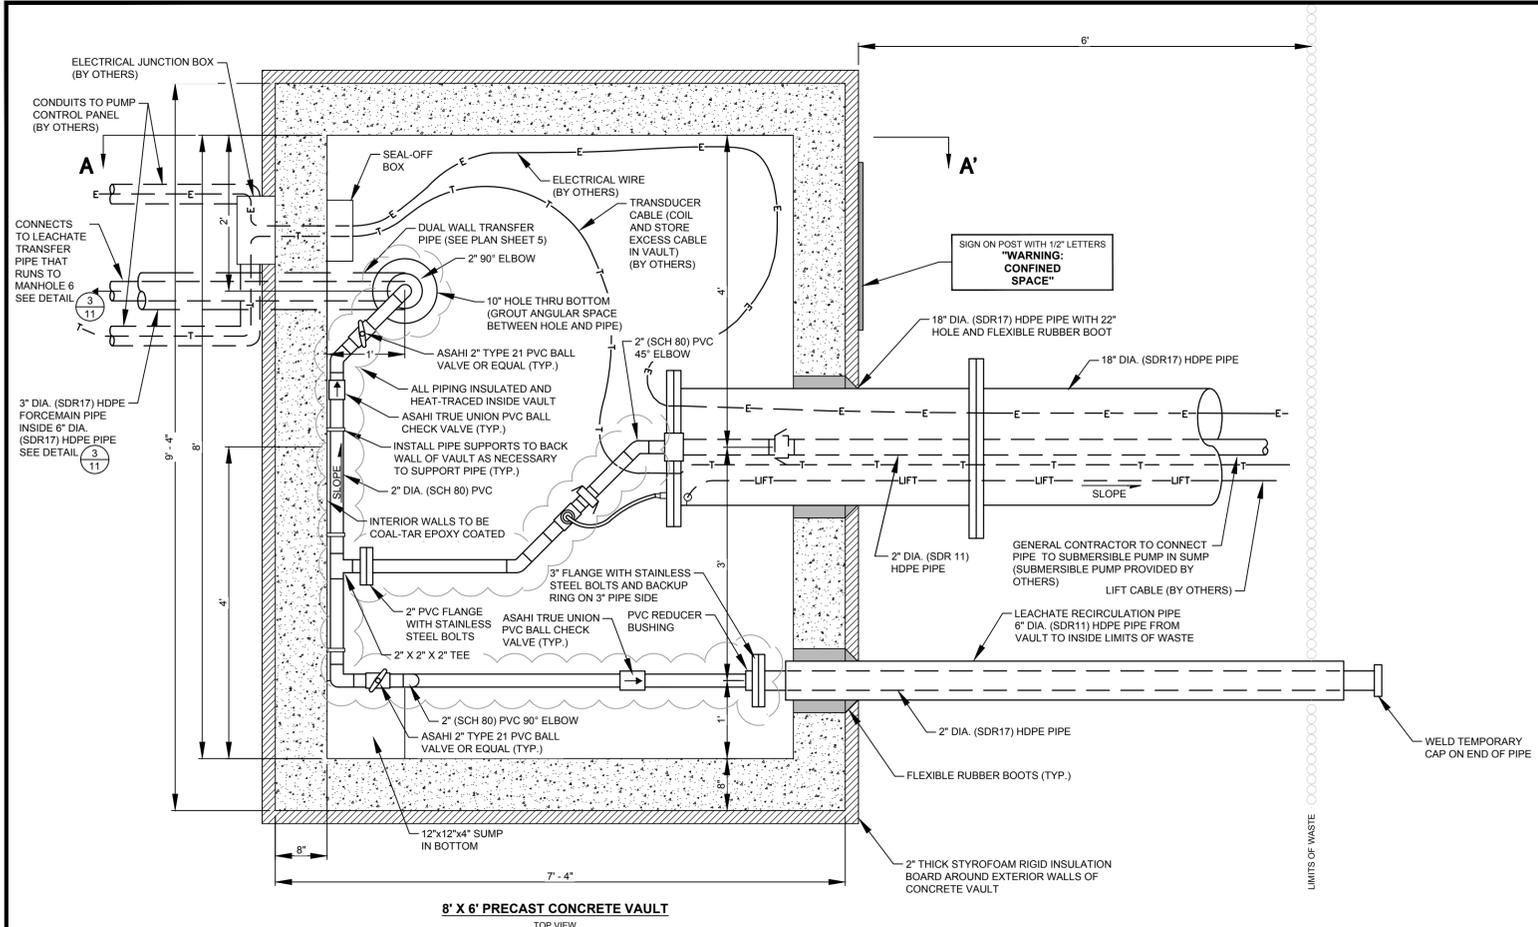


LINE AND SHADING LEGEND			
	60 MIL HDPE GEOMEMBRANE		GEOCOMPOSITE
	GEOTEXTILE		
	TOPSOIL		NATIVE SOIL
	GENERAL FILL		CONCRETE
	SELECT GRANULAR FILL		RIPRAP
	BARRIER LAYER FINE GRADED SOIL		BITUMINOUS PAVING
	SELECT AGGREGATE FILL		SELECT FOUNDRY BYPRODUCT
	COMPACTED SELECT CLAY FILL		

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NO.	BY	DATE	REVISION	APP'D.
PROJECT: DANE COUNTY NO. 2 (RODEFELD) LANDFILL PHASE 10 - CELL 1 LINER CONSTRUCTION DANE COUNTY, WISCONSIN				
SHEET TITLE: DETAILS - TIE-IN TO EXISTING LEACHATE TRANSFER SYSTEM				
DRAWN BY:	RNOLDEN	SCALE:	AS SHOWN	PROJ. NO. 224310.0000.0000
CHECKED BY:	DM	DATE PRINTED:		FILE NO. 224310.SHT10-DT.dwg
APPROVED BY:	CDM			SHEET 10 OF 14
DATE:	JUNE 2015			

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 Sheet: 10




NOTES:
 SCREENED INFORMATION REPRESENTS EXISTING FINAL COVER.
 BOLD INFORMATION REPRESENTS FEATURES INSTALLED DURING LINER CONSTRUCTION

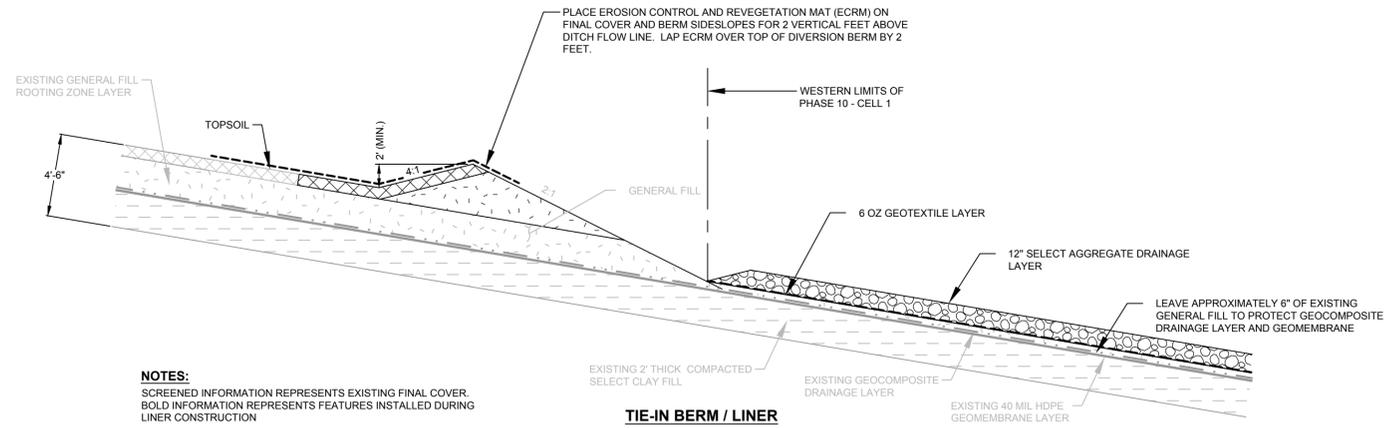TIE-IN BERM / LINER

TEMPORARY PERIMETER BERM AT WESTERN LIMITS OF PHASE 10 - CELL 1

(AS SHOWN)

1
11

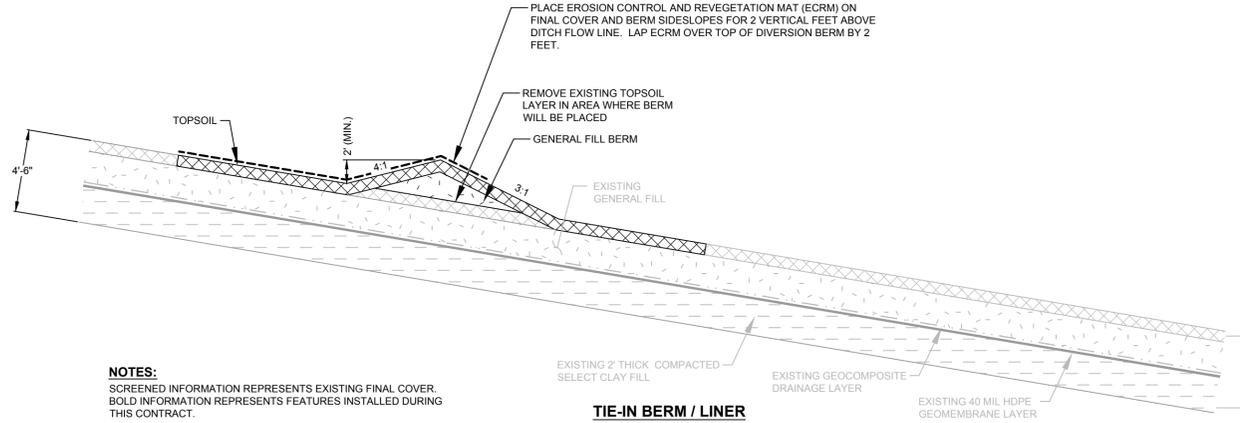


NOTES:
 SCREENED INFORMATION REPRESENTS EXISTING FINAL COVER.
 BOLD INFORMATION REPRESENTS FEATURES INSTALLED DURING THIS CONTRACT.

TIE-IN BERM / LINER

TEMPORARY DIVERSION BERM OVER EXISTING FINAL COVER

(NOT TO SCALE)

2
11

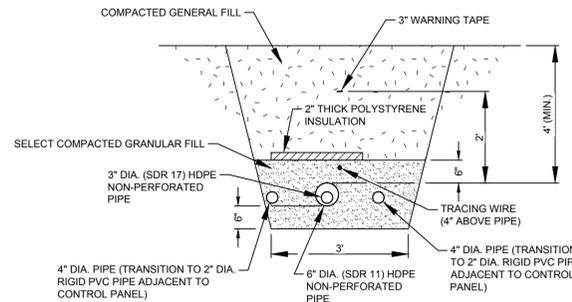


NOTE:
 4" DIA. CONDUIT INSTALL BY LANDFILL CONTRACTOR. ELECTRICAL WIRE AND TRANSDUCER WIRE INSTALLED BY OTHERS.

ELECTRIC CONDUIT/LEACHATE PIPE FROM VAULT TO EXISTING FORCE MAIN PIPE

(NOT TO SCALE)

3
11

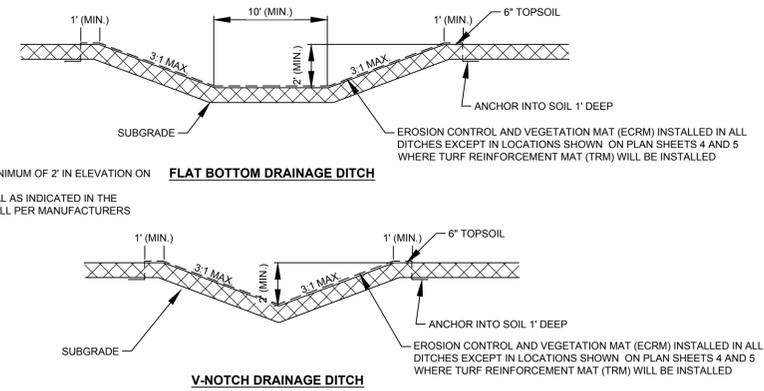

NOTES:

1. INSTALL ECRM AND TRM A MINIMUM OF 2' IN ELEVATION ON SIDE SLOPES OF DITCHES.
2. USE ECRM AND TRM MATERIAL AS INDICATED IN THE PROJECT MANUAL AND INSTALL PER MANUFACTURERS RECOMMENDATIONS.

FLAT BOTTOM DRAINAGE DITCH

V-NOTCH DRAINAGE DITCH

PERIMETER DRAINAGE DITCH (TYP.)

(NOT TO SCALE)

4
11

LINE AND SHADING LEGEND

	60 MIL HDPE GEOMEMBRANE		GEOCOMPOSITE
	GEOTEXTILE		TOPSOIL
	NATIVE SOIL		GENERAL FILL
	CONCRETE		SELECT GRANULAR FILL
	RIPRAP		BARRIER LAYER FINE GRADED SOIL
	BITUMINOUS PAVING		SELECT AGGREGATE FILL
	SELECT FOUNDRY BYPRODUCT		COMPACTED SELECT CLAY FILL

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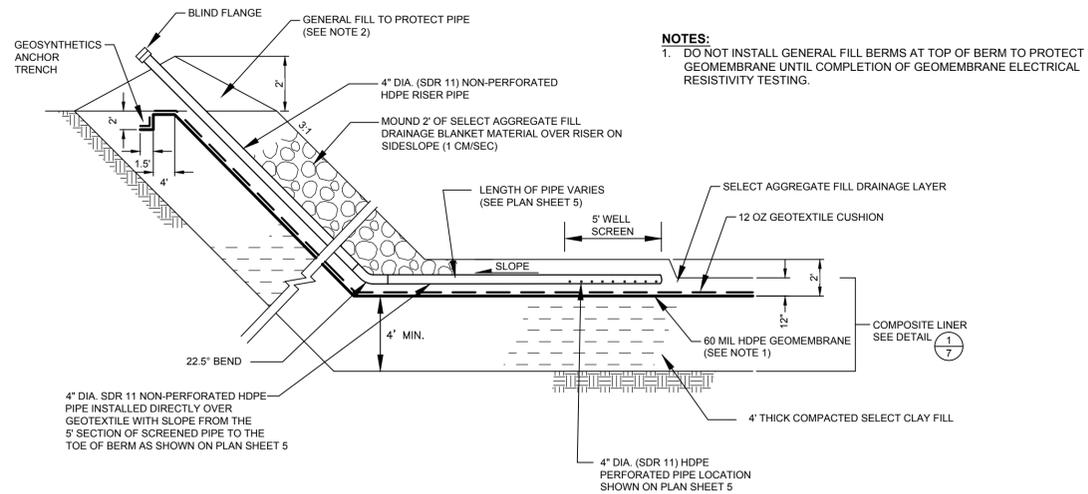
NO.	BY	DATE	REVISION	APPD.

PROJECT: **DANE COUNTY NO. 2 (RODEFELD) LANDFILL PHASE 10 - CELL 1 LINER CONSTRUCTION DANE COUNTY, WISCONSIN**


SHEET TITLE: **DETAILS - MISCELLANEOUS**

DRAWN BY: RNOLDEN	SCALE: AS SHOWN	PROJ. NO. 224310.0000.0000
CHECKED BY: DM	DATE PRINTED: JUNE 2015	FILE NO. 224310.SHT11-DT.dwg
APPROVED BY: CDM	DATE: JUNE 2015	SHEET 11 OF 14


TRC
 708 Heartland Trail
 Suite 3000
 Madison, WI 53717
 Phone: 608.826.3600




1
12 **LEACHATE HEADWELL (TYP.)**
NOT TO SCALE

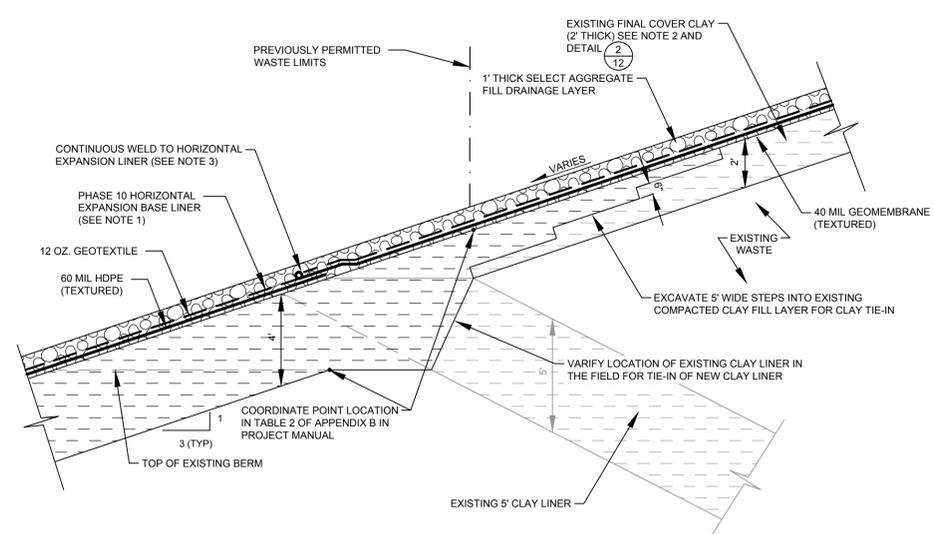

4
12 **COMPOSITE LINER ANCHOR TIE-IN TO EXISTING LANDFILL**
NOT TO SCALE

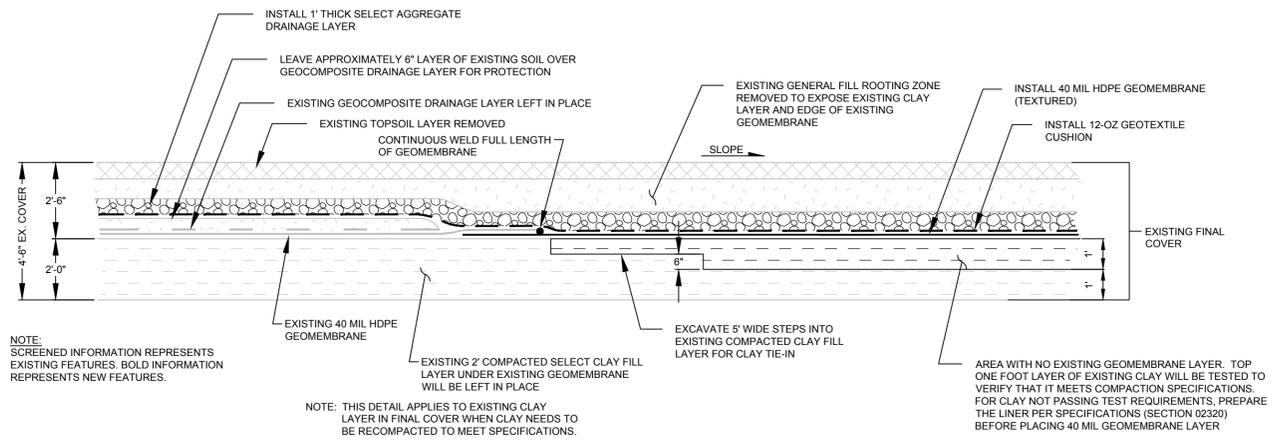

2
12 **LINER SPLICE IN EXISTING FINAL COVER AT JUNCTION OF NEW AND OLD GEOMEMBRANE**
NOT TO SCALE

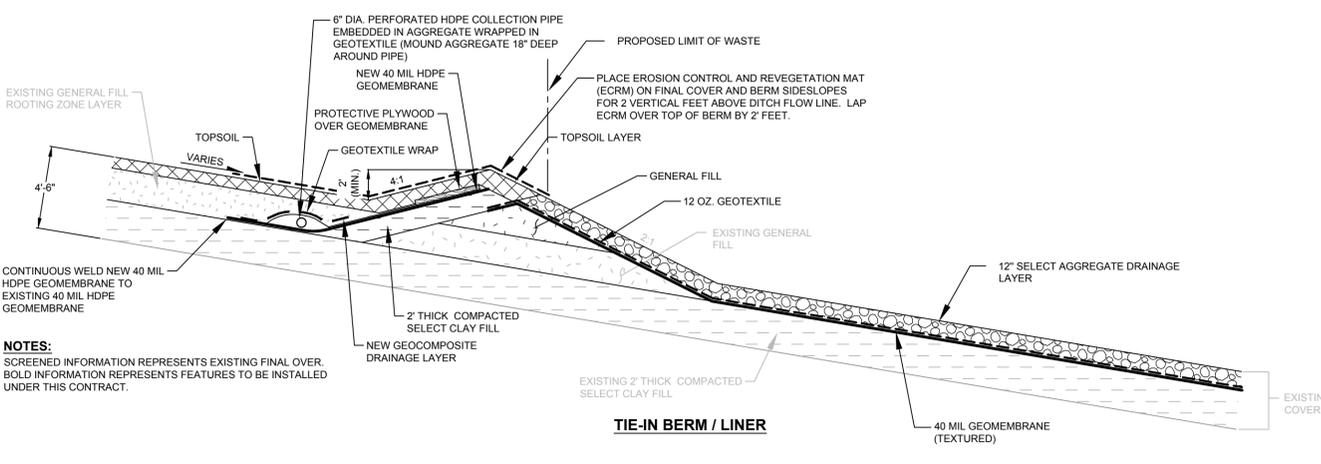

3
12 **TIE-IN PERIMETER BERM ALONG LIMITS OF WASTE LINE FOR VERTICAL EXPANSION**
SCALE: 1" = 5'

- NOTES**
- HORIZONTAL EXPANSION AREA - REMOVE TOPSOIL AND GENERAL FILL FROM SIDESLOPE OF EXISTING LANDFILL BERM TO THE SUBBASE GRADES SHOWN ON PLAN SHEET 4 AND PLACE MINIMUM 4" COMPOSITE LINER.
 - VERTICAL EXPANSION AREA - REMOVE TOPSOIL AND GENERAL FILL FROM EXISTING FINAL COVER (SEE NOTES A AND B ON PLAN SHEETS 4 AND 5). LEAVE APPROXIMATELY 6" THICK LAYER OF GENERAL FILL OVER EXISTING GEOMEMBRANE IN AREA IDENTIFIED AS A. IN AREA WITH NO GEOMEMBRANE, IDENTIFIED AS AREA B, VERIFY EXISTING 2" THICK CLAY LAYER MEETS COMPACTION REQUIREMENTS PER SPECIFICATIONS OR RECOMPACT TO SPECIFICATION REQUIREMENTS (SECTION 02320).
 - PLACE 60 MIL. GEOMEMBRANE OVER 4" THICK CLAY HORIZONTAL EXPANSION LINER AND 40 MIL. GEOMEMBRANE OVER 2" THICK CLAY VERTICAL EXPANSION LINER. CONTINUOUS WELD 40 MIL. TO 60 MIL. GEOMEMBRANE ENTIRE LENGTH OF PHASE.
 - PLACE 12 OZ. GEOTEXTILE AND 1" THICK SELECT AGGREGATE DRAINAGE LAYER OVER HORIZONTAL EXPANSION AND ON VERTICAL OVER-LAP OF EXISTING SITE LANDFILL.
 - BOLD INFORMATION REPRESENTS NEW LINER SYSTEM. SCREENED INFORMATION REPRESENTS EXISTING LINER AND FINAL COVER.

LINE AND SHADING LEGEND

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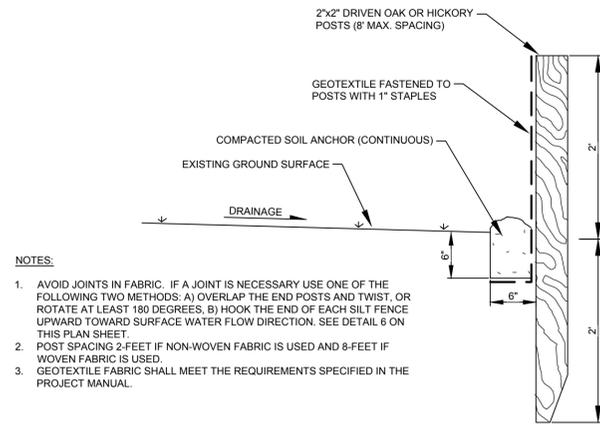
PROJECT: **DANE COUNTY NO. 2 (RODEFELD) LANDFILL PHASE 10 - CELL 1 LINER CONSTRUCTION DANE COUNTY, WISCONSIN**

SHEET TITLE: **DETAILS - MISCELLANEOUS**

DRAWN BY: RNOLDEN	SCALE: AS SHOWN	PROJ. NO. 224310.0000.0000
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APPROVED BY: CDM	DATE: JUNE 2015	SHEET 12 OF 14

TRC 708 Heartland Trail Suite 3000 Madison, WI 53717 Phone: 608.826.3600


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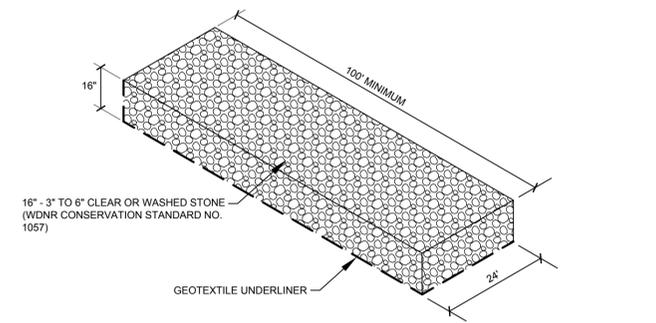
1. AVOID JOINTS IN FABRIC. IF A JOINT IS NECESSARY USE ONE OF THE FOLLOWING TWO METHODS: A) OVERLAP THE END POSTS AND TWIST, OR ROTATE AT LEAST 180 DEGREES, B) HOOK THE END OF EACH SILT FENCE UPWARD TOWARD SURFACE WATER FLOW DIRECTION. SEE DETAIL 6 ON THIS PLAN SHEET.
2. POST SPACING 2- FEET IF NON-WOVEN FABRIC IS USED AND 8- FEET IF WOVEN FABRIC IS USED.
3. GEOTEXTILE FABRIC SHALL MEET THE REQUIREMENTS SPECIFIED IN THE PROJECT MANUAL.

CROSS SECTION VIEW




JOINING TWO LENGTHS OF SILT FENCE

1
14 **EROSION CONTROL FENCE**
(INSTALLED BY OTHERS MAINTAINED BY CONTRACTOR)
(NOT TO SCALE)

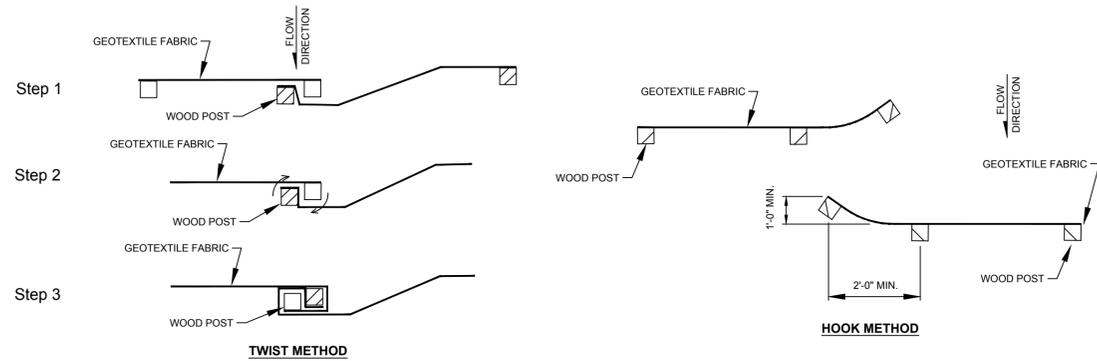



2
14 **STONE TRACKING PAD**
(NOT TO SCALE)

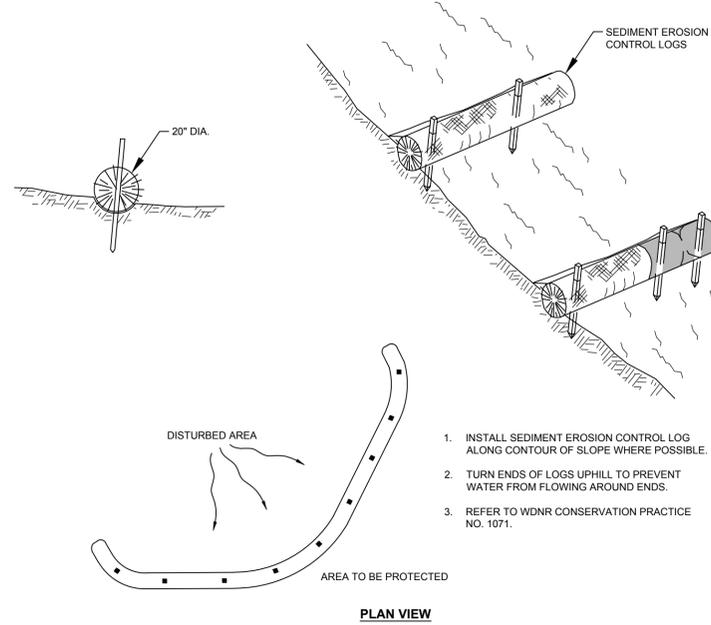

1. INSTALL SEDIMENT EROSION CONTROL LOG ALONG CONTOUR OF SLOPE WHERE POSSIBLE.
2. TURN ENDS OF LOGS UPHILL TO PREVENT WATER FROM FLOWING AROUND ENDS.
3. REFER TO WDNR CONSERVATION PRACTICE NO. 1071.

PLAN VIEW


SOIL STOCKPILE CROSS SECTION

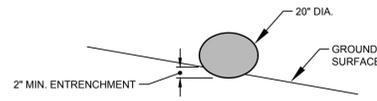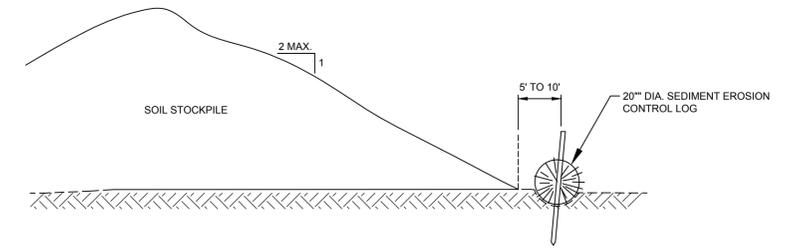


NOTE:

1. INSTALLED HEIGHT IS MEASURED FROM THE UPSLOPE GROUND SURFACE TO THE TOP OF THE PRODUCT. DUE TO SETTLEMENT AND/OR DEFORMATION, THE INSTALLED HEIGHT MAY NOT BE EQUIVALENT TO THE NOMINAL DIAMETER OF THE PRODUCT.

CROSS SECTION

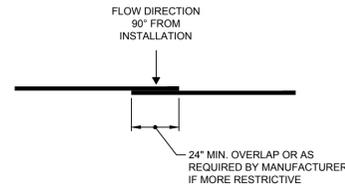

TYPICAL INSTALLATION
(PLAN VIEW)

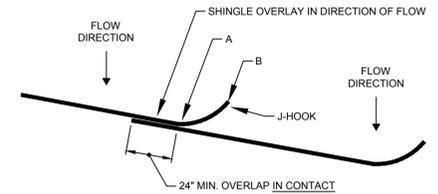


NOTES:

1. J-HOOKS SHALL BE INSTALLED SO THAT THE GROUND-PRODUCT INTERFACE ELEVATION AT LOCATION B IS HIGHER THAN THE TOP OF PRODUCT ELEVATION AT LOCATION A TO CREATE A WEIR AT POINT A.
2. J-HOOKS SHALL BE INSTALLED EVERY 2 VERTICAL FEET OF DROP ALONG THE LENGTH OF INSTALLATION.
3. STAKE OVERLAP AS REQUIRED BY MANUFACTURER.

SLOPING INSTALLATION
(PLAN VIEW)

3
14 **SEDIMENT EROSION CONTROL LOGS**
(INSTALLED BY OTHERS MAINTAINED BY CONTRACTOR)
(NOT TO SCALE)

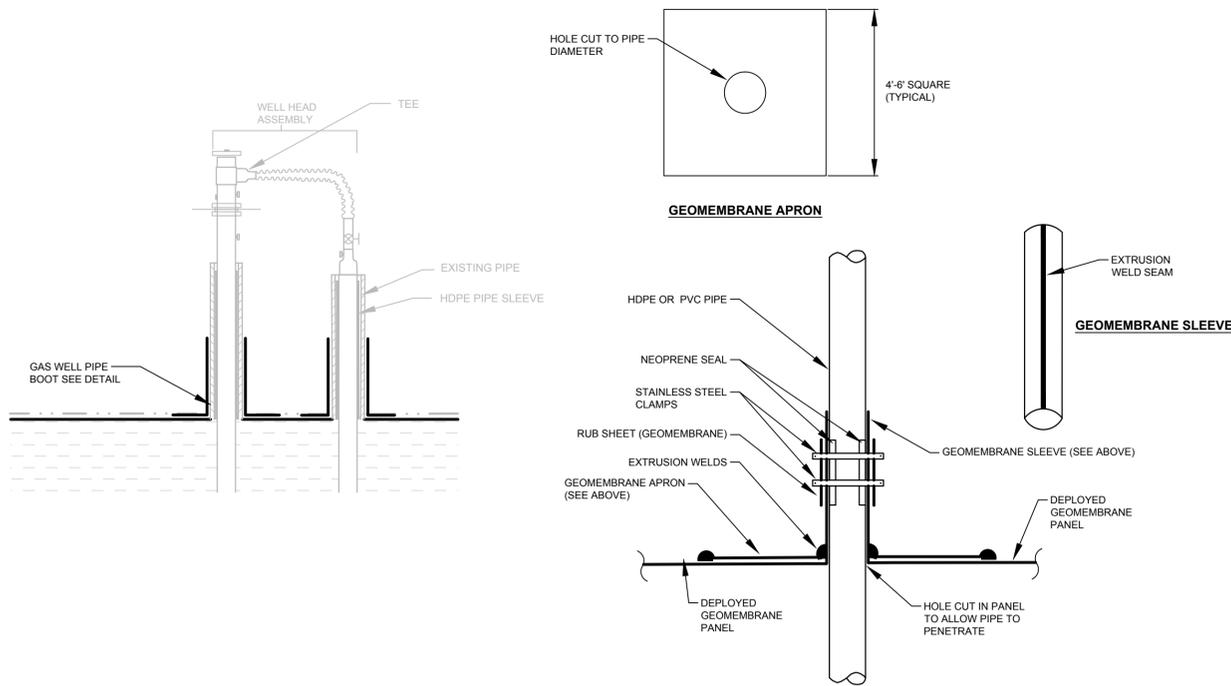

4
14 **GAS PIPE BOOT (TYPICAL)**
(NOT TO SCALE)

LINE AND SHADING LEGEND			
	60 MIL HDPE GEOMEMBRANE		GEOCOMPOSITE
	GEOTEXTILE		TOPSOIL
	NATIVE SOIL		CONCRETE
	GENERAL FILL		RIPRAP
	SELECT GRANULAR FILL		BITUMINOUS PAVING
	BARRIER LAYER FINE GRADED SOIL		SELECT FOUNDRY BYPRODUCT
	SELECT AGGREGATE FILL		COMPACTED SELECT CLAY FILL

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PROJECT: **DANE COUNTY NO. 2 (RODEFELD) LANDFILL**
PHASE 10 - CELL 1 LINER CONSTRUCTION
DANE COUNTY, WISCONSIN

SHEET TITLE: **DETAILS - EROSION CONTROL**

DRAWN BY: RNOLDEN	SCALE: AS SHOWN	PROJ. NO. 224310.0000.0000
CHECKED BY: DM	DATE PRINTED: JUNE 2015	FILE NO. 224310.SHT14-DT.dwg
APPROVED BY: CDM	DATE: JUNE 2015	SHEET 14 OF 14

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